

APPLICATION FOR SPECIAL USE APPROVAL

353 North 120th Avenue · Holland, MI 49424 · Phone: 616.395.0151 · Fax: 616.396.2537

Applicant Information		
Contact Name Jason Hall	Company	Midwest Construction Group
Address 8516 Homestead Drive, Suite 102	Phone	(616) 405-1856
Zeeland, MI 49464	Fax / Email	jhall@midwestbuilt.com
Owner Information		
Contact Name Eric Heitman	Company	Heitman Properties LLC
Address 2691 120th Ave	Phone	616-218-2283
Holland MI 49424	Fax / Email	ericheitmandvm@gmail.com
Plan Preparer Information		
Contact Name John M. Tenpas	Company	Driesenga & Associates, Inc.
Address 12330 James Street, Suite H80	Phone	(616) 396-0255
Holland, MI 49424	Fax / Email	johnt@driesenga.com
Property Information		
Address or Location 2691 120th Avenue, Holland, ML4	19424	
Parcel Number 70 - 16 - <u>16</u> - <u>400</u> - <u>076</u>	Zoning Distr	ict C-2 Community Commercial
Present Use(s) Veterinary Clinic and Animal Hospital		
Description of Special Use (attach additional pages as needed):		
Expansion of existing veterinary use. Proposed but	uilding addi	tion will be 2,385 sft.
Existing parking will be partially demolished and n	ew parking	constructed, with a net increase
of 21 spaces. Fenced area north of the building fo	r pet relief	area.
The undersigned does hereby request a public hearing before consideration of Special Use approval.	the Holland (Charter Township Planning Commission for
tonoration of Special Coo approved		

A hearing fee of \$350.00 shall be submitted with eleven (11) complete copies of: this form, the site plan review requirements list including a response to each item listed, and the site plan including an electronic copy of the site plan on CD or other file sharing device.

Site plans required for Special Use consideration <u>MUST</u> be submitted with this form. Applications submitted without the required site plans shall not be accepted. The copies must be submitted to the Zoning Administrator no later than four (4) weeks prior to the hearing date.

NOTE: You are required to be present at the hearing to present your application. You will be notified as to date and time. Your neighbors within 300 feet will also be notified concerning this hearing.

Property Owner's Certification

I, the undersigned owner of the above-described property, certify that I understand conditions and restrictions may be placed upon this special use approval as deemed necessary by the Holland Charter Township Planning Commission and hereby agree to conform to and abide by any and all such conditions and restrictions.

I, acknowledge there are Specific Special Land Use Approval Standards in addition to those outlined in Section 15.3 (below) that apply to the following uses and by selecting a use below further acknowledge they have reviewed the associated standards and have addressed each of them in this submittal:

Special Use – Earth-sheltered Building
Special Use – Mineral Extraction
Special Use – Wireless Communications

I further agree to authorize members of the Planning Commission and representatives from the Holland Charter Township Building Department to enter my property in order to review the particulars of my request.


Signature of Applicant

Date

n /teitman 9/30/24

Section 15.3 - General Standards of Approval. The Planning Commission shall review the particular circumstances and facts applicable to each proposed special land use with respect to the following standards:

- The use is designed and constructed, and will be operated and maintained to be harmonious and appropriate in appearance with the existing or intended character of the general vicinity; will be compatible with adjacent uses of land; and will not change the essential character of the area in which it is proposed.
- The use is, or as a result of the special land use approval, will be served adequately by public services and facilities, including, but not limited to, streets, police and fire protection, drainage structures, refuse disposal, water and sewer facilities, and schools.
- The use will not involve activities, processes, materials and equipment or conditions of operation that will be detrimental to any persons, property or the general welfare due to traffic, noise, smoke, fumes, glare, vibration, or odors.
- The special land use will be consistent with the intent and purposes of this ordinance and the most recent updates to the Holland Charter Township Comprehensive Plan.
- It will not be hazardous or disturbing to existing or future uses in the same general vicinity and in the community as a whole.
- It will not create excessive additional requirements at public cost for infrastructure and will not be detrimental to the economic welfare of the community.
- It will ensure that the environment shall be preserved in its natural state, insofar as practicable, by minimizing tree and soil removal and topographic modifications, which result in maximum harmony with adjacent areas.
- It shall conform with all specific requirements applicable to the proposed use, as applicable.
- The use will not result in traffic congestion, nor have an adverse impact on roads, nor cause hazards.
- 10. There is need for the proposed use within the township.

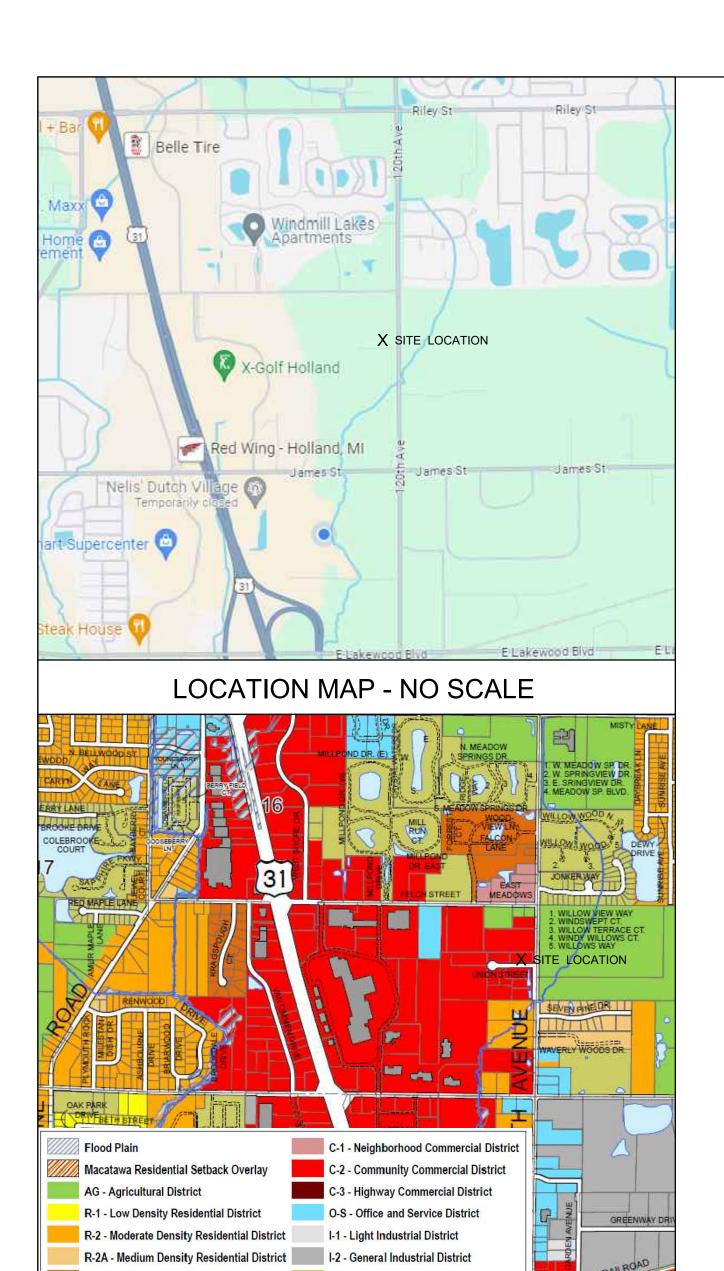

ZONING MAP - NO SCALE



SITE ADDRESS

OTTAWA ANIMAL HOSPITAL EAST 2691 120TH AVENUE HOLLAND, MI 49424

OWNER

MIDWEST CONSTRUCTION GROUP 8516 HOMESTEAD DRIVE, SUITE 102 ZEELAND, MI 49464 (616)772-6070 JOE WOLDRING jwoldring@midwestbuilt.com

CIVIL ENGINEER

DRIESENGA & ASSOCIATES, INC. 12330 JAMES STREET, SUITE H80 HOLLAND, MICHIGAN 49424 JOHN TENPAS, P.E.

johnt@driesenga.com

MIDWEST CONSTRUCTION GROUP OTTAWA ANIMAL HOSPITAL EAST

2691 120TH AVENUE SECTION 16, T05N, R15W HOLLAND, MICHIGAN 49424

SHEET INDEX

G-001 TITLE SHEET

V-101 EXISTING TOPOGRAPHIC PLAN


CD-101 CIVIL DEMOLITION PLAN

C-101 SITE PLAN

STORM SEWER, GRADING AND SOIL EROSION CONTROL PLAN C-102

L-101 LANDSCAPE PLAN

C-501 DETAILS

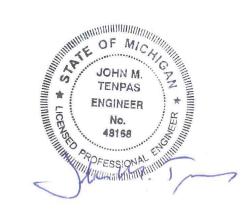

ISSUED FOR **APPROVAL**

DRIESENGA & ASSOCIATES, INC

Engineering Surveying Testing

www.driesenga.com Holland, MI

616-396-0255 Grand Rapids, MI

616-249-3800

Kalamazoo, MI 269-544-1455

Lansing, MI

517-889-6210

Ypsilanti, MI 734-368-9483

O

ISSUED FOR: ISSUED FOR REVIEW 04-26-2024 D: JTC C: JM 07-19-2024 D: WKT C: JM

09-10-2024 D: WKT C: JM 09-30-2024 D: WKT C: JM

JOHN TENPAS

TITLE SHEET

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TOPOGRAPHIC / BOUNDARY SURVEY BENCHMARK DATA SCHEDULE "A" LEGAL DESCRIPTION STORM SANITARY SCHEDULE B-II EXCEPTIONS NAVD '88 AS DERIVED FROM GPS OBSERVATIONS UTILIZING M.D.O.T. CORS GEOID 18 FROM: TRANSNATION TITLE AGENCY OF MICHIGAN LAKESHORE DIVISION FROM: TRANSNATION TITLE AGENCY OF MICHIGAN LAKESHORE DIVISION STRUCTURE DATA STRUCTURE DATA FILE NO.: 431126LKS (EFFECTIVE DATE: FEBRUARY 29, 2024) FILE NO.: 431126LKS (EFFECTIVE DATE: FEBRUARY 29, 2024) CB#1 - 4'Ø CONCRETE CB #6 - 4'Ø CONCRETE MH-A - 4'Ø CONCRETE CUT "X" ON THE SOUTH SIDE OF CONCRETE LIGHT POLE BASE, LOCATED 34'± NORTH OF THE CENTERLINE OF RIM 616.61 PART OF THE SOUTH 1/2 OF THE NORTHEAST 1/4 OF THE SOUTHEAST 1/4 OF SECTION 16, TOWN 5 NORTH, RIGHT(S) OF WAY AND/OR EASEMENT(S) OVER SAID LAND FOR THE PURPOSES RIM 616.48 RIM 618.57 UNION STREET AND 67'± SOUTH SOUTHEAST OF THE SOUTHWEST BUILDING CORNER OF "OTTAWA ANIMAL INV (N) 12" CPE=612.51 INV (S) 12" CPE=611.78 INV (E) 8" PVC=605.57 RANGE 15 WEST, HOLLAND TOWNSHIP, OTTAWA COUNTY, MICHIGAN, DESCRIBED AS: COMMENCING AT THE SHOWN BELOW AND THE RIGHTS INCIDENTAL THERETO, AS CREATED BY A DOCUMENT: PURPOSE: BICYCLE PATH AND WALKWAY RESERVED BY: CHARTER SUMP=611.81 INV (NNW) 12" CPE=611.73 INV (W) 8" PVC=605.67 EAST 1/4 CORNER OF SAID SECTION; THENCE SOUTH 00 DEGREES 40 MINUTES 53 SECONDS WEST 660.24 FEET TOWNSHIP OF HOLLAND LIBER: 2204, PAGE: 909. (SHOWN ON DRAWING) ALONG THE EAST LINE OF SAID SECTION TO THE POINT OF BEGINNING; THENCE SOUTH 00 DEGREES 40 SUMP=611.78 BM #2 EL= 620.09' (NAVD 88) MINUTES 53 SECONDS WEST 180.00 FEET ALONG SAID EAST LINE; THENCE NORTH 89 DEGREES 19 MINUTES 10 MH #2 - 4'Ø CONCRETE MH-B - 4'Ø CONCRETE X SITE LOCATION SET RAIL ROAD SPIKE IN THE SOUTH SIDE OF UTILITY POLE, LOCATED 176'± NORTH OF THE CENTERLINE OF SECONDS WEST 363.00 FEET PARALLEL WITH THE NORTH SECTION LINE OF THE SOUTH 1/2 OF THE NORTHEAST CB #7 - 4'Ø CONCRETE RIGHT(S) OF WAY AND/OR EASEMENT(S) OVER SAID LAND FOR THE PURPOSES RIM 617.29 RIM 617.07 UNION STREET AND 87'± EAST NORTHEAST OF THE NORTHEAST BUILDING CORNER OF "OTTAWA ANIMAL INV (N) 12" CPE=611.69 1/4 OF THE SOUTHEAST 1/4 OF SAID SECTION; THENCE NORTH 00 DEGREES 40 MINUTES 53 SECONDS EAST SHOWN BELOW AND THE RIGHTS INCIDENTAL THERETO, AS CREATED BY A LEACHING BASIN INV (E) 8" PVC=603.97 180.00 FEET; THENCE SOUTH 89 DEGREES 19 MINUTES 10 SECONDS EAST 363.00 FEET ALONG THE NORTH LINE DOCUMENT: PURPOSE: PUBLIC UTILITIES LIBER: 2455, PAGE: 268. (NOT SHOWN ON INV (S) 12" CPE=611.69 RIM 615.58 INV (W) 8" PVC=604.07 INV (E) 12" CPE=611.69 INV (SSE) 12" CPE=612.80 OF THE SOUTH 1/2 OF THE NORTHEAST 1/4 OF THE SOUTHEAST 1/4 OF SAID SECTION TO THE POINT OF BM #3 EL= 618.24' (NAVD 88) TOP OF WATER=612.84 TOP OF WATER=612.80 MH-C - 4'Ø CONCRETE CUT "X" ON SOUTH SIDE OF LIGHT POLE BASE, LOCATED 110'± NORTH OF THE CENTERLINE OF UNION STREET SUMP=611.69 SUMP=611.08 COVENANTS, CONDITIONS AND RESTRICTIONS BUT OMITTING ANY COVENANTS OR RIM 617.04 AND 94'± WEST NORTHWEST OF THE SOUTHWEST BUILDING CORNER OF "OTTAWA ANIMAL HOSPITAL". RESTRICTIONS. IF ANY, INCLUDING BUT NOT LIMITED TO THOSE BASED ON RACE. EXCEPT PART OF THE SOUTHEAST 1/4 OF SECTION 16, TOWN 5 NORTH, RANGE 15 WEST, DESCRIBED AS: INV (W) 8" PVC=602.84 COMMENCING AT THE EAST 1/4 CORNER OF SECTION 16: THENCE SOUTH 00 DEGREES 28 MINUTES 57 SECONDS COLOR, RELIGION, SEX, SEXUAL ORIENTATION, FAMILIAL STATUS, MARITAL STATUS, CB #3 - 4Ø CONCRETE CB #8 - 4'Ø CONCRETE INV (S) 8" PVC=602.79 DISABILITY, HANDICAP, NATIONAL ORIGIN, ANCESTRY, OR SOURCE OF INCOME, AS EAST 807.19 FEET ALONG THE EAST LINE OF SAID SECTION; THENCE SOUTH 89 DEGREES 31 MINUTES 06 RIM 616.66 RIM 616.82 **SURVEYOR'S NOTES** INV (S) 12" CPE=612.21 INV (NW) 12" CPE=612.97 MH-D - 4'Ø CONCRETE SECONDS WEST 60.00 FEET PARALLEL WITH THE NORTH LINE OF THE SOUTH 1/2 OF THE NORTHEAST 1/4 OF SET FORTH IN APPLICABLE STATE OR FEDERAL LAWS, EXCEPT TO THE EXTENT THAT SAID COVENANT OR RESTRICTION IS PERMITTED BY APPLICABLE LAW, AS SET THE SOUTHEAST 1/4 OF SAID SECTION TO THE POINT OF BEGINNING; THENCE SOUTH 00 DEGREES 28 MINUTES SUMP=611.06 INV (NE) 15" CPE=612.97 RIM 617.69 SUMP=611.82 UTILITIES SHOWN ARE APPROXIMATE LOCATIONS DERIVED FROM ACTUAL FIELD MEASUREMENTS AND 57 SECONDS EAST 33.00 FEET; THENCE SOUTH 89 DEGREES 31 MINUTES 06 SECONDS WEST 303.00 FEET; FORTH IN THE DOCUMENT: LIBER: 4737 PAGE: 709. (SHOWN ON DRAWING) INV (NW) 6" PVC=611.19 AVAILABLE RECORDS. THIS MAP IS NOT TO BE INTERPRETED AS SHOWING EXACT LOCATIONS OR CB #4 - 4'Ø CONCRETE THENCE NORTH 00 DEGREES 28 MINUTES 57 SECONDS WEST 33.00 FEET; THENCE NORTH 89 DEGREES 31 INV (E) 6" PVC=611.14 SHOWING ALL UTILITIES IN THE AREA. RIM 616.51 CB #9 - 2'Ø CONCRETE MINUTES 06 SECONDS EAST 303.00 FEET TO THE POINT OF BEGINNING. UNABLE TO SEE PIPES RIM 616.76 **LOCATION MAP - NO SCALE** 2. NOTE TO CONTRACTORS: THREE WORKING DAYS BEFORE YOU DIG - CALL MISS DIG AT 811. AND EXCEPT PART OF THE SOUTHEAST 1/4 OF SECTION 16, TOWN 5 NORTH, RANGE 15 WEST, HOLLAND CONE OFFSET INV (SE) 12" CPE=614.28 TOP OF WATER=612.91 TOWNSHIP, OTTAWA COUNTY, MICHIGAN, DESCRIBED AS: COMMENCING AT THE EAST 1/4 CORNER OF SAID SUMP=613.86 3. CONTOUR INTERVAL = 1 FOOT. SECTION 16; THENCE SOUTH 00 DEGREES 28 MINUTES 57 SECONDS EAST 660.19 FEET ALONG THE EAST LINE SUMP=611.01 OF SAID SECTION TO THE POINT OF BEGINNING: THENCE SOUTH 00 DEGREES 28 MINUTES 57 SECONDS EAST 4. BY GRAPHIC PLOTTING ONLY, THIS PROPERTY IS IN ZONE "X" OF THE FLOOD INSURANCE RATE MAP, MH #5 - 4'Ø CONCRETE RIM 617.53 180.00 FEET ALONG SAID EAST LINE; THENCE SOUTH 89 DEGREES 31 MINUTES 06 SECONDS WEST 60.00 FEET COMMUNITY PANEL NO. 26139C0305E, WHICH BEARS AN EFFECTIVE DATE OF DECEMBER 16, 2021. ZONE "X" PARALLEL WITH THE NORTH LINE OF THE SOUTH 1/2 OF THE NORTHEAST 1/4 OF THE SOUTHEAST 1/4 OF SAID UNABLE TO OPEN RIM 617.20 AREAS DETERMINED TO BE AREAS OF MINIMAL FLOOD HAZARD. INV (N) 12" CPE=610.95 SECTION; THENCE NORTH 00 DEGREES 28 MINUTES 57 SECONDS WEST 180.00 FEET; THENCE NORTH 89 DEGREES 31 MINUTES 06 SECONDS EAST 60.00 FEET ALONG SAID NORTH LINE TO THE POINT OF BEGINNING. INV (S) 12" CPE=610.95 5. BASIS OF BEARING TAKEN FROM PREVIOUS DRIESENGA & ASSOCIATES PROJECT NUMBER 2010935.5A, INV (W) 12" CPE=610.95 TOP OF WATER=612.85 DATED JANUARY 28, 2021. 6. THE FIELD WORK WAS COMPLETED ON FEBRUARY 29, 2024. TIN: 70-16-16-400-094 120 STORAGE LLC 2731 120TH AVE 0.2'± EAST & D= N89'31'06"E 60.00' S89'41'02"E 60.00' D= S891910"E FENCE IS 3.2'+ The BUSHES SCALE: 1"=20' **LEGEND** EL=618.62 (STOOP) BENCHMARK 0.4'x2.7'x 2.7'x0.4' EL=618.66 DUMPSTER -0.4'x2.7'x_ MONUMENT FOUND 2.7'x0.4 SET CAPPED REBAR #6269 FOUND IRON CONTROL POINT C1 DESCRIBED 7 -STORM SEWER MANHOLE 1.02± ACRES ONE STORY BRICK BUILDING SSNI CATCH BASIN (44,541± SQ. FT.) ROOF DRAIN SANITARY SEWER MANHOLE CLEANOUT FIRE HYDRANT FIRE DEPARTMENT CONNECTION 2.7'x0.4' SPRINKLER CONTROL VALVI SPRINKLER HEAD VALVE (WATER & GAS) TIN: 70-16-16-446-001 2.7'x0.4' 20TF $\mathbb{E}_{\mathsf{RS}}\,\mathbb{G}_{\mathsf{RS}}\,\,\mathbb{I}_{\mathsf{RS}}\,\mathbb{F}_{\mathsf{RS}}\,\mathbb{O}_{\mathsf{RS}}$ UTILITY RISERS UTILITY POLE LIGHT POLE **GUY ANCHOR** "OTTAWA ANIMAL -HAND HOLE (ELECTRIC **ELECTRIC METER** 0 00 **SOIL BORING** HEITMAN PROPERTIES LLC FENCE LINE **OVERHEAD UTILITIES** N89°41'02"W 303.00' IGC-**GAS LINE** EXISTING WATER LINE EXISTING STORM SEWE UNION STREET CONCRETE SURFACE ORNAMENTAL BUSH 344± T MH-B INV=611.34 SOUTHEAST CORNER SEC 16, TO5N, R15W (NO CORNER MAN HOLE IN MISS DIG INFORMATION MISS DIG SURVEY TICKET # 2024021902798-000 **SURVEY CONTROL** (INCLUDES INFORMATION RECEIVED THROUGH 03/04/2024) LOCATION) Tax Parcel No.: 70-16-16-400-076 **EASTING ELEVATION** - AT&T - 02/22/2023 (MAPS PROVIDED) (ASSUMED) (NAVD 88) FOR REVIEW CCISYSTEMS - 02/20/2024 (MAPS PROVIDED) 12582.9702' 616.94' - CONSUMERS ENERGY UNDERGROUND ELECTRIC - 03/01/2024 (RESPONSE 618.79' 9127.8775' 12010.8723' RECEIVED - CLEAR) 9175.3527 12400.8809' 618.03' 9317.5044' 12543.6252' 618.61' SEMCO ENERGY GAS - 02/20/2024 (MAPS PROVIDED) 9302.1862' 618.40' 12460.5196' Know what's below. THE DESCRIPTION WAS GIVEN TO US BY THE PERSON CERTIFIED TO, OR WAS PREPARED BY US FROM INFORMATION OR DOCUMENTS GIVEN TO US BY THE - HOLLAND BPW - 02/22/2024 (MAPS PROVIDED) Call before you dig. PERSON CERTIFIED TO, AND SHOULD BE COMPARED WITH THE ABSTRACT OF TITLE OR TITLE INSURANCE POLICY FOR ACCURACY, EASEMENTS OR EXCEPTIONS. - HOLLAND CHARTER TOWNSHIP - 02/19/2024 (MAPS PROVIDED)

DRIESENGA

ASSOCIATES, INC

Engineering Surveying Testina www.driesenga.com

Holland, MI 616-396-0255 **Grand Rapids, MI** 616-249-3800 Kalamazoo, MI 269-544-1455 Lansing, MI

517-977-1019 Ypsilanti, MI 734-368-9483

ROUP MI 49464 9 ΔĬ

REVISIONS


1"=20' 03-06-2024

2410092.5A

TOPOGRAPHIC

/ BOUNDARY SURVEY

1 of 1

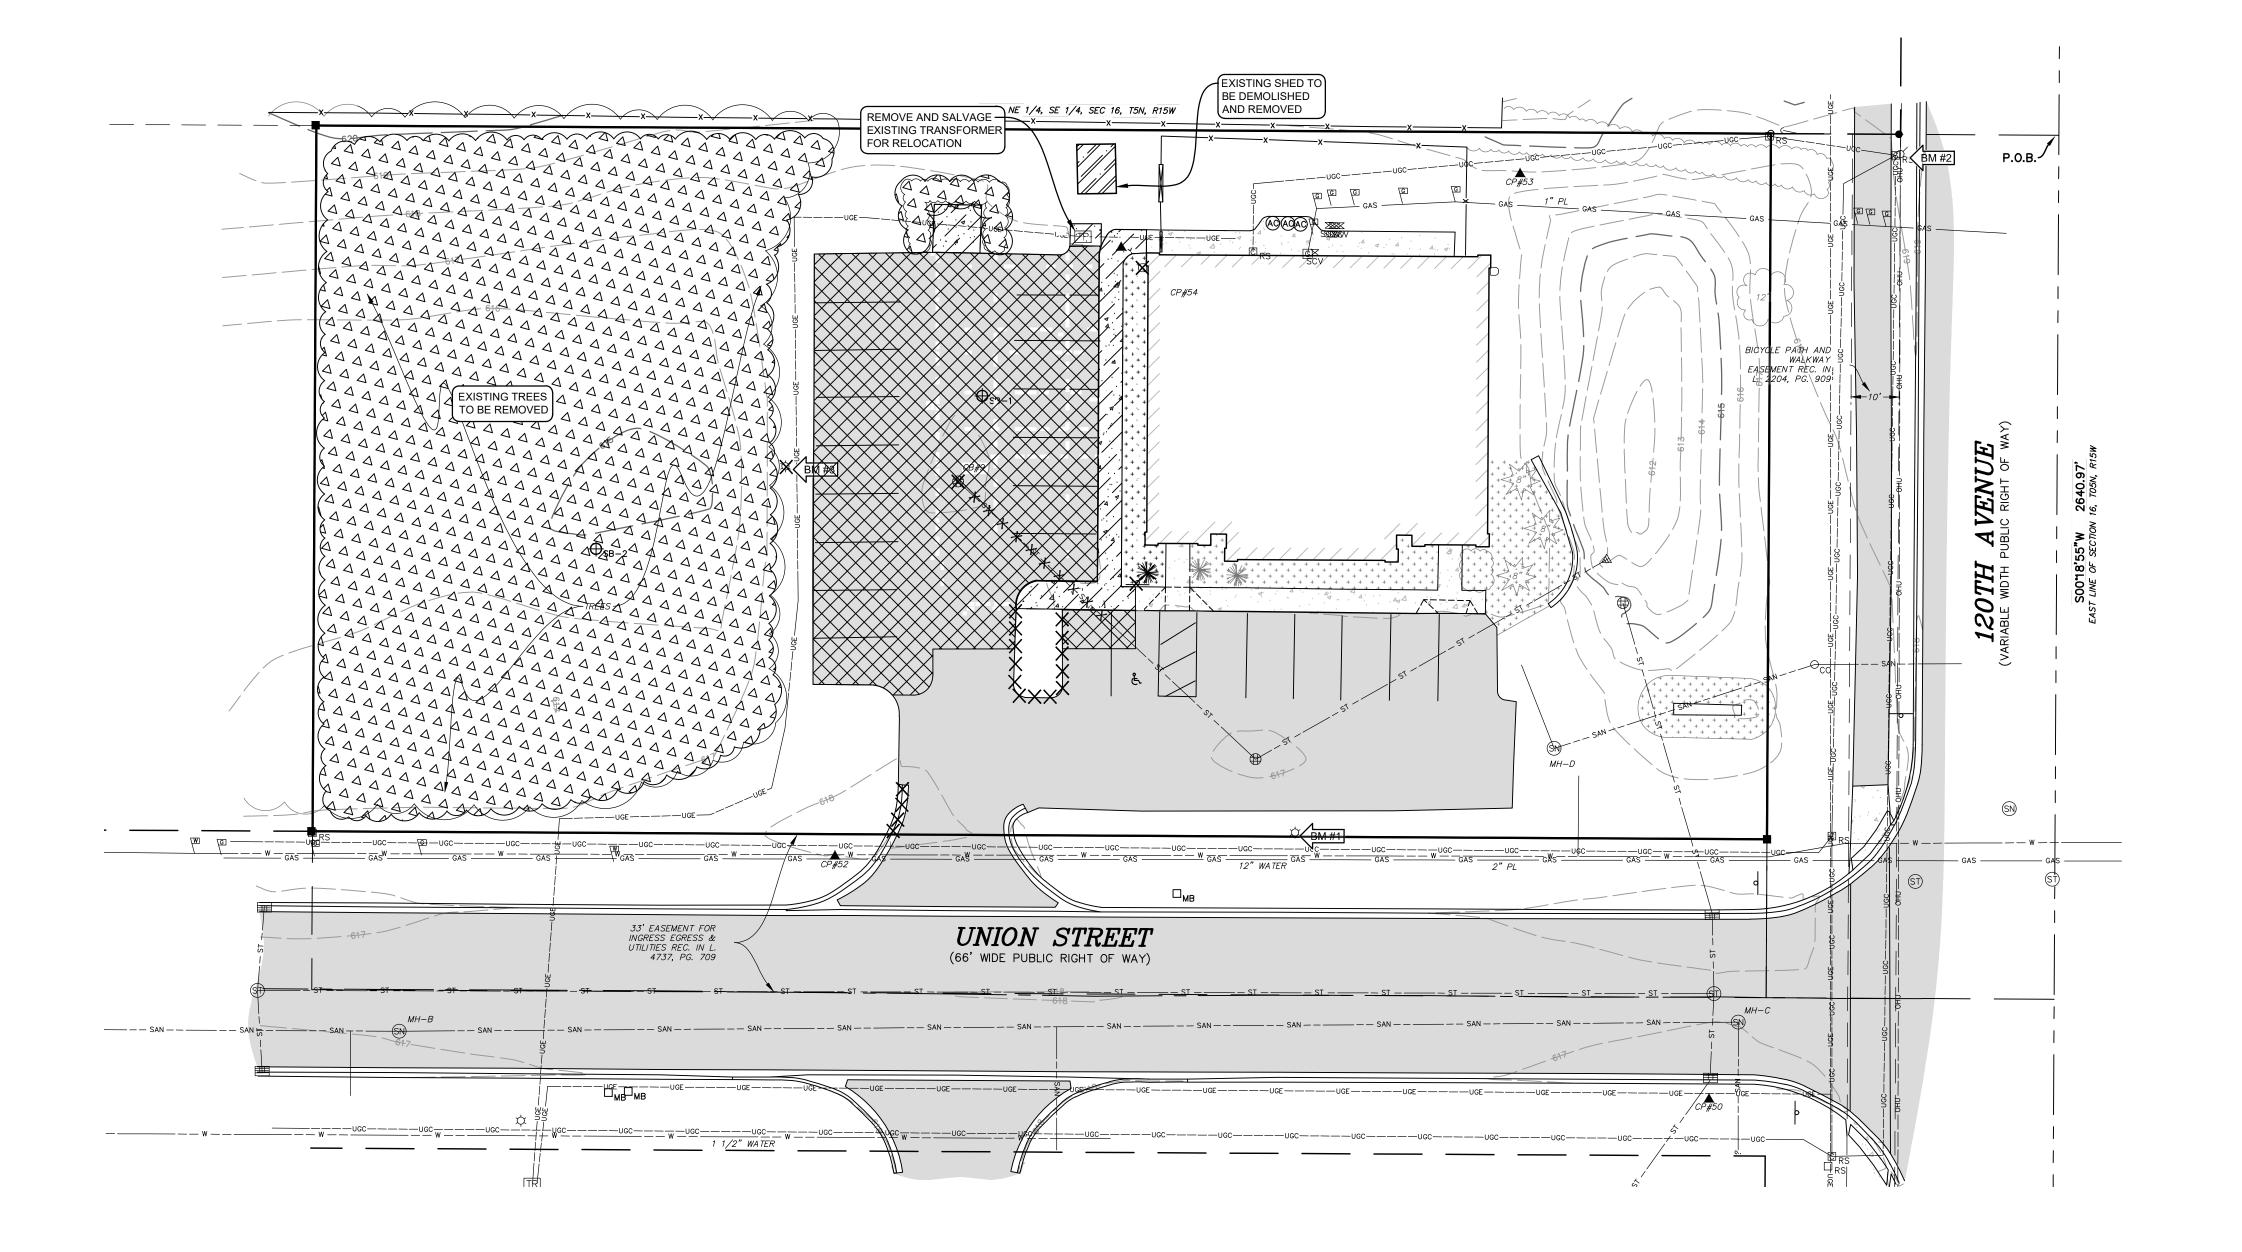



CLEARING & DEMOLITION NOTES:


1. REMOVE ALL STRUCTURES, SUPPORT COLUMNS, FOOTINGS, ASPHALT PAVING, CONCRETE CURB, SIDEWALKS, CONCRETE PADS, TREES, STUMPS, HEDGES, UTILITIES, AND OTHER EXISTING SITE FEATURES WITHIN LIMITS OF DEMOLITION. ALL DEMOLITION MATERIALS SHALL BE REMOVED FROM THE SITE UNLESS OTHERWISE INDICATED AND DISPOSED OF IN A MANNER ACCEPTABLE TO AUTHORITIES HAVING JURISDICTION.

- 2. MOVEMENT OF CLEARED WOOD IS RESTRICTED; REFER TO EMERALD ASH BORER QUARANTINE INFORMATION AT WWW.MICHIGAN.GOV. CONTRACTOR IS RESPONSIBLE FOR COMPLYING WITH ALL QUARANTINE REQUIREMENTS.
- 3. CONSTRUCTION FENCE SHALL BE PLACED AT THE DRIP LINE OF ALL TREES WITHIN THE PROJECT AREA THAT ARE INDICATED TO BE PROTECTED. DO NOT OPERATE EQUIPMENT OR STORE MATERIALS OR VEHICLES WITHIN THIS AREA.
- 4. UNLESS INDICATED TO BE ABANDONED IN PLACE, ALL UTILITIES TO BE DEMOLISHED SHALL BE REMOVED IN THEIR ENTIRETY. UTILITIES TO BE ABANDONED IN PLACE SHALL BE FILLED WITH FLOWABLE FILL AND SECURELY CAPPED.
- 5. EXCEPT FOR THOSE UTILITIES INDICATED TO BE ABANDONED OR REMOVED, RECONNECT ALL UTILITIES ENCOUNTERED DURING CONSTRUCTION.
- 6. ALL CATCHBASIN AND MANHOLE FRAMES AND COVERS SPECIFIED TO BE REMOVED SHALL BE SALVAGED, CLEANED AND INSPECTED, AND MAY BE REUSED WITH APPROVAL BY ENGINEER.
- 7. ANY REMOVAL OF PAVEMENT, SIDEWALK, CURB AND GUTTER OR OTHER HARD SURFACES SHALL BE TO A SAWCUT LINE AT THE NEXT JOINT BEYOND REMOVAL LIMITS SHOWN.
- 8. DEMOLITION WORK IS INDICATED BASED ON BEST AVAILABLE INFORMATION. CONTRACTOR SHALL INSPECT THE SITE AND BE FAMILIAR WITH THE EXTENT OF DEMOLITION WORK REQUIRED.


DEMOLITION KEY:


1 PROTECT EX. ASPHALT PAVEMENT TO REMAIN

REMOVAL LEGEND:

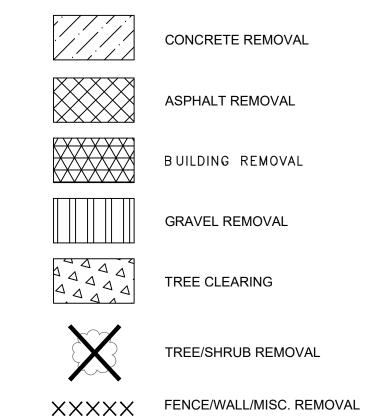


- X· X· X· X- UTILITY REMOVAL

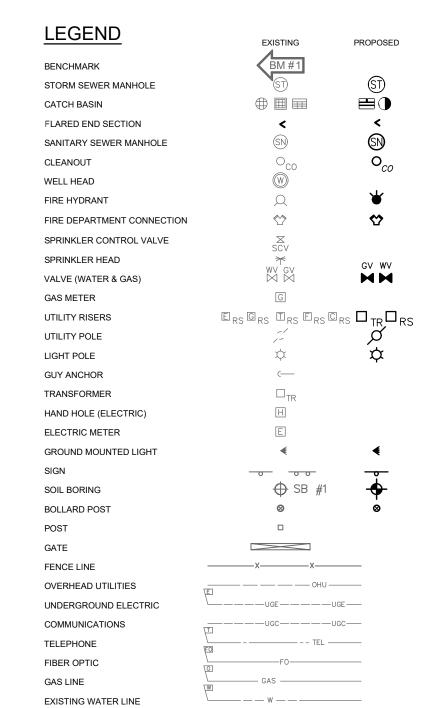

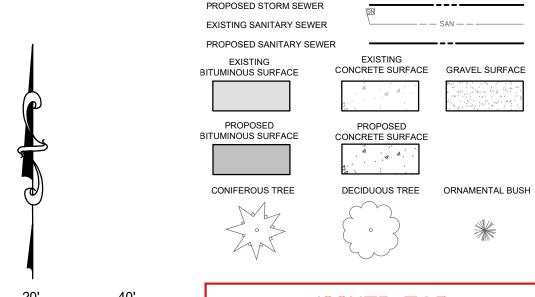

PROPOSED WATER LINE EXISTING STORM SEWER

> ISSUED FOR **APPROVAL**

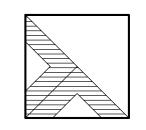

DRIESENGA 8 ASSOCIATES, INC

> Engineering Surveying Testing

· www.driesenga.com -Holland, MI

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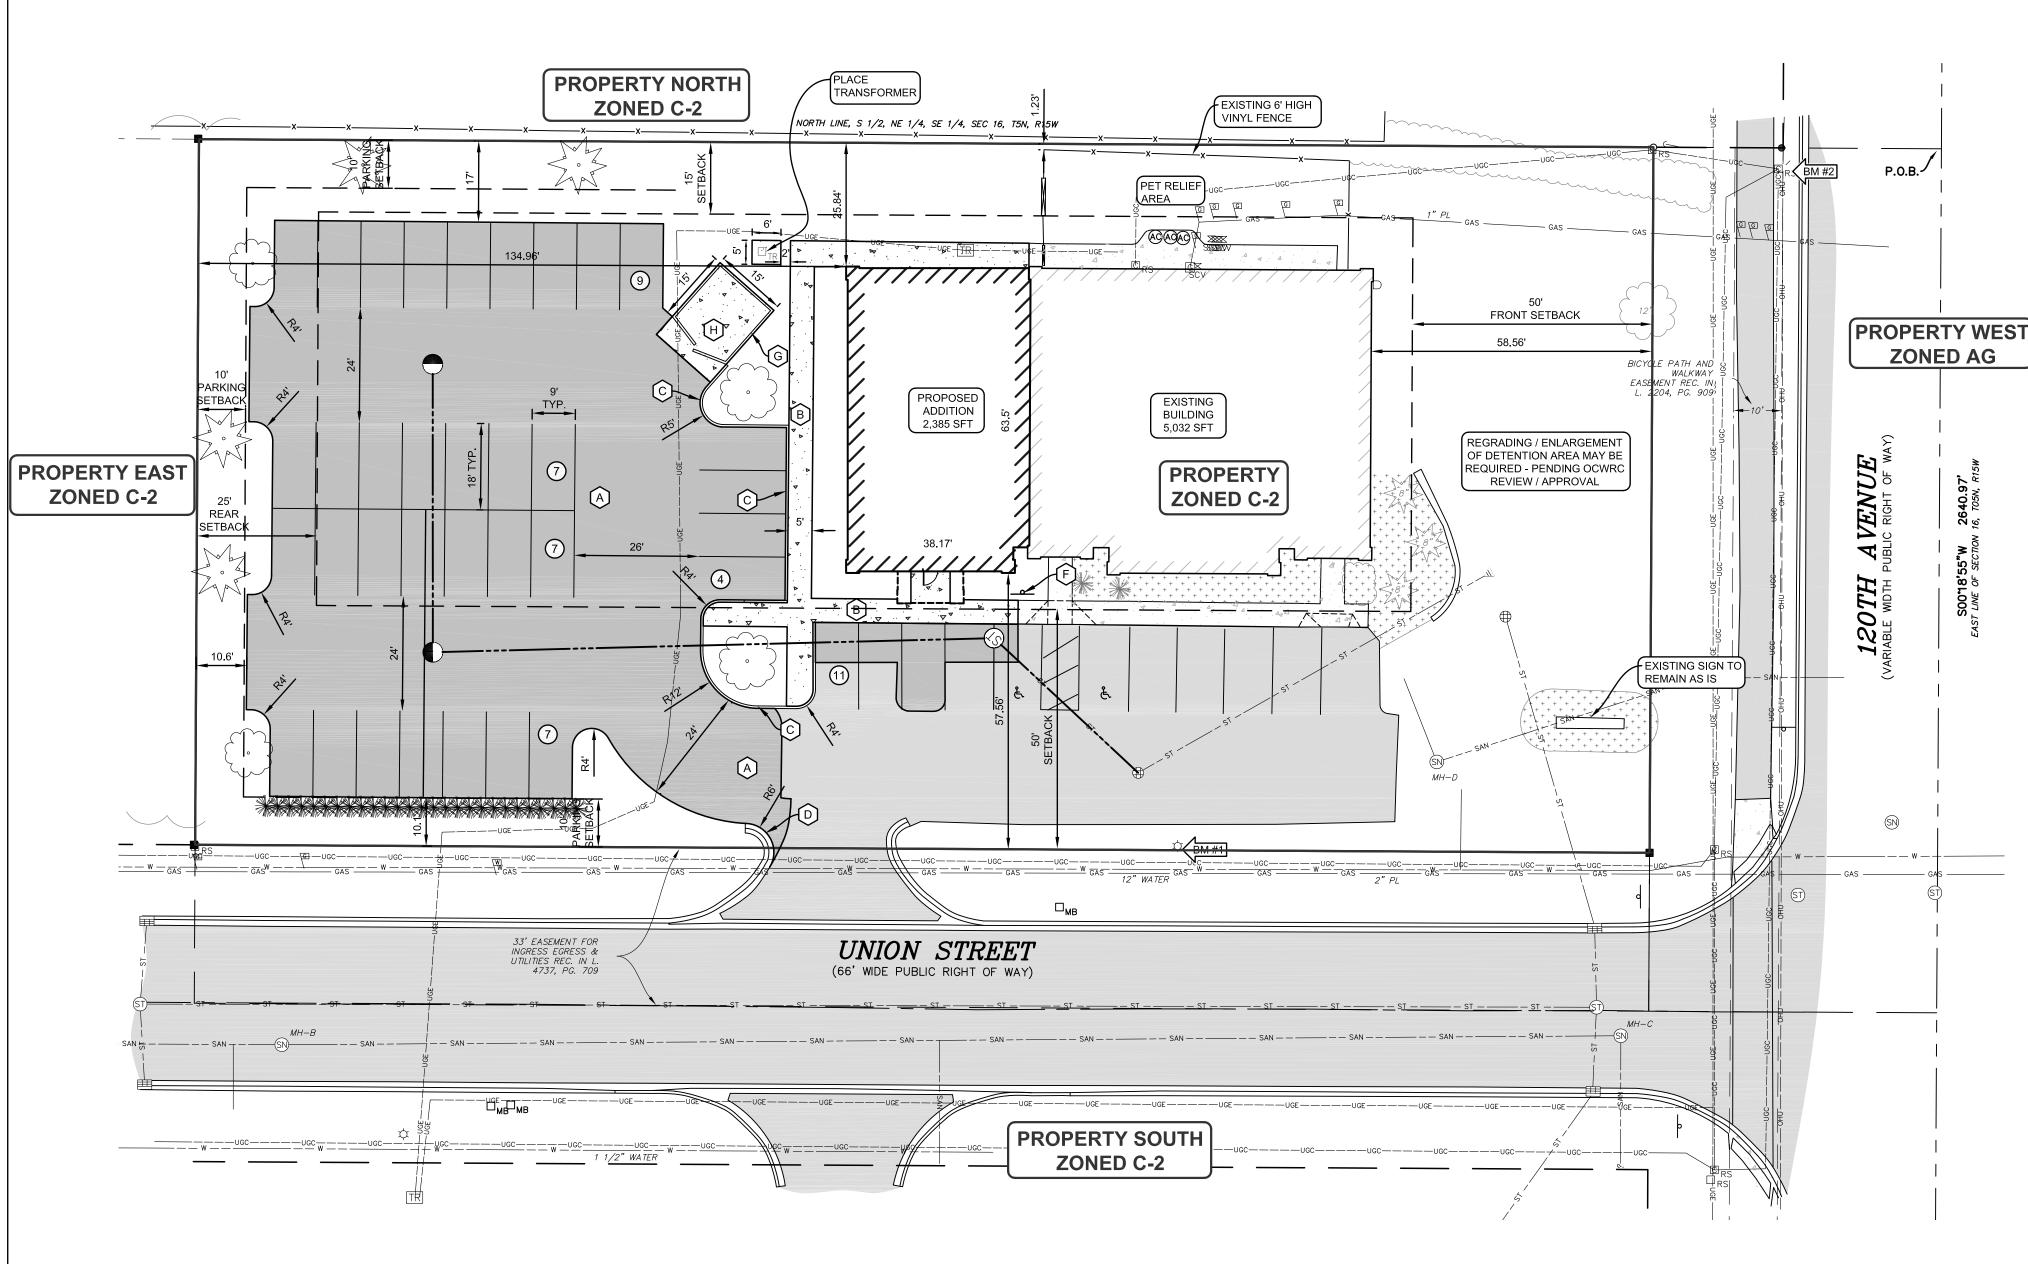
	ISSUED FOR:
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2	TWP. SITE PLAN REVIEW 07-19-2024 D: WKT C: JMP
3	TWP. SITE PLAN REVIEW 09-10-2024 D: WKT C: JMP
3	SITE PLAN REVISION 09-30-2024 D: WKT C: JMP

Project Manager: JOHN TENPAS Project #

Sheet Title: CIVIL **DEMOLITION** PLAN

2410092.1A

CD-101 3 of 7



GENERAL NOTES:

- 1. CONTRACTOR SHALL OBTAIN ALL NECESSARY LOCAL, STATE AND FEDERAL PERMITS REQUIRED.
- 2. ALL CONSTRUCTION MATERIALS AND WORKMANSHIP SHALL CONFORM TO THE STANDARDS AND SPECIFICATIONS OF AUTHORITIES HAVING JURISDICTION.
- 3. CALL "MISS DIG", 811, 72 HOURS PRIOR TO THE START OF ANY EXCAVATION.
- 4. EXISTING UNDERGROUND UTILITIES ARE SHOWN BASED ON AVAILABLE RECORDS AND/OR TOPOGRAPHIC SURVEY DATA. THIS PLAN MAY NOT SHOW UTILITIES IN THEIR EXACT LOCATION AND MAY NOT SHOW ALL
- 5. CONTRACTOR SHALL MAINTAIN UTILITY SERVICES AT ALL TIMES. ANY INTERRUPTION IN SERVICES TO THIS SITE OR ADJACENT SITES MUST BE SCHEDULED WITH THE OWNER, UTILITY PROVIDER, AND AFFECTED PROPERTIES 48 HOURS PRIOR TO THE INTERRUPTION.
- 6. CONTRACTOR SHALL PROTECT ALL EXISTING AND NEW CONSTRUCTION FROM DAMAGE. SHOULD ANY DAMAGE OCCUR, CONTRACTOR SHALL MAKE ALL NECESSARY REPAIRS AT NO COST TO THE OWNER.
- 7. IF ANY DISCREPANCIES OR CONFLICTS ARE FOUND, CONTRACTOR SHALL NOTIFY ENGINEER IMMEDIATELY PRIOR TO CONSTRUCTION OF AFFECTED WORK TO DETERMINE COURSE OF ACTION.
- 8. CONTRACTOR SHALL COORDINATE THEIR WORK WITH OTHER CONTRACTORS ON OR ADJACENT TO THE
- 9. CONTRACTOR SHALL BE RESPONSIBLE FOR NOTIFYING AND COORDINATING THEIR WORK WITH ALL UTILITY
- 10. PROVIDE BARRIERS OR OTHER PROTECTION TO KEEP VEHICULAR AND PEDESTRIAN TRAFFIC AWAY FROM CONSTRUCTION AREA AND OFF NEWLY PAVED AREAS.

LAYOUT NOTES:

PROVIDERS PRIOR TO CONSTRUCTION.

- 1. CONTRACTOR SHALL REVIEW AND VERIFY SITE LAYOUT PRIOR TO CONSTRUCTION.
- 2. CONTRACTOR SHALL ENGAGE A LICENSED SURVEYOR TO PERFORM ALL CONSTRUCTION LAYOUT AND STAKING AS NECESSARY.
- 3. ALL COORDINATE POINTS AND DIMENSIONS GIVEN, UNLESS OTHERWISE NOTED, ARE TO BACK OF CURB AND FACE OF BUILDING WALL.
- 4. REFER TO ARCHITECTURAL AND STRUCTURAL DRAWINGS FOR BUILDING DIMENSIONS.
- 5. INSTALL EXPANSION JOINTS AT ALL LOCATIONS WHERE NEW CONCRETE MEETS EXISTING CONCRETE OR BITUMINOUS PAVEMENT.

KEY NOTES:

- (A) ASPHALT PAVEMENT-STANDARD DUTY (SEE DETAIL)
- (B) 4" CONC. SIDEWALK INTEGRAL CURB (SEE DETAIL)
- (c) 6" HEAD CURB (SEE DETAIL)
- D 24" CURB & GUTTER MDOT F4 MODIFIED (SEE DETAIL)
- (E) 4" BLUE PVMT. MARKING & SYMBOL PER ADA STD.'S, TYP (SEE DETAIL)
- (F) BARRIER FREE SIGN (SEE DETAIL)
- G DUMPSTER ENCLOSURE PER HCT REQUIREMENTS (SEE DETAIL)
- (H) DUMPSTER PAD (SEE DETAIL)

PROJECT SUMMARY

C-2 COMMUNITY COMMERCIAL DISTRICT SITE ADDRESS: 2691 120TH AVE PARCEL NUMBER: 70-16-16-400-076

REQUIRED PROVIDED MIN. LAND AREA: 0.35 AC 1.02 AC MIN. LOT WIDTH: 303 FT

PROVIDED 25 FT MAX. BUILDING HEIGHT: MAX. BUILDING SIZE: 7,417 SFT N/A MAX. LOT COVERAGE: 25% 16.65%

<u>SETBACKS</u> PROVIDED SIDE (MIN.) 15 FT 25.8 FT REAR (MIN.) 25 FT 134.9 FT

REGULATORY APPROVALS

THE PROJECT WILL REQUIRE THE FOLLOWING APPROVALS, AT A MINIMUM (OTHER PERMITS/APPROVAL MAY ALSO BE REQUIRED)

- HOLLAND CHARTER TOWNSHIP SITE PLAN
- HOLLAND CHARTER TOWNSHIP FIRE DEPARTMENT
- OTTAWA COUNTY DRAIN COMMISSIONER STORM WATER MANAGEMENT
- OTTAWA COUNTY SOIL EROSION & SEDIMENTATION CONTROL PERMIT • OTTAWA COUNTY ROAD COMMISSION ROW/DRIVEWAY
- EGLE NPDES CONSTRUCTION SITE STORM WATER DISCHARGE (IF DISTURBED AREA IS GREATER
- THAN 5 ACRES)
- EGLE PUBLIC WATER SYSTEM PERMIT • EGLE PUBLIC WASTEWATER SYSTEM PERMIT

PROJECT WILL NOT RESULT IN ADVERSE IMPACT TO PUBLIC SERVICES, INCLUDING POLICE & FIRE PROTECTION, UTILITIES, TRAFFIC OR ROADWAYS.

IMPACT TO SURROUNDING PROPERTIES USE OF PROPERTY WILL BE CONSISTENT WITH OTHER USES IN THIS ZONING DISTRICT AND IN THE SURROUNDING AREA. USE OF PROPERTY WILL NOT GENERATE ADVERSE LEVELS OF NOISE, VIBRATION,

SMOKE, LIGHT, GLARE, OR OTHER PROBLEMATIC CONDITIONS.

SPACES REQUIRED 1 PER 300 SFT = (5032+2385) /300 = 25

SPACES PROVIDED =

DIMENSIONS

EXISTING SIGNAGE TO REMAIN. NO NEW SIGNAGE TO BE IMPLEMENTED.

STORM WATER MANAGEMENT STORM WATER WILL BE COLLECTED IN A SERIES OF CATCHBASINS, PIPES, AND DITCHES AND ROUTED TO A PROPOSED DETENTION BASIN ON-SITE. THE DETENTION BASIN WILL DISCHARGE TO THE PUBLIC STORM SEWER SYSTEM VIA A CONTROLLED DISCHARGE PER OTTAWA COUNTY DRAIN COMMISSIONER REQUIREMENTS.

SITE WILL BE SERVED BY NEW PRIVATE WATER AND SEWER CONNECTIONS CONNECTED TO EXISTING PUBLIC UTILITIES ADJACENT TO THE SITE.

<u>WETLANDS</u>

THERE ARE NO KNOWN REGULATED WETLANDS ON THE SUBJECT PROPERTY.

THERE ARE NO KNOWN REGULATORY FLOODPLAINS ON THE SUBJECT PROPERTY, PER FEMA FIRM MAP CN: 26139C0305E.

LANDSCAPING

FRONTAGE EXISTING FRONTAGE LANDSCAPING TO REMAIN. NO MODIFICATION TO EXISTING FRONTAGE LANDSCAPING TO BE IMPLEMENTED. EXISTING BUFFER PLANTING TO REMAIN. NO MODIFICATION TO BUFFER PLANTING TO BE IMPLEMENTED.

EXISTING 24 PARKING SPACES ACCOUNTED FOR WITH PREVIOUS LANDSCAPING. ADDITIONAL

PARKING LOT (21 ADDITIONAL SPACES)

LANDSCAPING TO BE ACCOUNTED FOR WITH:

REQUIRED PROVIDED DECIDUOUS TREES 2 (1 PER 12 SPACES) LANDSCAPED AREA 200 SQ FT (100 SQ FT PER 12 SPACES) 200 SQ FT

PROPOSED LIGHTING WILL BE WITH SHIELDED LIGHT POLES AND WALL PACKS AT LOCATIONS SHOWN. LIGHTING WILL BE CONSISTENT WITH OTHER USES IN THE AREA AND WILL COMPLY WITH ORDINANCE

15. <u>REFUSE MANAGEMENT</u>

A NEW DUMPSTER ENCLOSURE IS PROPOSED, LOCATED AT THE NORTHWEST CORNER OF THE BUILDING. ENCLOSURE WILL COMPLY WITH SCREENING REQUIREMENTS.

CONSTRUCTION SCHEDULE CONSTRUCTION IS ANTICIPATED TO START IN SEPTEMBER, 2024 AND BE COMPLETED IN MARCH, 2025.

FLARED END SECTION SANITARY SEWER MANHOLE WELL HEAD FIRE HYDRANT FIRE DEPARTMENT CONNECTION SPRINKLER CONTROL VALVE SPRINKLER HEAD MM VALVE (WATER & GAS) GAS METER ERS GRS TRS FRS ORS TRORS UTILITY RISERS UTILITY POLE LIGHT POLE **GUY ANCHOR** TRANSFORMER HAND HOLE (ELECTRIC) ELECTRIC METER GROUND MOUNTED LIGHT SOIL BORING

BENCHMARK

FENCE LINE

TELEPHONE FIBER OPTIC

GAS LINE

STORM SEWER MANHOLE

OVERHEAD UTILITIES UNDERGROUND ELECTRIC COMMUNICATIONS EXISTING WATER LINE ____ _ ST _ ____ ST _ ___ EXISTING STORM SEWER PROPOSED STORM SEWER EXISTING SANITARY SEWER

PROPOSED SANITARY SEWER EXISTING CONCRETE SURFACE GRAVEL SURFACE BITUMINOUS SURFACE PROPOSED PROPOSED BITUMINOUS SURFACE CONCRETE SURFACE DECIDUOUS TREE ORNAMENTAL BUSH **CONIFEROUS TREE**

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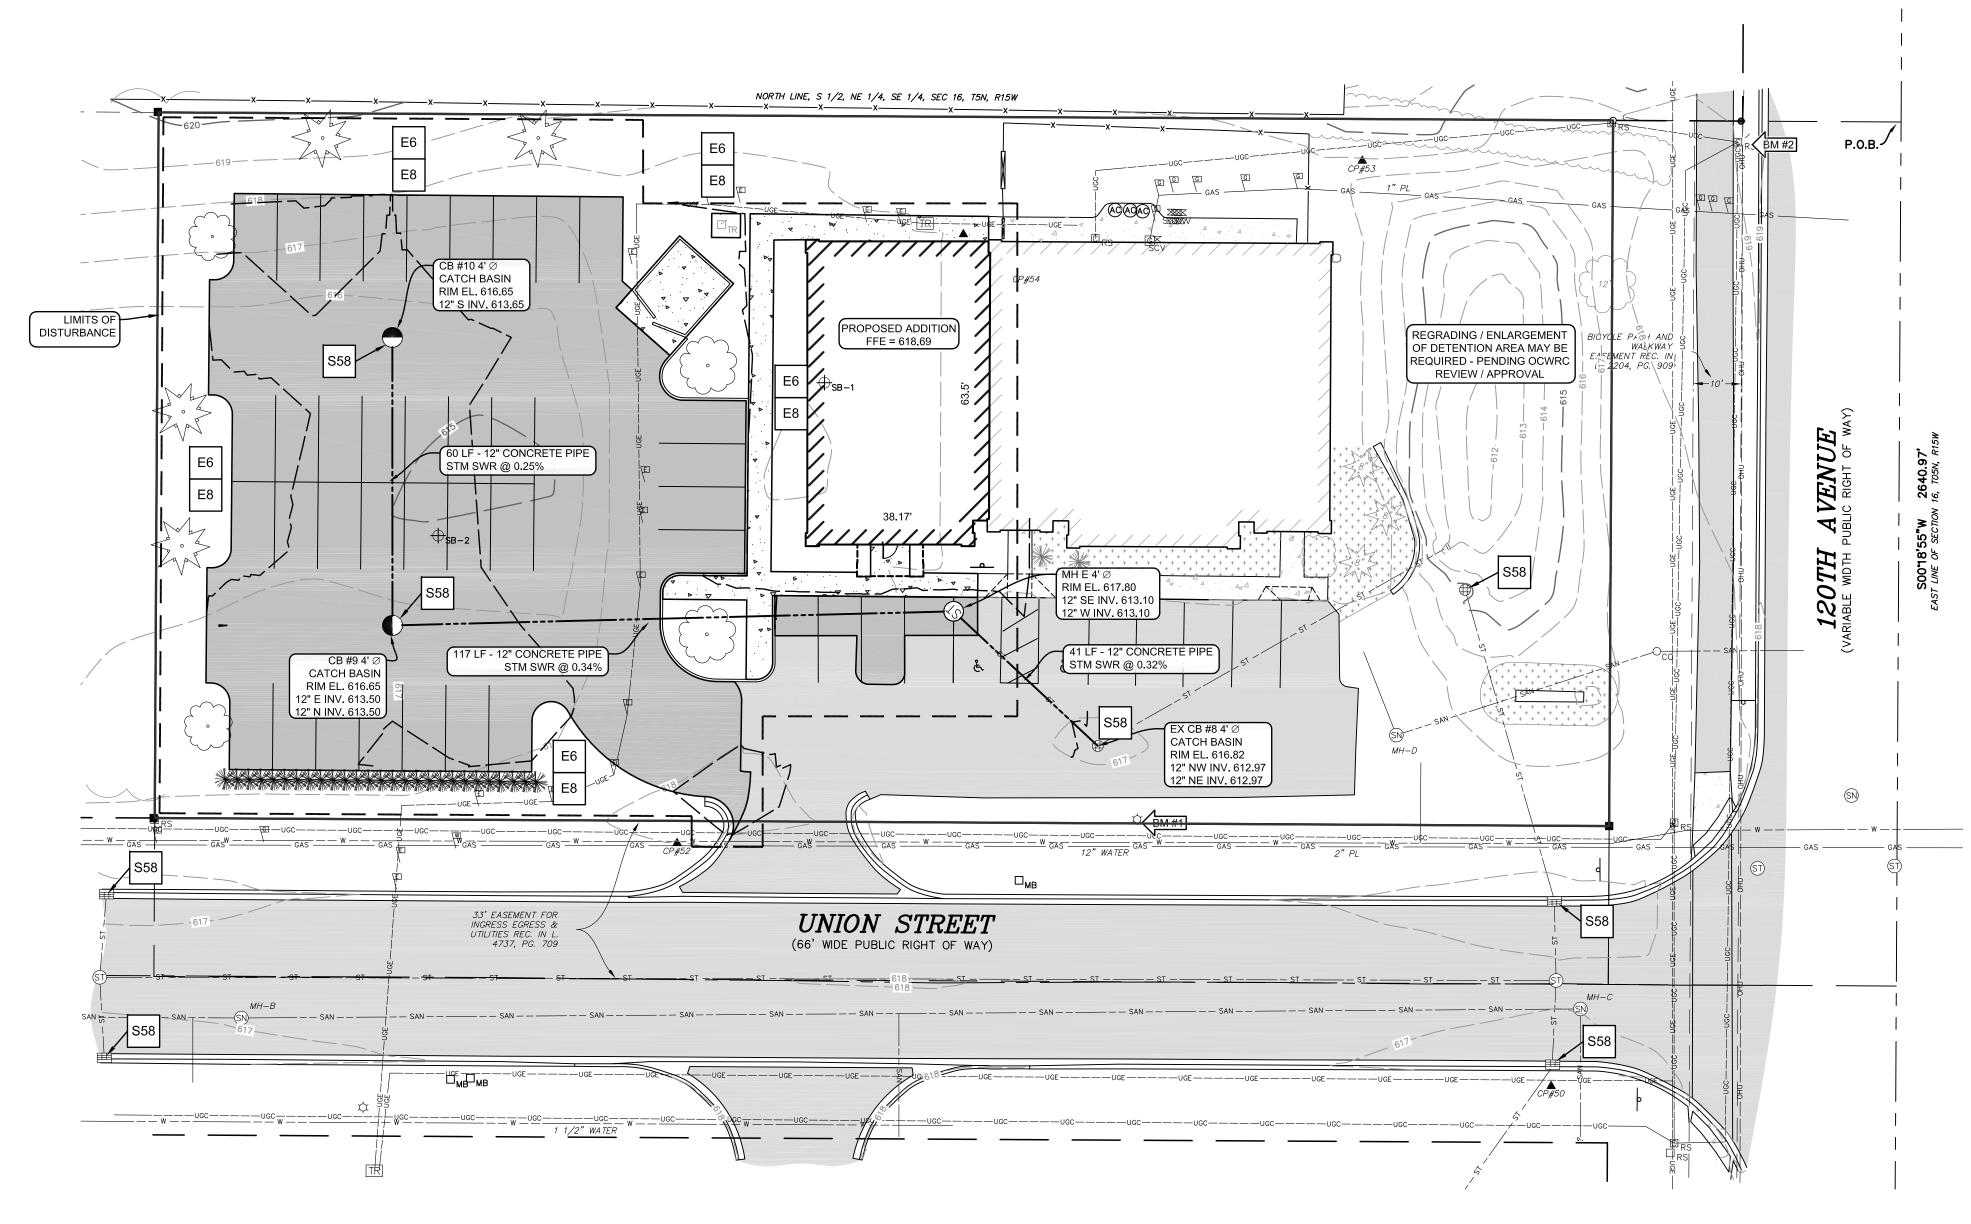
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Project Manager JOHN TENPAS Proiect# 2410092.1A Sheet Title:

PLAN

4 of 7



SOIL EROSION & SEDIMENTATION CONTROL (SESC) NOTES:

- 1. CONTRACTOR SHALL BE RESPONSIBLE FOR OBTAINING AND COMPLYING WITH THE SESC PERMIT.
- 2. PLACE TEMPORARY SESC MEASURES AS INDICATED ON DRAWING PRIOR TO EARTH MOVING AND GRADING ACTIVITIES.
- 3. CONTRACTOR SHALL AVOID THE UNNECESSARY DISTURBING OR REMOVING OF EXISTING VEGETATED TOPSOIL OR EARTH COVER.
- 4. INSPECT AND MAINTAIN ALL TEMPORARY SESC MEASURES AFTER STORM EVENTS AND AS NECESSARY TO ASSURE PROPER FUNCTION.
- 5. ALL SOIL STOCKPILES LEFT UNDISTURBED FOR MORE THAN 7 DAYS SHALL HAVE PERIMETER SILT FENCE. ALL SOIL STOCKPILES LEFT UNDISTURBED FOR MORE THAN 30 REPAIR ERODED AREAS, APPLYING SUPPLEMENTAL SEED, MULCH AND WATER AS NEEDED. DAYS SHALL BE STABILIZED WITH TEMPORARY SEEDING.
- 6. DISTURBED AREAS THAT WILL NOT BE BROUGHT TO FINAL GRADE AND PERMANENTLY STABILIZED WITHIN 30 DAYS SHALL BE STABILIZED WITH TEMPORARY SEEDING.
- 7. TEMPORARY SEEDING SHALL CONSIST OF OATS AND/OR BARLEY AT AN APPLICATION RATE OF 2.0 LBS/1000 SFT MINIMUM APRIL 1 THROUGH AUGUST 31, OR ANNUAL TO ASSIST IN THE ESTABLISHMENT OF NATIVE SPECIES REMOVE UNWANTED COMPETING VEGETATION IN THE FIRST YEAR. RYEGRASS AT AN APPLICATION RATE OF NOT LESS THAN 2.0 LBS/1000 SFT AUGUST 1 THROUGH NOVEMBER 15. IRRIGATE IF NECESSARY TO ESTABLISH TEMPORARY
- 8. TEMPORARY SESC MEASURES SHALL REMAIN IN PLACE UNTIL ALL PERMANENT SESC MEASURES ARE INSTALLED, AND VEGETATION IS UNIFORMLY ESTABLISHED. RE-GRADE, RE-SEED AND PLACE ADDITIONAL TOPSOIL IN ERODED AREAS AS NECESSARY UNTIL FINAL LANDSCAPING IS INSTALLED.
- 9. CONSTRUCTION OF SEDIMENT BASINS AND DIVERSION DITCHES SHALL BE COMPLETED PRIOR TO SITE CLEARING AND GRADING.
- 10. INSTALL INLET SEDIMENT TRAPS ("SILT SACK" OR EQUAL) IN ALL PROPOSED CATCHBASINS AS INDICATED ON THIS DRAWING. CLEAN INLET SEDIMENT TRAPS ON A WEEKLY
- 11. CONTRACTOR SHALL INSPECT AND CLEAN OUT ALL EXISTING AND PROPOSED STORM SEWER CATCHBASINS AND MANHOLES WITHIN THE PROJECT LIMITS, OR OUTSIDE THE PROJECT LIMITS IF SUBJECT TO CONSTRUCTION SITE RUNOFF, AS NECESSARY DURING CONSTRUCTION AND PRIOR TO FINAL ACCEPTANCE.
- 12. PLACE SILT FENCE ALONG DISTURBED AREAS WHERE SURFACE WATER WILL FLOW INTO EXISTING SWALES, DITCHES AND ADJACENT PROPERTIES. ANCHOR SILT FENCE TO PREVENT UNCONTROLLED RELEASE OF SILT LADEN WATER.
- 13. THE CONTRACTOR IS RESPONSIBLE FOR THE DAILY SWEEPING OF TRACKED MATERIALS FROM ALL ROADWAYS.
- 14. THE SESC MEASURES SHOWN ON THIS PLAN ARE THE MINIMUM MEASURES REQUIRED. DUE TO SITE ACTIVITIES AND SCHEDULES, ADDITIONAL MEASURES WILL LIKELY BE REQUIRED TO MAINTAIN SITE ACCORDING TO APPLICABLE STATE AND FEDERAL GUIDELINES AT NO ADDITIONAL COST TO THE OWNER.
- 15. ONCE SITE IS STABILIZED, ALL TEMPORARY SESC MEASURES SHALL BE REMOVED.

CONTINUED MAINTENANCE OF PERMANENT SESC MEASURES:

PROPERTY OWNER SHALL BE RESPONSIBLE TO MAINTAIN PERMANENT SESC MEASURES.

REPAIR CRACKED OR DAMAGE PAVEMENT AS NEEDED.

<u>SEEDING:</u>
INSPECT NEWLY SEEDED AREAS SUBSEQUENT TO ANTICIPATED GERMINATION DATE AND AFTER EACH SIGNIFICANT RAINFALL EVENT THAT PRODUCES RUNOFF UNTIL AREAS ARE STABILIZED.

IF SEED DOES NOT ESTABLISH, CONDUCT SOIL TESTS, AMEND SOILS AS NEEDED, AND REAPPLY SEED AND/OR MULCH DURING THE RECOMMENDED GROWING SEASON.

MOWING CAN BE USED PERIODICALLY TO DISCOURAGE WEEDS.

SESC SITE SUMMARY:

- 1. NATIVE SITE SOIL IS CLASSIFIED AS SANDY LOAM PER USDA WEB SOIL SURVEY OR SOIL BORINGS.
- WETLANDS THERE ARE NO KNOWN REGULATED WETLANDS ON THE SUBJECT
- PROPERTY
- THERE ARE NO KNOWN REGULATORY FLOODPLAINS ON THE SUBJECT PROPERTY, PER FEMA FIRM MAP CN: 26139C0305E.
- 4. AREA OF DISTURBANCE: 0.47 ACRES

		OPERATION TIME SCHEDULE - FILL IN DATE										
CONSTRUCTION SEQUENCE	JAN	FEB	MAR	APR	MAY	JUN	JUL	AUG	SEP	ОСТ	NOV	DEC
SITE CLEARING AND INSTALL CONTROLS												
ROUGH GRADE SITE									<i>///</i> .			
INSTALL UTILITIES												
BUILDING CONSTRUCTION												
FINAL GRADING												
PAVING												
SEEDING & STABILIZATION												

UTILITY NOTES

- 1. CONTRACTOR SHALL OBTAIN CONNECTION PERMIT PRIOR TO INSTALLATION OF ANY PRIVATE WATER, SANITARY, OR STORM CONNECTIONS TO PUBLIC MAIN.
- 2. CONTRACTOR SHALL ENSURE ALL NECESSARY PERMITS ARE OBTAINED FOR ANY PROPOSED PUBLIC WATER MAIN, SANITARY SEWER, OR STORM SEWER. CONTRACTOR SHALL COORDINATE WITH MUNICIPALITY PRIOR TO CONSTRUCTION TO SCHEDULE PRE-CONSTRUCTION MEETING AND TO ENSURE COMPLIANCE WITH
- 3. REFER TO ARCHITECTURAL AND MECHANICAL DRAWINGS FOR EXACT UTILITY CONNECTION LOCATIONS AT
- 4. ALL SITE UTILITIES SHALL BE STUBBED AND PLUGGED TO WITHIN FIVE FEET OF THE OUTSIDE BUILDING FOUNDATION WALL UNLESS OTHERWISE NOTED.
- 5. CONTRACTOR SHALL DOCUMENT, AND FURNISH TO OWNER AND ENGINEER, WITNESS DIMENSIONS FOR ALL UTILITY STUBS AND CONDUITS INSTALLED.
- 6. ALL UTILITY WORK SHALL BE COMPLETED, INCLUDING TRENCH BACKFILL AND COMPACTION, PRIOR TO PLACEMENT OF AGGREGATE BASE.

GRADING NOTES:

- 1. ALL SURFACES SHALL BE GRADED TO PROVIDE SMOOTH CONTOURING AND POSITIVE SLOPE AWAY FROM BUILDINGS, WITH NO PONDING
- 2. IN ALL AREAS OF NEW CONSTRUCTION, GRADING, OR MATERIAL STOCKPILE AREAS, STRIP AND STOCKPILE EXISTING TOPSOIL PRIOR TO OTHER CONSTRUCTION ACTIVITIES.
- 3. UNLESS OTHERWISE INDICATED, GRADES AND CONTOURS SHOWN REPRESENT FINISHED GRADE, AFTER PLACEMENT OF PAVEMENT, TOPSOIL, AND OTHER SURFACE IMPROVEMENTS.
- 4. CONTRACTOR SHALL BE RESPONSIBLE FOR THE ADJUSTMENT OF ALL EXISTING MANHOLES AND CATCH BASINS, FRAMES AND COVERS, VALVE BOXES, AND CLEAN-OUTS TO MEET FINISHED GRADE.

RESTORATION NOTES:

- EXISTING ONSITE TOPSOIL MAY BE USED IF APPROVED BY ENGINEER. IF NOT APPROVED, IMPORTED TOPSOIL MEETING PROJECT
- RETENTION BASIN, IF PRESENT, SHALL BE RESTORED WITH 3" OF LOOSE SANDY TOPSOIL, SEED, FERTILIZER, AND MULCH ON BASIN BOTTOM. RETENTION BASIN SIDESLOPES SHALL BE RESTORED WITH 3" OF LOOSE SANDY TOPSOIL, SEED, FERTILIZER, AND EROSION CONTROL BLANKET, NORTH AMERICAN GREEN DS150 OR EQUAL. SEED MIX SHALL BE JFNEW STORMWATER SEED MIX OR EQUAL ON BASIN BOTTOM AND 2 FEET VERTICALLY UP SIDESLOPE, AND SUITABLE GRASS SEED MIX ABOVE 2 FOOT LEVEL.
- 3. DETENTION BASIN, IF PRESENT, SHALL BE RESTORED WITH 4" (MIN) TOPSOIL, SUITABLE GRASS SEED MIX, FERTILIZER, AND MULCH ON BASIN BOTTOM. DETENTION BASIN SIDESLOPES SHALL BE RESTORED WITH 4" (MIN) TOPSOIL, SUITABLE GRASS SEED MIX, FERTILIZER, AND EROSION CONTROL BLANKET, NORTH AMERICAN GREEN DS150 OR EQUAL.
- 4. ALL OTHER SLOPES STEEPER THAN 1 ON 4 SHALL BE RESTORED WITH 4" (MIN) TOPSOIL, SUITABLE GRASS SEED MIX, FERTILIZER, AND EROSION CONTROL BLANKET, NORTH AMERICAN GREEN DS150 OR EQUAL.
- 5. ALL OTHER DISTURBED AREAS SHALL BE RESTORED WITH 4" (MIN) TOPSOIL, SUITABLE GRASS SEED MIX, FERTILIZER, AND MULCH.

USE AT STORMWATER INLETS, ESPECIALLY AT CONSTRUCTION

<u>LEGEND</u>

INLET PROTECTION FABRIC

XXX.XX FINISH GRADE ELEVATION

MG XXX.XX± MATCH EXISTING GRADE ELEVATION

TC XXX.XX X FINISH GRADE ELEVATION AT BACK OF CURB FINISH GRADE ELEVATION AT FLOW LINE

TW XXX.XX± FINISH GRADE ELEVATION AT TOP OF WALL

BW XXX.XX± FINISH GRADE ELEVATION AT BOTTOM OF WALL AT GROUND

------ PROPOSED SWALE

----- PROPOSED MAJOR CONTOUR — — PROPOSED MINOR CONTOUR

---- EXISTING MAJOR CONTOUR

— — EXISTING MINOR CONTOUR

627.00 MINIMUM OPENING ELEV. (M.O.E.)

MINIMUM BASEMENT ELEV. (M.B.E.)

FOR USE IN AREAS SUBJECT TO EROSIVE SURFACE FLOWS OR SEVERE WIND OR ON NEWLY SEEDED AREAS. STABILIZATION METHOD UTILIZED ON SITES WHERE EARTH CHANGE HAS BEEN COMPLETED (FINAL GRADING ATTAINED). PERMANENT SEEDING

	FIRE HYDRANT	Q	A
	FIRE DEPARTMENT CONNECTION		❖
	SPRINKLER CONTROL VALVE	X SCV	
	SPRINKLER HEAD	*	GV WV
	VALVE (WATER & GAS)	₩V GV	HH
	GAS METER	G	
	UTILITY RISERS	E _{RS} G _{RS} II _{RS} E _{RS} C _{RS}	$\square_{TR}\square_{RS}$
	UTILITY POLE		Ø
7	LIGHT POLE	\$	\Diamond
	GUY ANCHOR		
	TRANSFORMER	\Box_{TR}	
7	HAND HOLE (ELECTRIC)	H	
	ELECTRIC METER	E	
4	GROUND MOUNTED LIGHT	€	€
	SIGN	0 00	-
	SOIL BORING	→ SB #1	
_	BOLLARD POST	⊗	⊗
	POST		
	GATE		
	FENCE LINE	XX	_
	OVERHEAD UTILITIES	OHU	_
	UNDERGROUND ELECTRIC	UGEUGE	_
	COMMUNICATIONS	UGCUGC	_

LEGEND

STORM SEWER MANHOLE


FLARED END SECTION

SANITARY SEWER MANHOLE

BENCHMARK

CLEANOUT

WELL HEAD

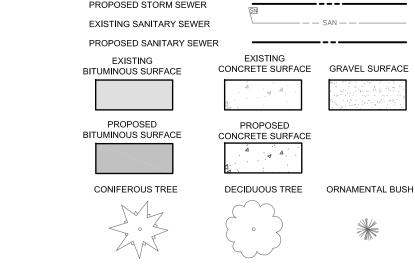

TELEPHONE

FIBER OPTIC

EXISTING WATER LINE

PROPOSED WATER LINE

EXISTING STORM SEWER

GAS LINE

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Project Manager: JOHN TENPAS


Proiect# 2410092.1A

Sheet Title: STORM SEWER, GRADING AND

CONTROL PLAN

SOIL EROSION



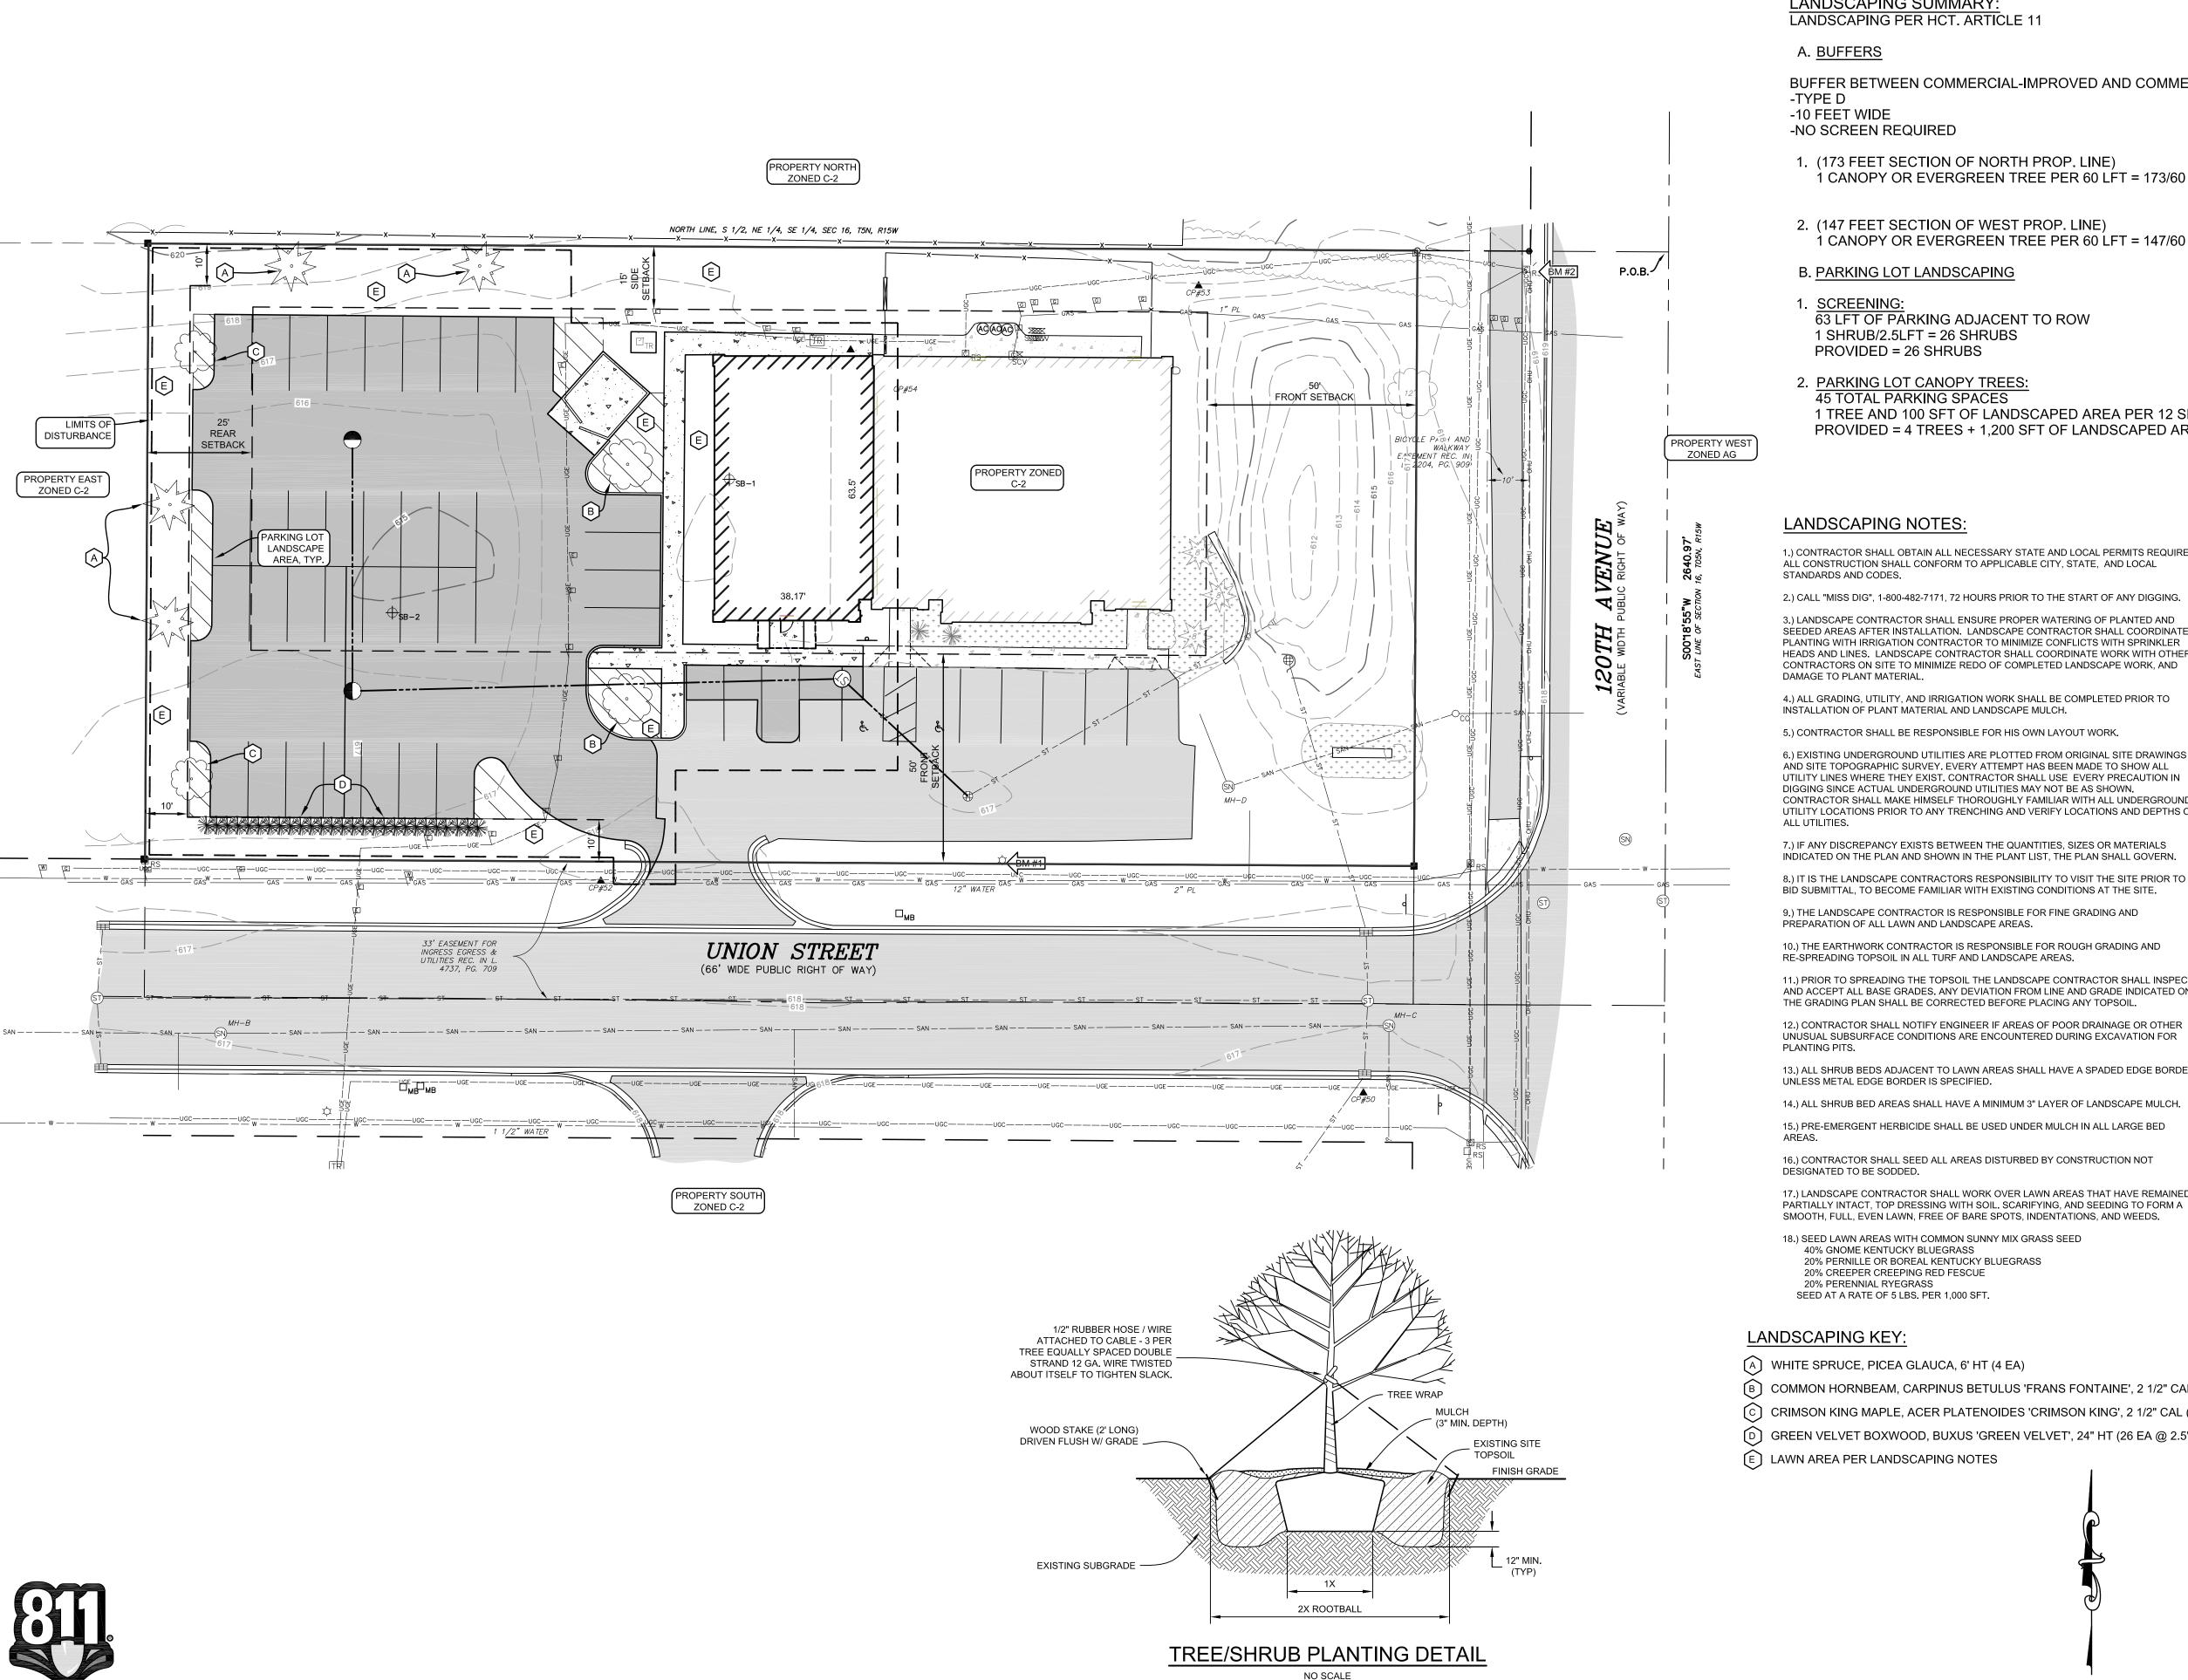

Know what's below.

Call before you dig.

LANDSCAPING SUMMARY: LANDSCAPING PER HCT. ARTICLE 11

A. <u>BUFFERS</u>

BUFFER BETWEEN COMMERCIAL-IMPROVED AND COMMERCIAL-IMPROVED

-10 FEET WIDE

-NO SCREEN REQUIRED

REQUIRED PROVIDED 1. (173 FEET SECTION OF NORTH PROP. LINE) 1 CANOPY OR EVERGREEN TREE PER 60 LFT = 173/60 = REQUIRED PROVIDED 2. (147 FEET SECTION OF WEST PROP. LINE) 1 CANOPY OR EVERGREEN TREE PER 60 LFT = 147/60 =

B. PARKING LOT LANDSCAPING

63 LFT OF PARKING ADJACENT TO ROW 1 SHRUB/2.5LFT = 26 SHRUBS

PROVIDED = 26 SHRUBS

45 TOTAL PARKING SPACES 1 TREE AND 100 SFT OF LANDSCAPED AREA PER 12 SPACES = 4 TREES + 400 SFT OF LANDSCAPED AREA PROVIDED = 4 TREES + 1,200 SFT OF LANDSCAPED AREA

1.) CONTRACTOR SHALL OBTAIN ALL NECESSARY STATE AND LOCAL PERMITS REQUIRED. ALL CONSTRUCTION SHALL CONFORM TO APPLICABLE CITY, STATE, AND LOCAL

2.) CALL "MISS DIG", 1-800-482-7171, 72 HOURS PRIOR TO THE START OF ANY DIGGING.

3.) LANDSCAPE CONTRACTOR SHALL ENSURE PROPER WATERING OF PLANTED AND SEEDED AREAS AFTER INSTALLATION. LANDSCAPE CONTRACTOR SHALL COORDINATE PLANTING WITH IRRIGATION CONTRACTOR TO MINIMIZE CONFLICTS WITH SPRINKLER HEADS AND LINES. LANDSCAPE CONTRACTOR SHALL COORDINATE WORK WITH OTHER CONTRACTORS ON SITE TO MINIMIZE REDO OF COMPLETED LANDSCAPE WORK, AND DAMAGE TO PLANT MATERIAL.

4.) ALL GRADING, UTILITY, AND IRRIGATION WORK SHALL BE COMPLETED PRIOR TO INSTALLATION OF PLANT MATERIAL AND LANDSCAPE MULCH.

5.) CONTRACTOR SHALL BE RESPONSIBLE FOR HIS OWN LAYOUT WORK.

6.) EXISTING UNDERGROUND UTILITIES ARE PLOTTED FROM ORIGINAL SITE DRAWINGS AND SITE TOPOGRAPHIC SURVEY. EVERY ATTEMPT HAS BEEN MADE TO SHOW ALL UTILITY LINES WHERE THEY EXIST. CONTRACTOR SHALL USE EVERY PRECAUTION IN DIGGING SINCE ACTUAL UNDERGROUND UTILITIES MAY NOT BE AS SHOWN. CONTRACTOR SHALL MAKE HIMSELF THOROUGHLY FAMILIAR WITH ALL UNDERGROUND UTILITY LOCATIONS PRIOR TO ANY TRENCHING AND VERIFY LOCATIONS AND DEPTHS OF

7.) IF ANY DISCREPANCY EXISTS BETWEEN THE QUANTITIES, SIZES OR MATERIALS INDICATED ON THE PLAN AND SHOWN IN THE PLANT LIST, THE PLAN SHALL GOVERN. 8.) IT IS THE LANDSCAPE CONTRACTORS RESPONSIBILITY TO VISIT THE SITE PRIOR TO BID SUBMITTAL, TO BECOME FAMILIAR WITH EXISTING CONDITIONS AT THE SITE. 9.) THE LANDSCAPE CONTRACTOR IS RESPONSIBLE FOR FINE GRADING AND

PREPARATION OF ALL LAWN AND LANDSCAPE AREAS. 10.) THE EARTHWORK CONTRACTOR IS RESPONSIBLE FOR ROUGH GRADING AND RE-SPREADING TOPSOIL IN ALL TURF AND LANDSCAPE AREAS.

11.) PRIOR TO SPREADING THE TOPSOIL THE LANDSCAPE CONTRACTOR SHALL INSPECT AND ACCEPT ALL BASE GRADES. ANY DEVIATION FROM LINE AND GRADE INDICATED ON THE GRADING PLAN SHALL BE CORRECTED BEFORE PLACING ANY TOPSOIL.

12.) CONTRACTOR SHALL NOTIFY ENGINEER IF AREAS OF POOR DRAINAGE OR OTHER UNUSUAL SUBSURFACE CONDITIONS ARE ENCOUNTERED DURING EXCAVATION FOR

13.) ALL SHRUB BEDS ADJACENT TO LAWN AREAS SHALL HAVE A SPADED EDGE BORDER, UNLESS METAL EDGE BORDER IS SPECIFIED.

14.) ALL SHRUB BED AREAS SHALL HAVE A MINIMUM 3" LAYER OF LANDSCAPE MULCH. 15.) PRE-EMERGENT HERBICIDE SHALL BE USED UNDER MULCH IN ALL LARGE BED

16.) CONTRACTOR SHALL SEED ALL AREAS DISTURBED BY CONSTRUCTION NOT DESIGNATED TO BE SODDED. 17.) LANDSCAPE CONTRACTOR SHALL WORK OVER LAWN AREAS THAT HAVE REMAINED


18.) SEED LAWN AREAS WITH COMMON SUNNY MIX GRASS SEED 40% GNOME KENTUCKY BLUEGRASS 20% PERNILLE OR BOREAL KENTUCKY BLUEGRASS 20% CREEPER CREEPING RED FESCUE 20% PERENNIAL RYEGRASS SEED AT A RATE OF 5 LBS. PER 1,000 SFT.


LANDSCAPING KEY:

(A) WHITE SPRUCE, PICEA GLAUCA, 6' HT (4 EA)

B COMMON HORNBEAM, CARPINUS BETULUS 'FRANS FONTAINE', 2 1/2" CAL. (2 EA) C CRIMSON KING MAPLE, ACER PLATENOIDES 'CRIMSON KING', 2 1/2" CAL (2 EA) D GREEN VELVET BOXWOOD, BUXUS 'GREEN VELVET', 24" HT (26 EA @ 2.5' O.C.)

(E) LAWN AREA PER LANDSCAPING NOTES

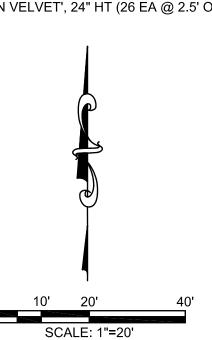

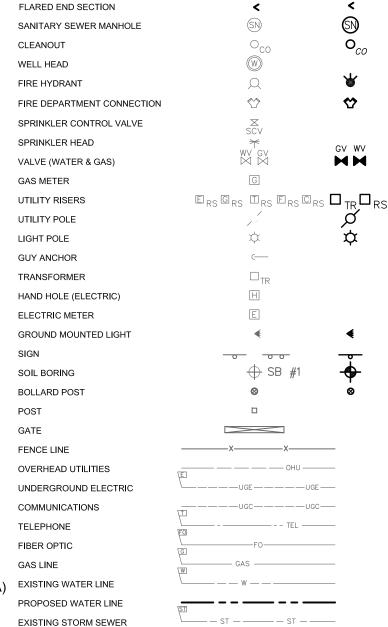

LEGEND

STORM SEWER MANHOLE

PROPOSED STORM SEWER

EXISTING

PROPOSED

CONIFEROUS TREE

BITUMINOUS SURFACE

EXISTING SANITARY SEWER

PROPOSED SANITARY SEWER

BENCHMARK

Project # Sheet Title:

ISSUED FOR **APPROVAL**

PROPOSED

CONCRETE SURFACE

Δ A Δ.

CONCRETE SURFACE GRAVEL SURFACE

DECIDUOUS TREE ORNAMENTAL BUSH

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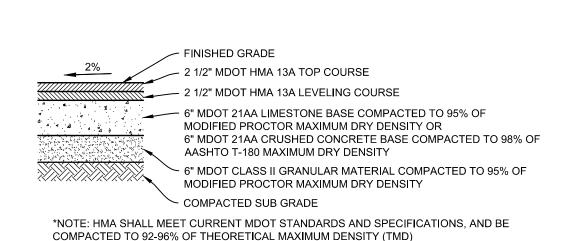
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Project Manager JOHN TENPAS 2410092.1A

> LANDSCAPE PLAN

L-101 6 of 7



ASPHALT SIDEWALK


NO SCALE

12" MDOT CLASS II GRANULAR MATERIAL - COMPACTED TO 95% OF MODIFIED PROCTOR MAXIMUM DRY DENSITY COMPACTED SUB GRADE


6" REINFORCED CONCRETE PAVEMENT NO SCALE

6" CONCRETE WITH EXPANSION & CONTROL

#4 EPOXY COATED BARS AT 12" O.C. EACH

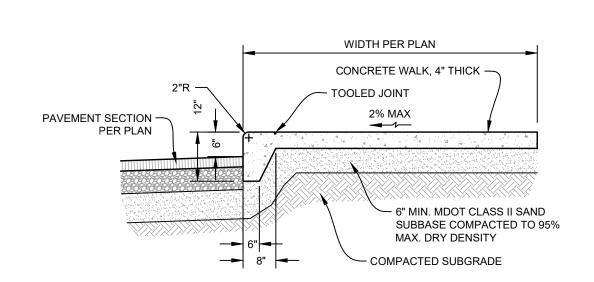


SIDEWALK WITH INTEGRAL CURB

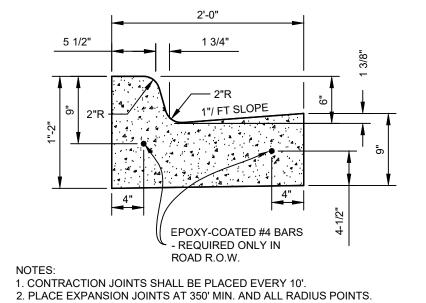

24" CURB & GUTTER - MDOT F4 NO SCALE

3. CONCRETE SHALL CONFORM TO MDOT SPEC. 802.

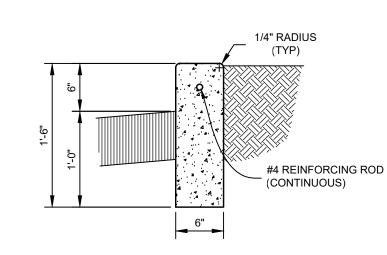

ALL CONCRETE CURBS TO HAVE EXPANSION JOINTS OR SAW CUTS NOT MORE THAN 20' APART.


> 6" HEAD CURB NO SCALE

1. ALL FACILITIES FOR THE DISABLED SHALL CONFORM WITH THE AMERICANS WITH DISABILITIES ACT AND ALL REVISIONS.

2. THE CHARACTERS AND THE BACKGROUND OF SIGNS SHALL BE EGGSHELL, MATTE, OR OTHER NON-GLARE FINISH. CHARACTERS AND SYMBOLS SHALL CONTRAST WITH THEIR BACKGROUND. LIGHT CHARACTERS ON DARK BACKGROUND ARE PREFERRED.

3. CONTRAST LEVELS OF SYMBOLS TO BACKGROUND TO BE A MINIMUM OF 70%.


4. CONTRACTOR SHALL VERIFY THAT THE SYMBOL SHOWN MEETS THE CURRENT STANDARDS FOR THE INTERNATIONAL SYMBOL OF ACCESSIBILITY AND SHALL BE IN COMPLIANCE WITH ICC/ANSI

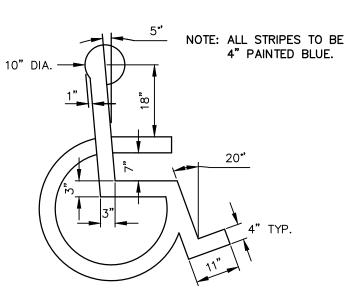


BARRIER FREE SYMBOL NO SCALE

Know what's below.


Call before you dig.

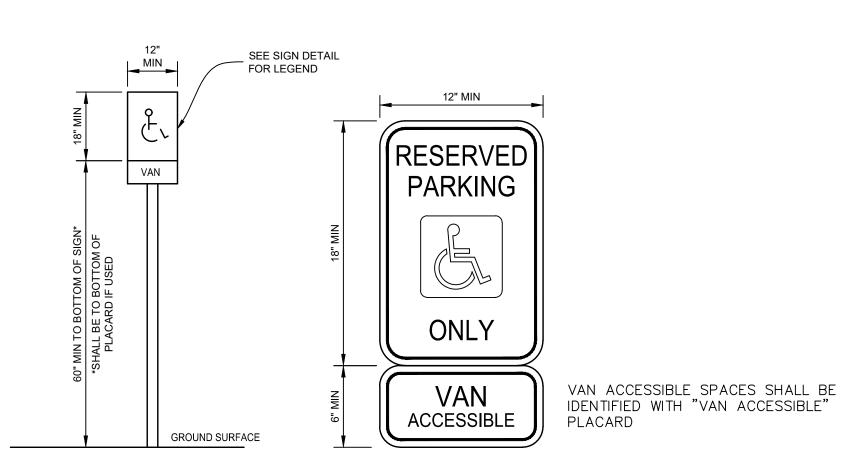


BARRIER FREE SIGN NO SCALE

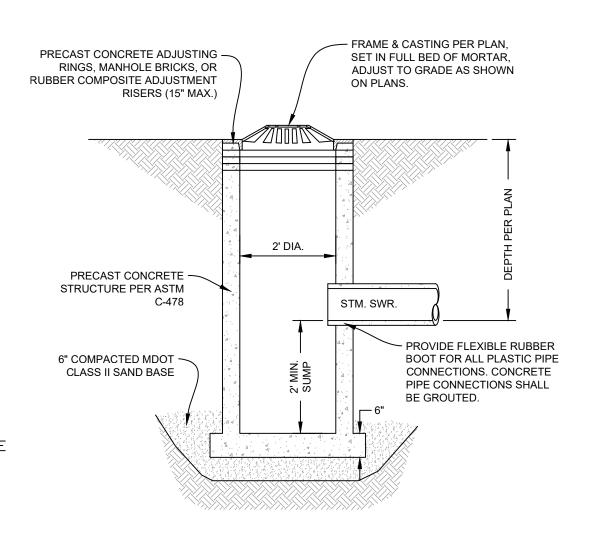

24" CATCH BASIN NO SCALE

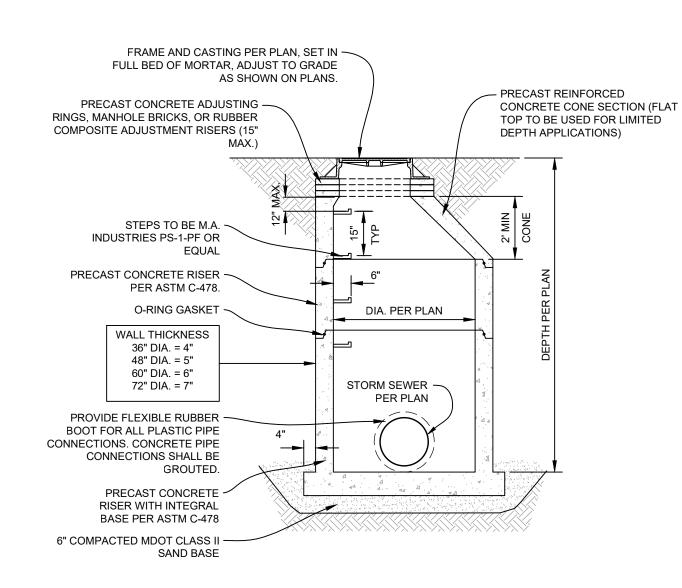


STORM MANHOLE NO SCALE

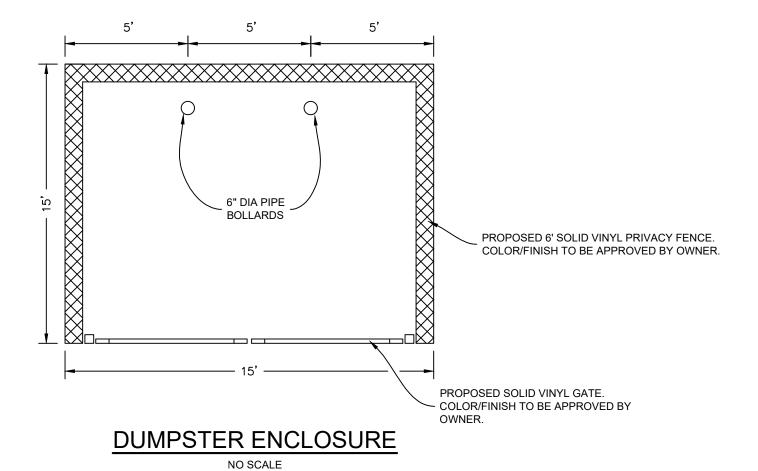


WIDTH AS PER PLANS PAVEMENT 1/4" R (TYP.) - SECTION AS CONCRETE PER PLANS DUMPSTER PAD 6 X 6 W2.9 X W2.9 WWF



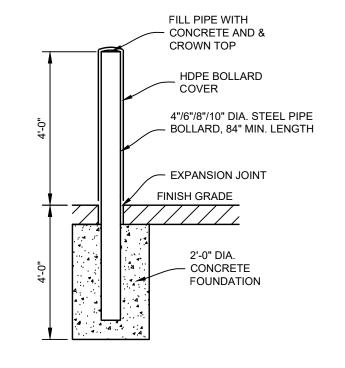

STEEL BOLLARD

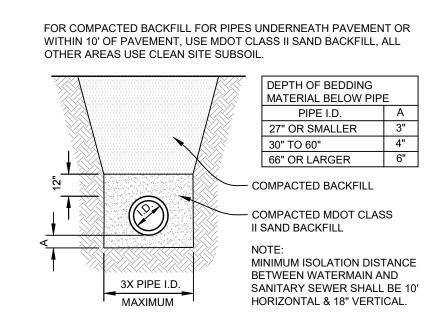

CLASS B PIPE BEDDING NO SCALE

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ISSUED FOR: ISSUED FOR REVIEW

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04-26-2024 D: JTC C: JMF TWP. SITE PLAN REVIEW 07-19-2024 D: WKT C: JMP TWP. SITE PLAN REVIEW 09-10-2024 D: WKT C: JMP SITE PLAN REVISION


09-30-2024 D: WKT C: JMP

Project Manager: JOHN TENPAS

Project # 2410092.1A Sheet Title:

DETAILS

C-501 7 of 7

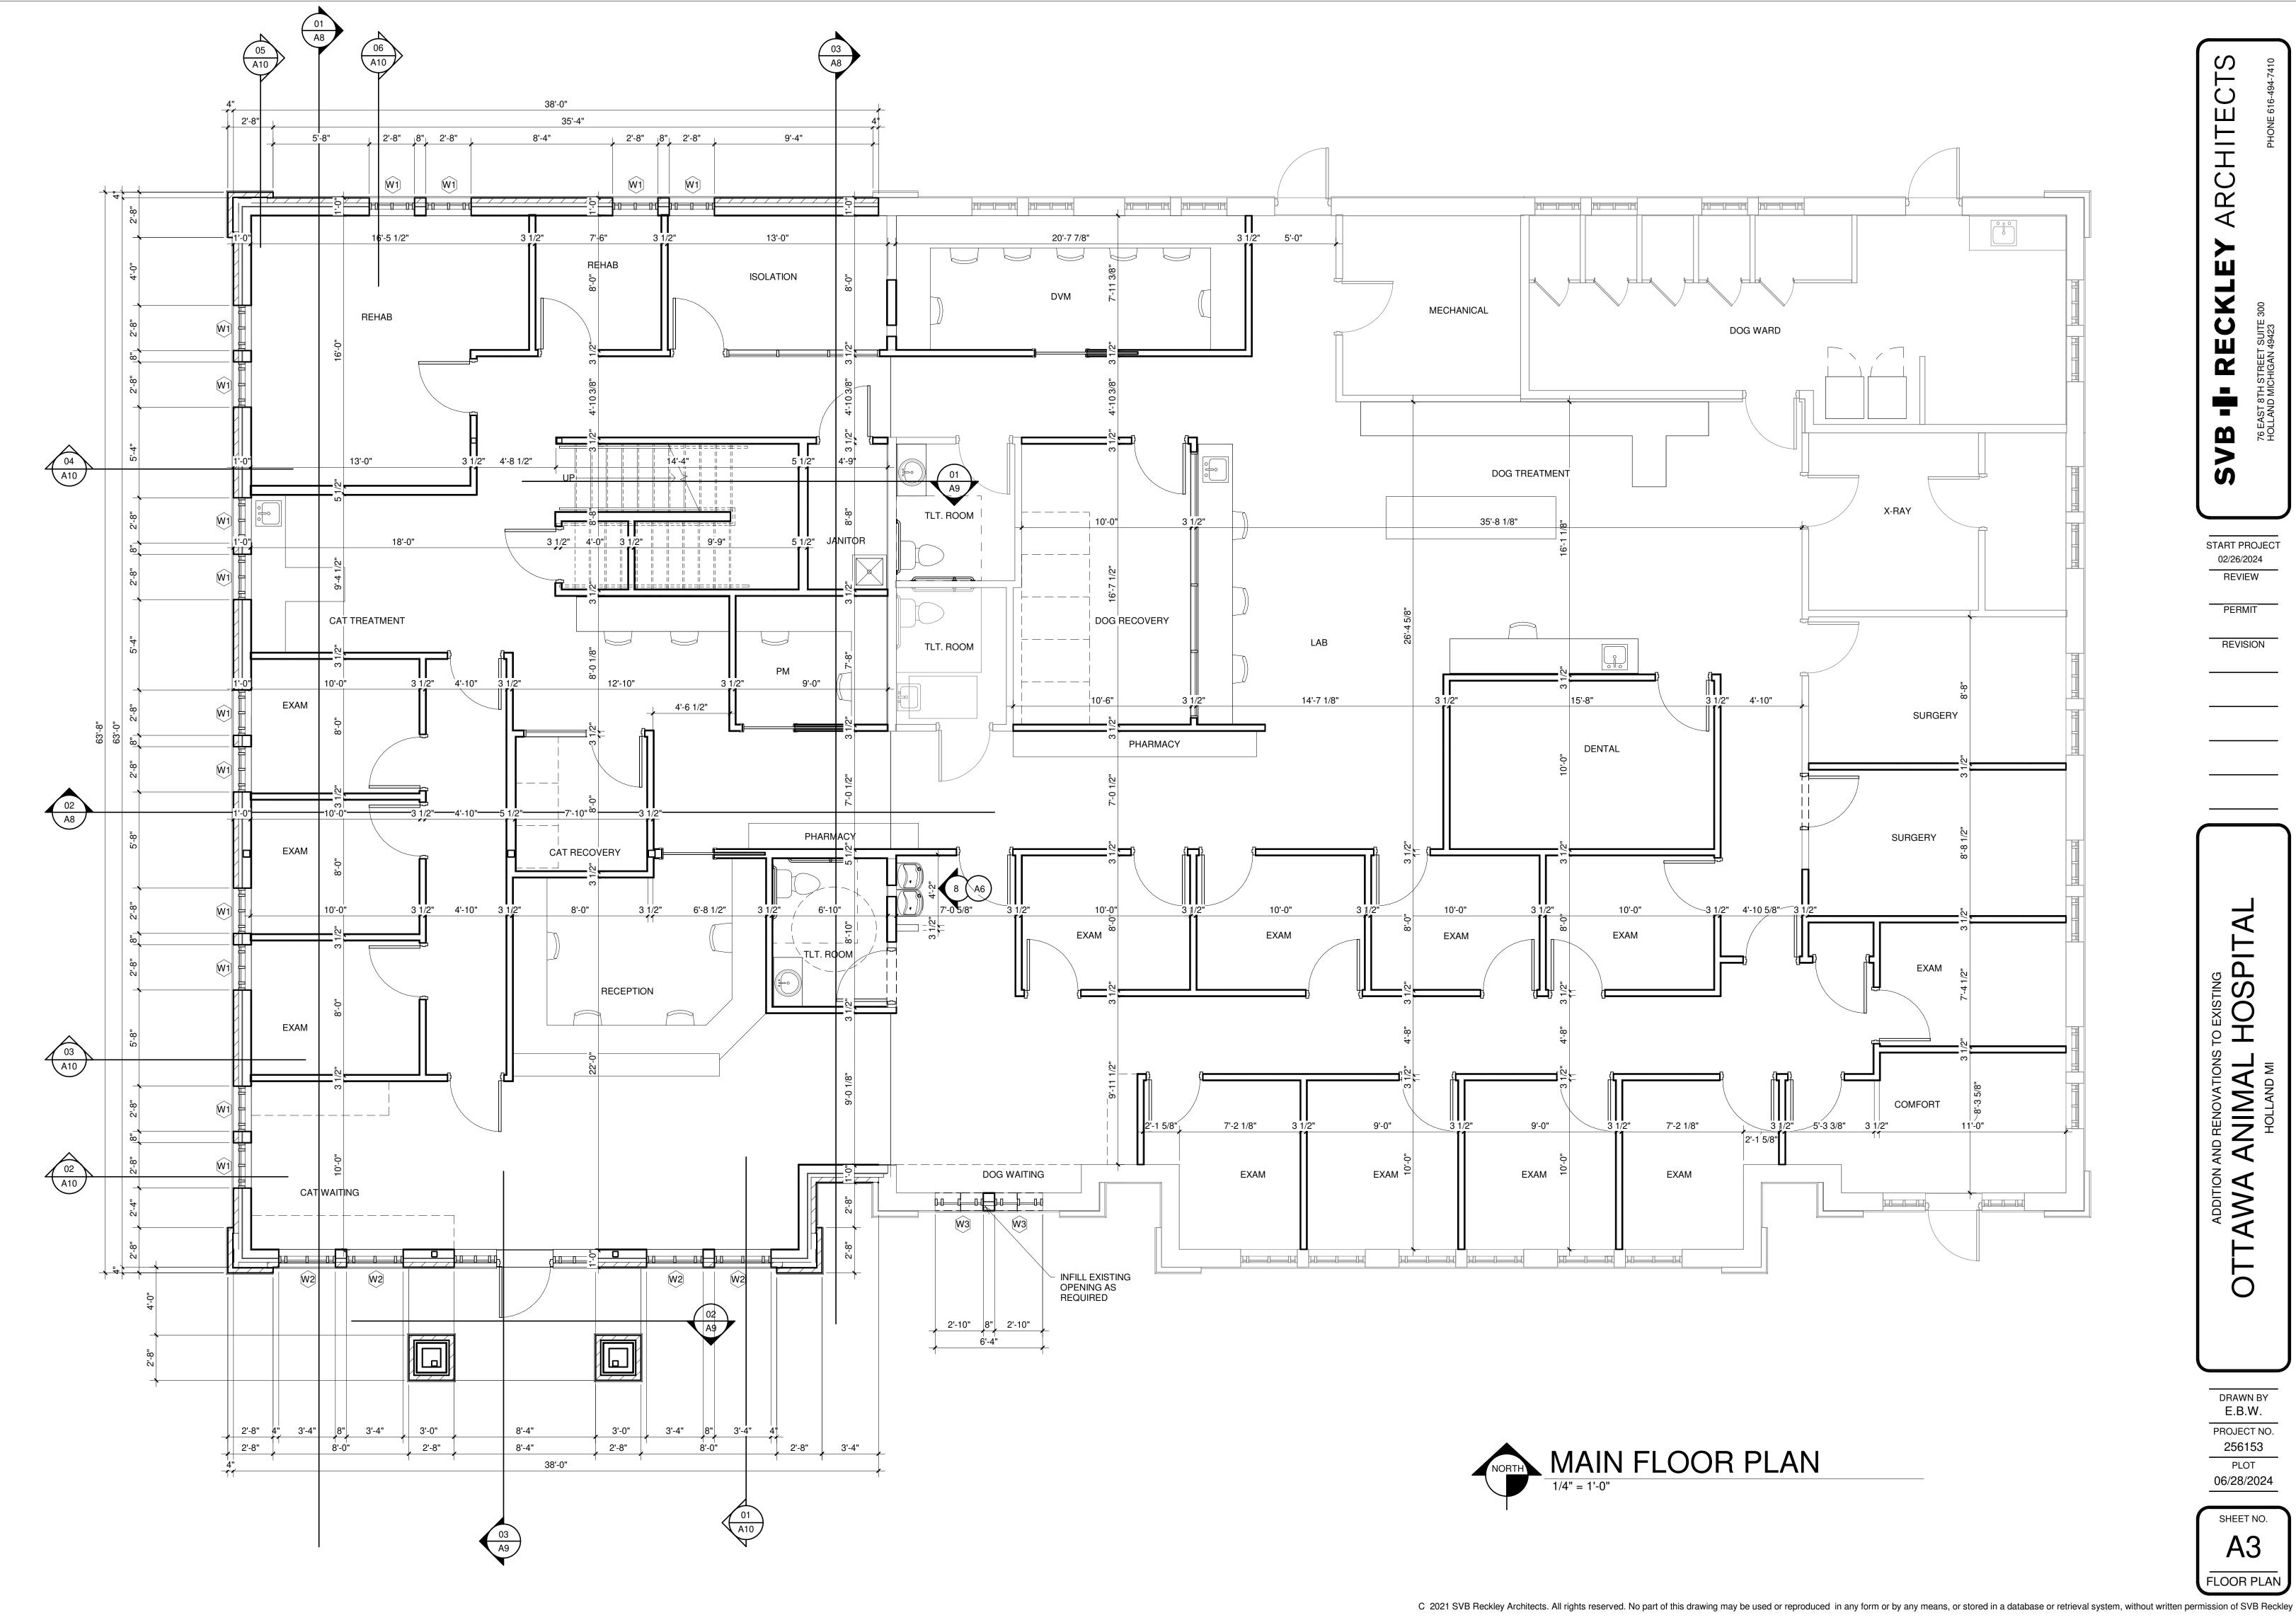


START PROJECT 02/26/2024

ADDITION AND RENOVATIONS TO EXISTING
OTTAWA ANIMAL HOSPITAL
HOLLAND MI

DRAWN BY E.B.W. PROJECT NO. 256153 PLOT 06/28/2024



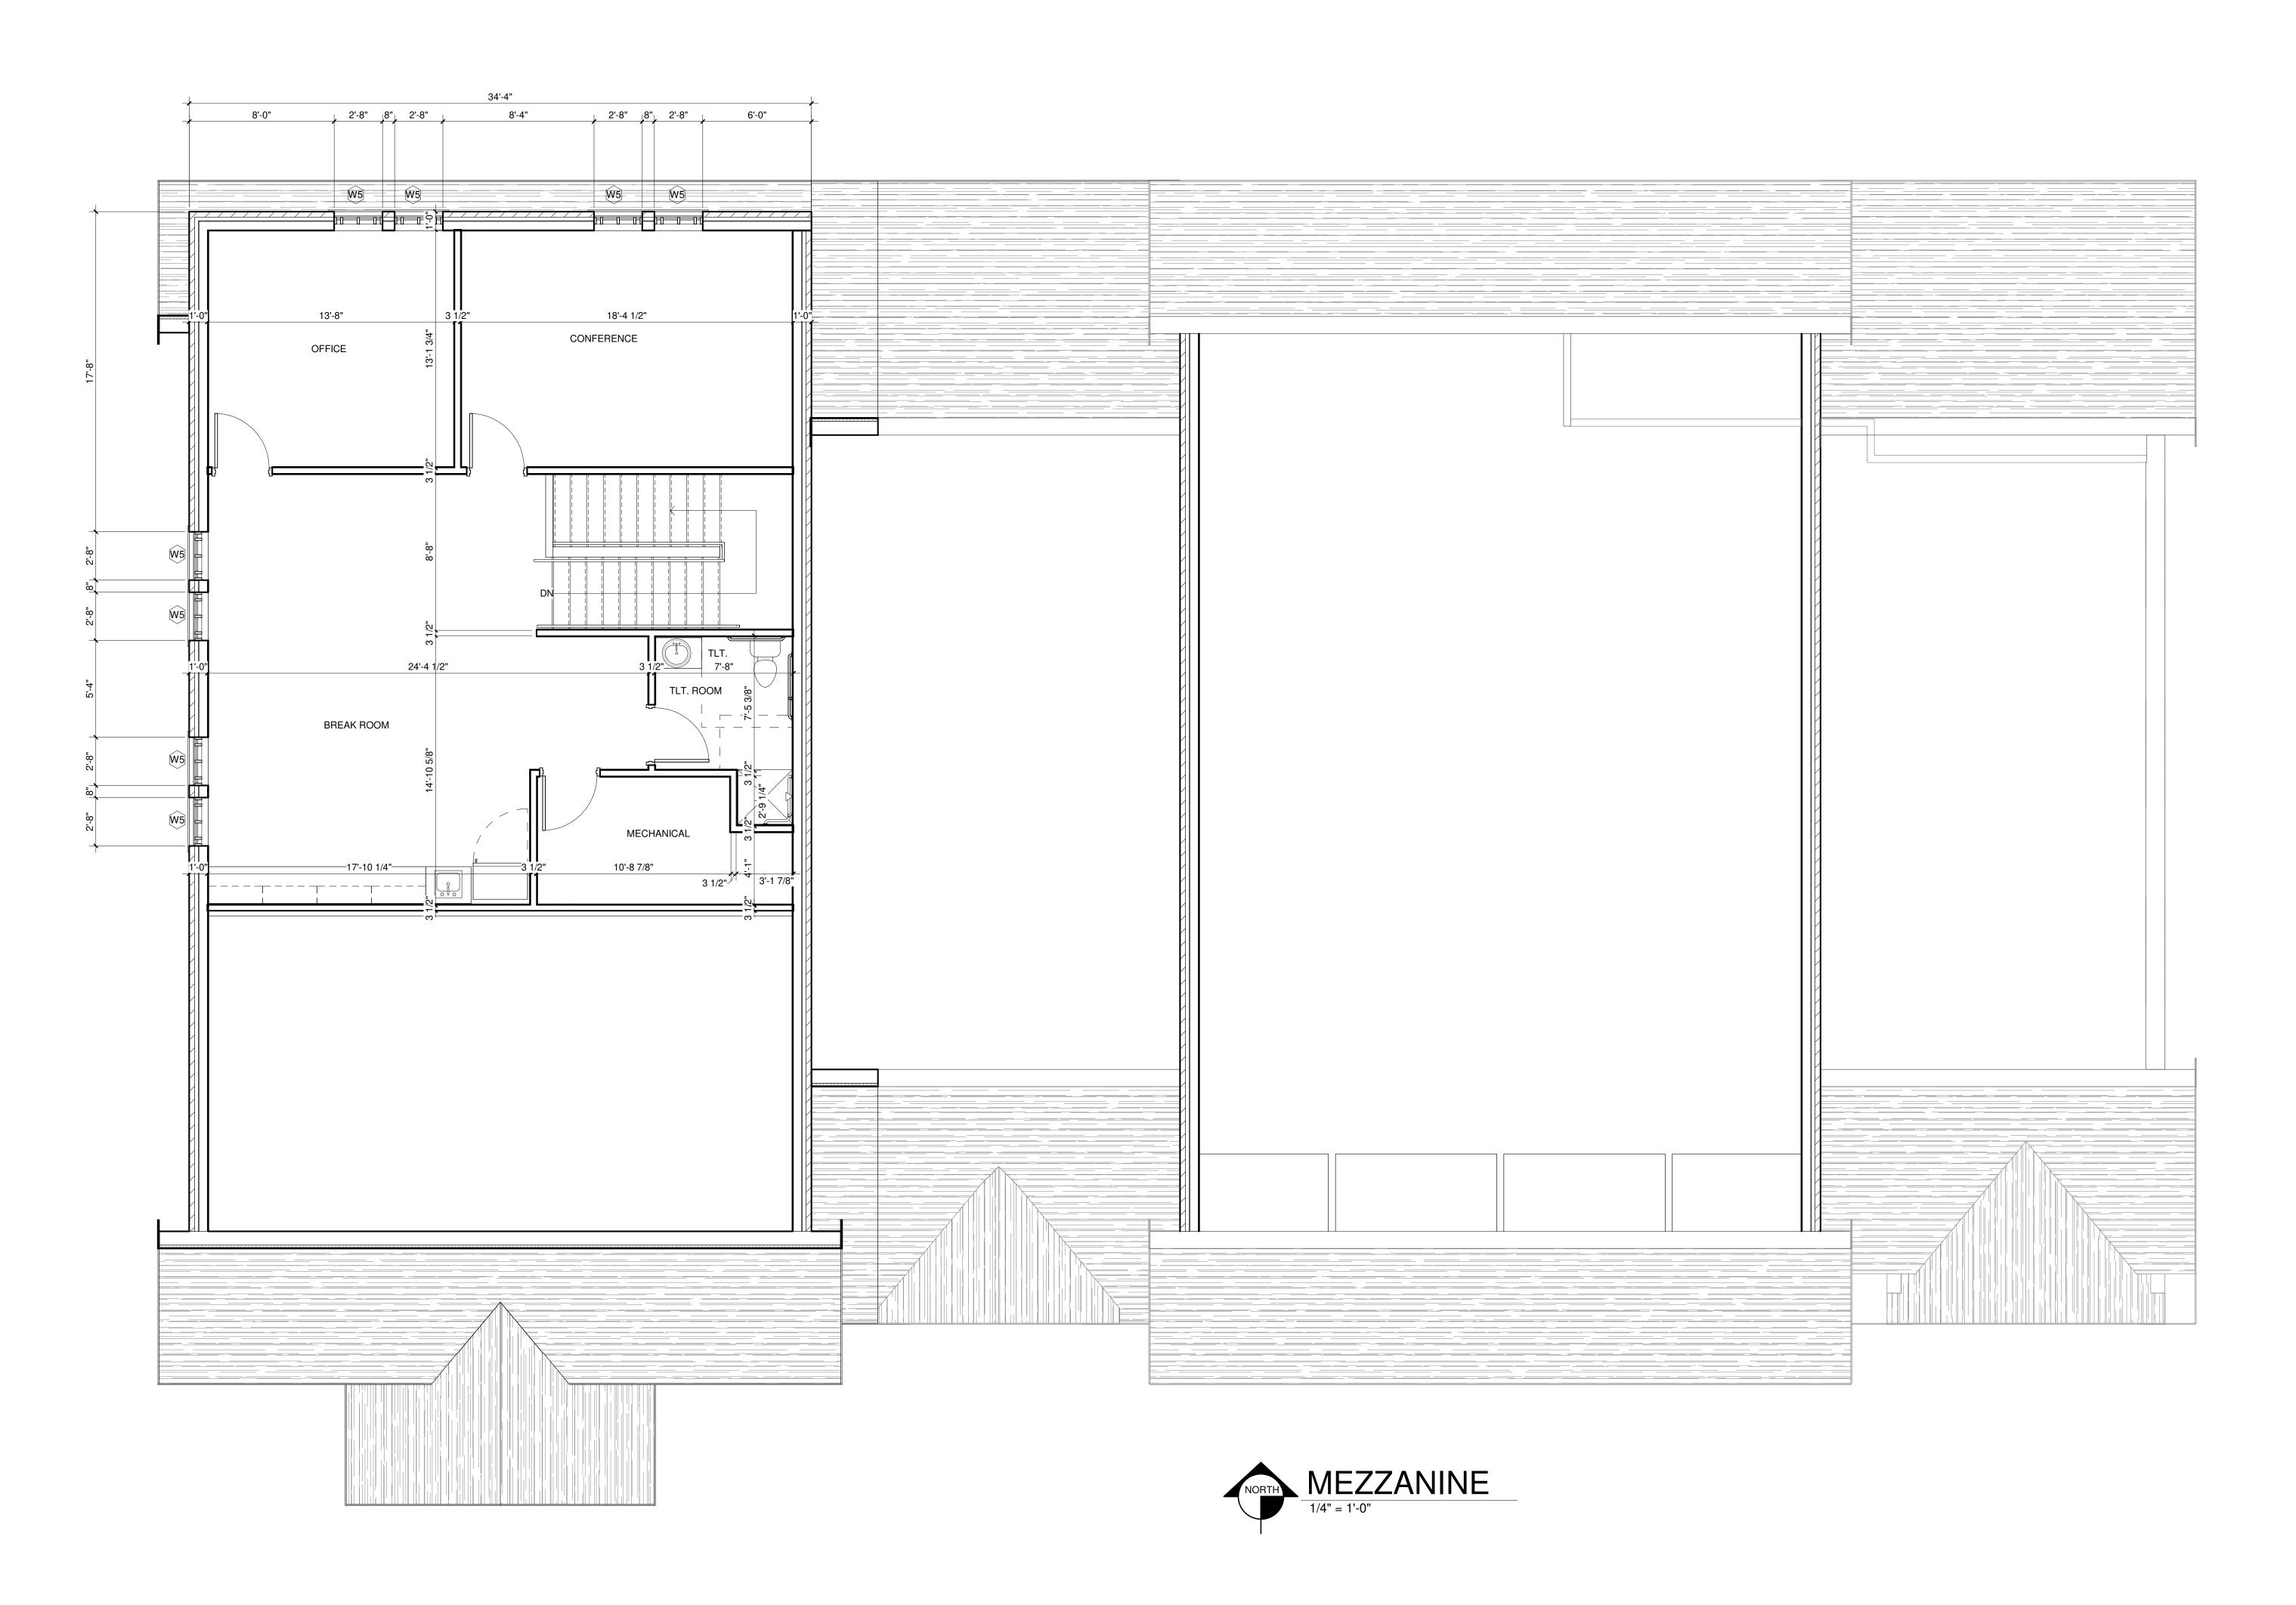

MA ANIMAL HOSPITAL
HOLLAND MI

 $\mathbf{\Omega}$

START PROJECT
02/26/2024
REVIEW

PERMIT

DRAWN BY
Author


PROJECT NO.
256153

PLOT



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Luminaire Schedule


Scenario: GEN

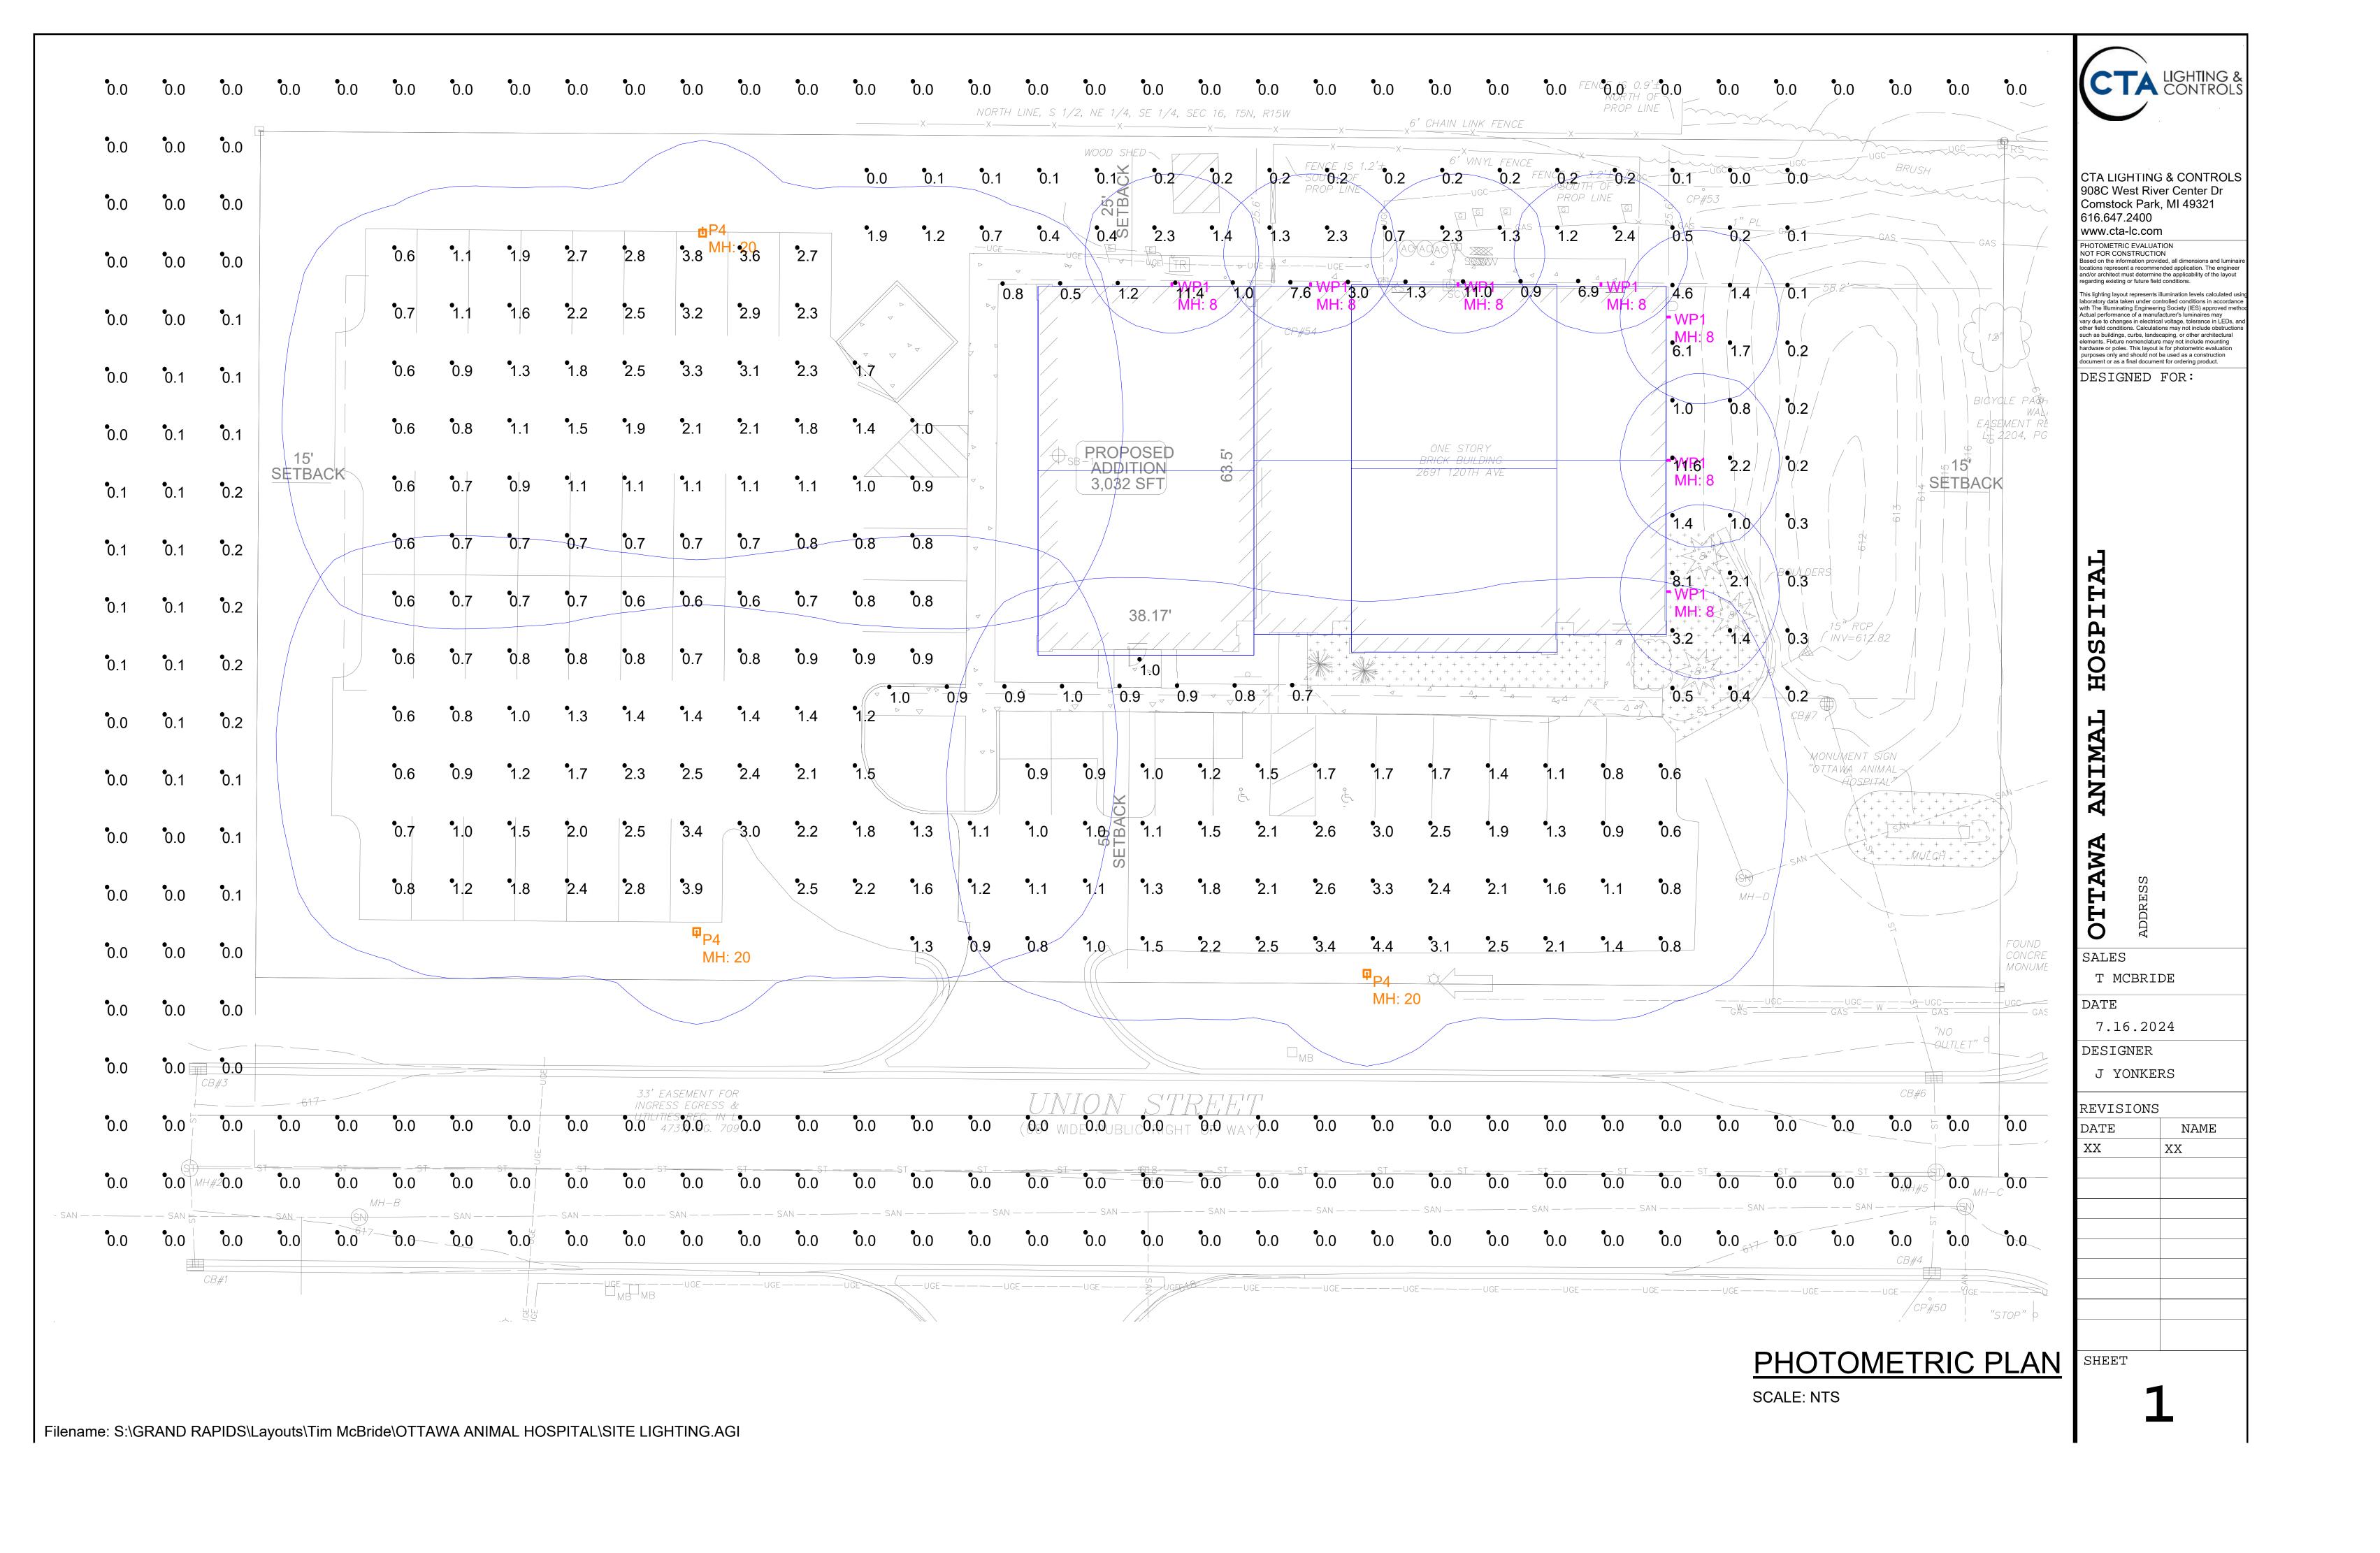SYMBOL	QTY	LABEL	ARRANGMENT	LLF	[MANUFAC]	DESCRIPTION	MNT HEIGH	T MNT TYPE	TLT WATTS	LUMENS
	7	WP1	Single	0.921	COOPER - LUMARK	XTOR1B	8	WALL	85.4	1418
	3	P4	Single	0.921	COOPER - LUMARK	PRV-PA2B-730-U-T4W-HSS	20	POLE	453	12816

Calculation Summary							
Scenario: GEN							
Label	CalcType	Units	Avg	Max	Min	Avg/Min	Max/Min
ENTRY	Illuminance	Fc	1.00	1.0	1.0	1.00	1.00
EXTERIOR	Illuminance	Fc	1.24	11.6	0.0	N.A.	N.A.
LIGHT TRESPASS	Illuminance	Fc	0.01	0.2	0.0	N.A.	N.A.
PARKING LOT	Illuminance	Fc	1.52	4.4	0.6	2.53	7.33
SIDEWALK	Illuminance	Fc	2.77	11.4	0.5	5.54	22.80

NOTES:

- CALC AT GRADE
- ALL FIXTURES ARE 3000K

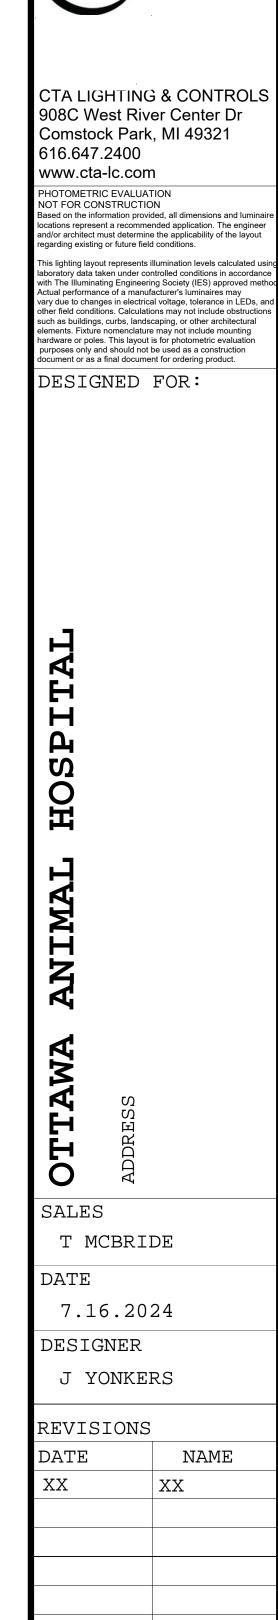

REVISIONS NAME

SHEET

