

# APPLICATION FOR AN AMENDMENT TO A PLANNED UNIT DEVELOPMENT FINAL DEVELOPMENT PLAN APPROVAL

353 North 120th Avenue · Holland, MI 49424 · Phone: 616.395.0151 · www.hct.holland.mi.us

Applicant Informa	tion		
Contact Name Tor	n Vroon	Company	T2 Properties
Address 95 Cros	sswind Drive	Phone	
Holland	, MI 49424	Email	er er
Owner Information			
Contact Name san	ne	Company	
Address		Phone	
		Email	
Plan Preparer Info	rmation		
Contact Name Bru	ce Zeinstra	Company	Holland Engineering, Inc
Address 220 Ho	over Blvd	Phone	F
Holland	, MI 49423	Email	
Property Informati	on		
PUD Project Name	The Crossings PUD		
Address or Location	11555 Crossings Ct and vacant	lot 4 of the	Crossings
Parcel Number	70 - 16 - <u>22 - 271 - 011</u>		trict PUD/C-2
Acreage of Parcel	2.8+/- (total PUD)		be Developed 1.25
Present Use (s)			sonal storage, etc.
Description of Prop	osed Use (attach additional pages as needed		
Proposed use	on lot 4 will be Contractors Facili	ty and outdo	poor storage. Request to modify
			nd allow contractor facility and
	e on lot 4.		
approval, and that the	re information on the materials submitted are referred to the requirements.	e true and accura	0.000
			Check No
Planning Commissi	on 1st Discuss on//	Planning Com	mission Action on//
Application Accept	ed by		

# NARRATIVE STATEMENT - The Crossings PUD Amendment

Owners are requesting an amendment to The Crossing PUD to construct a 12,000 square foot building for up to 6 contractor facility spaces and Outdoor Storage area on Lot 4, which is part of the existing The Crossings PUD. The owners are both small business owners and intend to occupy 2 of the spaces (Holland Leatherworks and Vroon Construction). The remaining spaces will be marketed for sale.

## The amendment requested is for:

- 1. Revert the building setbacks for Lot 4 back to the C-2 standards
- 2. Allow the uses of Contractor Facility and Outdoor Storage on Lot 4
- 3. Modify the parking calcs to be 1 space per 145 sf for Lots 2 & 3 and 1 space per 720 sf on Lot 4.

# Standards for approval:

- A. Intent & Qualification: The PUD was approved in 2016 and allowed flexibility for mixed uses, parking, and front yard setbacks to promote and encourage businesses in the area. The PUD is consistent with the Holland Charter Township Comprehensive Plan. The PUD has an existing condominium project on Lots 2 and 3, but Lot 4 will be a separate condominium project. There is an existing share parking agreement, which will be updated upon the approval of this amendment. This PUD project was previously approved to have a mix of uses from the commercial and industrial zoning districts, quality architecture, and enhancement of the existing features and adjacent uses. Uses: The uses in the PUD will be a mix of Commercial and Industrial uses that are consistent with the zoning ordinance.
- B. Design: The PUD is and will be harmonious and appropriate with the existing character and land uses in the general vicinity.
- C. Character: The PUD will not change the essential character of the surrounding area.
- D. Impact: The PUD will not be hazardous to adjacent property or involve uses, activities, materials, or equipment that will be detrimental to the health, safety, and welfare of the persons or property through the excessive production of traffic, noise, smoke, fumes, or glare.
- E. Public Service Capacity: The PUD will not place demands on the public services and facilities more than current or anticipated future capacity.
- F. Utilities: Underground utilities will be utilized in the PUD and the appurtenances to these systems will be screened or placed in inconspicuous locations.

# **Crossing Court Condominium Association**

November 3, 2025

Corey Broersma
Community Development Director
Holland Charter Township
353 North 120th Avenue
Holland, MI 49424

RE: PUD Amendment for Crossings Court

# Dear Corey:

I am the President of the Crossing Court Condominium Association (the "Association"). We are writing in support of the proposed PUD Amendment for Crossings Court that is being proposed by T2 Properties, LLC and Tom Vroon. The Board for the Association has reviewed the proposed site plan, including the modified building envelope and building location, and modified parking areas, and do not have any objections to the request. We also do not have any objections to the proposed uses for the units in the new building.

There is an existing Easement Agreement for shared parking between the Association and the proposed new building, which will continue. If the PUD Amendment is approved, the Parking Easement will be amended to reflect the modified parking areas.

Sincerel

Please let us know if you have any questions.

Brian Holt, Président

# THE CROSSINGS COURT PHASE 2

**CROSSINGS COURT** HOLLAND, MI 49424


# ZONING

1 SPACE PER UNIT x 6 UNITS = 6 SPACES

1,700 SF / 2,000 = 1 SPACE EPR UNIT x 6 UNITS = 6 SPACES

# PARKING PROVIDED:

16 SPACES INCLUDING 1 BARRIER FREE SPACE.

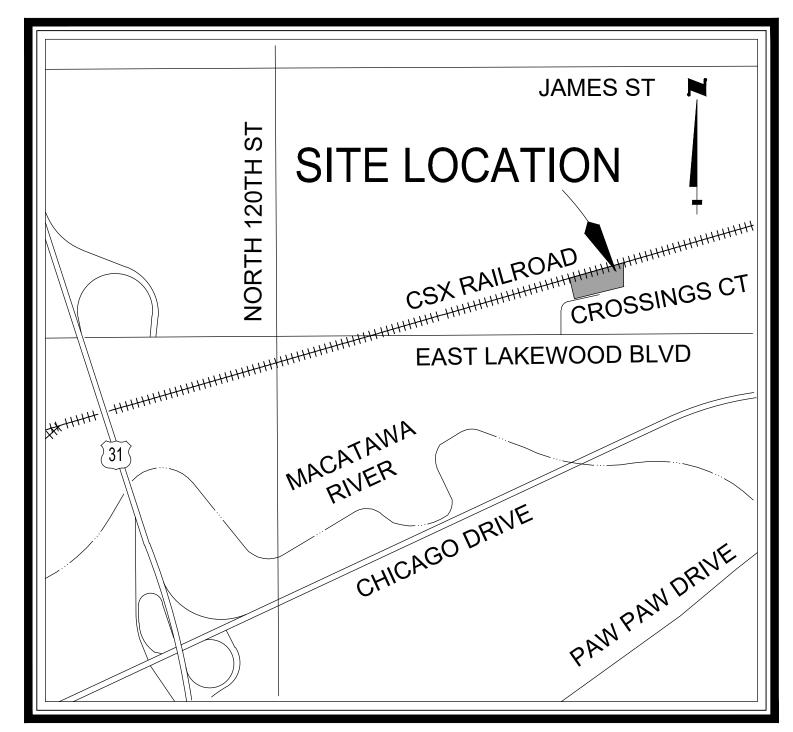

LOCATION MAP NOT TO SCALE

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SHEET G-100	COVER SHEET
SHEET V-101	EXISTING CONDITIONS
SHEET CD-101	CIVIL DEMOLITION PLAN
SHEET C-101	SITE LAYOUT PLAN
SHEET C-201	GRADING, DRAINAGE & SESC PLAN
SHEET C-501	GENERAL DETAILS

SHEET L-101 LANDSCAPE PLANTING PLAN

# PARCEL DESCRIPTION

PER CHICAGO TITLE INSURANCE COMPANY COMMITMENT NUMBER: 701260930CML COMMITMENT DATE: JULY 29, 2025

PART OF LOTS 3 AND 4, THE CROSSINGS, ACCORDING TO THE RECORDED PLAT THEREOF, AS RECORDED IN LIBER 42 OF PLATS, PAGE 59, OTTAWA COUNTY RECORDS, DESCRIBED AS: BEGINNING AT THE SOUTHWEST CORNER OF SAID LOT 4; THENCE NORTHWESTERLY 76.65 FEET ALONG A 70.00 FOOT RADIUS CURVE TO THE LEFT, SAID CURVE HAVING A CENTRAL ANGLE OF 62 DEGREES 44 MINUTES 07 SECONDS, AND A CHORD THAT BEARS NORTH 48 DEGREES 34 MINUTES 43 SECONDS WEST 72.87 FEET ALONG THE NORTHERLY RIGHT-OF-WAY LINE OF CROSSINGS COURT; THENCE NORTH 10 DEGREES 03 MINUTES 14 SECONDS EAST 23.41 FEET; THENCE NORTH 15 DEGREES 40 MINUTES 13 SECONDS WEST 141.65 FEET, PARALLEL WITH THE WEST LINE OF SAID LOT 3; THENCE NORTH 74 DEGREES 29 MINUTES 34 SECONDS EAST 281.26 FEET ALONG THE NORTH LINE OF SAID LOTS 3 AND 4; THENCE SOUTH 00 DEGREES 03 MINUTES 47 SECONDS WEST 226.48 FEET ALONG THE EAST LINE OF SAID LOT 4; THENCE SOUTH 72 DEGREES 47 MINUTES 15 SECONDS WEST 190.48 FEET ALONG THE SOUTH LINE OF SAID LOT 4 TO THE POINT OF BEGINNING.



RYAN T. YSSELDYKE Vertical Datum Horz. Datum LOCAL NGVD '29 PETER BULTEN, P.E. Civil L. A. HEI Project Number 25-08-005 COVER SHEET G-100

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SUBJECT TO THE FOLLOWING ITEMS PER SCHEDULE B, EXCEPTIONS OF CHICAGO TITLE INSURANCE COMPANY COMMITMENT NUMBER: 701260930CML

- (7) EASEMENT(S), IF ANY, OVER AND ACROSS THE LAND DESCRIBED IN SCHEDULE A, TOGETHER WITH ALL RIGHTS APPURTENÀNT TO THE EASEMENT(S), AS MORE DEFINED AND SET FORTH IN MICHIGAN PUBLIC ACT 235 OF
  - THIS ITEM MAY AFFECT THE SUBJECT PARCEL AND IS SHOWN HEREON IN NOTE FORM ONLY.
- (9) RIGHTS OF THE PUBLIC TO ANY PORTION OF THE LAND LYING WITHIN THE BOUNDS OF ANY STREET, ROAD,

THIS ITEM DOES NOT AFFECT THE SUBJECT PARCEL AND IS NOT SHOWN HEREON.

(10) RIGHT(S) OF WAY AND/OR EASEMENT(S) AND RIGHTS INCIDENTAL THERETO AS DELINEATED OR AS OFFERED FOR DEDICATION, ON THE MAP OF SAID TRACT/PLAT.

THIS ITEM DOES AFFECT THE SUBJECT PARCEL AND IS SHOWN HEREON.

(11) RIGHTS OF OTHERS IN AND TO THE USE OF THE DRAIN LOCATED OVER, ACROSS, IN OR UNDER THE LAND, AND THE RIGHTS TO ENTER THE LAND TO MAINTAIN THE SAME.

THIS ITEM DOES NOT AFFECT THE SUBJECT PARCEL AND IS NOT SHOWN HEREON.

(12) RAILROAD LINE, SWITCH TRACKS, SPUR TRACKS, RAILWAY FACILITIES AND OTHER RELATED EASEMENTS, IF ANY, AND ALL RIGHTS THEREIN.

THIS ITEM MAY AFFECT THE SUBJECT PARCEL AND IS SHOWN HEREON IN NOTE FORM ONLY.

(13) RIGHT(S) OF WAY AND/OR EASEMENT(S) AND RIGHTS INCIDENTAL THERETO, AS GRANTED IN A DOCUMENT: GRANTED TO: CONSUMERS POWER COMPANY (NOW KNOWN AS CONSUMERS ENERGY) RECORDING NO: LIBER

THIS ITEM DOES AFFECT THE SUBJECT PARCEL AND IS SHOWN HEREON.

(14) RESTRICTIONS, TERMS, COVENANTS, AND CONDITIONS OF DECLARATION OF RESTRICTIONS AS SET FORTH RECORDING NO: LIBER 4371, PAGE 29

THIS ITEM DOES AFFECT THE SUBJECT PARCEL AND IS SHOWN HEREON IN NOTE FORM ONLY.

(15) EASEMENTS, TERMS, COVENANTS, AND CONDITIONS OF AGREEMENT FOR THE ESTABLISHMENT OF A COUNTY DRAIN AND COUNTY DRAINAGE DISTRICT PURSUANT TO SECTION 433 OF ACT NO. 40 OF THE PUBLIC ACTS OF 1956, AS AMENDED AS SET FORTH BELOW: RECORDING NO: LIBER 4556, PAGE 447

THIS ITEM DOES NOT AFFECT THE SUBJECT PARCEL AND IS NOT SHOWN HEREON.

(16) EASEMENTS, TERMS, COVENANTS, AND CONDITIONS OF DECLARATION AND GRANT OF EASEMENTS AS SET RECORDING NO: INSTRUMENT NO. 2016-0002776, AS AFFECTED BY THE FIRST AMENDED DECLARATION AND GRANT OF EASEMENTS RECORDED IN INSTRUMENT NO. 2016-0032637

THIS ITEM DOES AFFECT THE SUBJECT PARCEL AND IS SHOWN HEREON IN NOTE FORM ONLY.

# SURVEYOR'S NOTES

- THIS SURVEY WAS PREPARED FOR THE LANDS AS DESCRIBED. IT IS NOT A CERTIFICATION OF TITLE, ZONING OR FREEDOM OF ENCUMBRANCES.
- BEARINGS ARE BASED ON A LOCAL COORDINATE SYSTEM AND THE SOUTH LINE OF THE NORTHEAST 1/4 OF SECTION 22 HAVING A BEARING OF SOUTH 89°46'59" WEST.
- ELEVATIONS HEREON ARE BASED ON THE NATIONAL GEODETIC VERTICAL DATUM OF 1929 (NGVD '29).
- SOURCE BENCHMARK NATIONAL GEODETIC SURVEY (NGS) BENCHMARK DESIGNATION: E 25 PID: NG0014 ELEVATION = 616.16' (NAVD '88)

(ADJUSTED TO NGVD '29 ELEVATIONS)

- UTILITIES SHOWN HEREON ARE BASED UPON VISIBLE ABOVE GROUND OBSERVATIONS AND FIELD MARKING AS THE RESULT OF MULTIPLE MISS DIG TICKETS. THEY SHOULD NOT BE INTERPRETED TO BE EXACT LOCATIONS NOR SHOULD IT BE ASSUMED THAT THEY ARE THE ONLY UTILITIES IN THIS AREA. THIS SURVEY SHOULD NOT BE RELIED UPON TO DEPICT THE LOCATION OF ALL UNDERGROUND UTILITIES.
  - NOTE: CONNECTIVITY AS SHOWN HEREON IS BASED UPON BEST AVAILABLE INFORMATION, HOWEVER, LACKING EXCAVATION, THE EXACT LOCATION OF ALL UNDERGROUND FEATURES CANNOT BE ACCURATELY, COMPLETELY AND RELIABLY DEPICTED.
- 6 PER THE FLOOD INSURANCE RATE MAP CHARTER TOWNSHIP OF HOLLAND OTTAWA COUNTY, MICHIGAN MAP NUMBER: 26139C0312E EFFECTIVE DATE: DECEMBER 16, 2011

THE SUBJECT PARCEL LIES IN ZONE X, AREA OF MINIMAL FLOOD HAZARD, AND IS NOT IN AN AREA OF FLOOD HAZARD.

7 DATE OF FIELD SURVEY: AUGUST 15, 2025.


I, MARK O. SCOVILL, A LICENSED PROFESSIONAL SURVEYOR IN THE STATE OF MICHIGAN, HEREBY CERTIFY THAT I HAVE SURVEYED THE PARCEL(S) OF LAND DESCRIBED AND DELINEATED HEREON; THAT THE SURVEY MAP IS A TRUE REPRESENTATION OF THE SURVEY AS PERFORMED BY ME; THAT SAID SURVEY WAS PERFORMED RESULTING WITH A RELATIVE POSITIONAL PRECISION AT EACH BOUNDARY CORNER SHOWN HEREON WITHIN LIMITS ACCEPTED BY THE PRACTICE OF PROFESSIONAL SURVEYING. THIS SURVEY WAS MADE FROM THE ATTACHED LEGAL DESCRIPTION. THE DESCRIPTION WAS GIVEN TO US BY OTHERS, OR WAS PREPARED BY US FROM INFORMATION OR DOCUMENTS GIVEN TO US BY OTHERS, AND SHOULD BE COMPARED WITH THE ABSTRACT OF TITLE OR TITLE INSURANCE POLICY FOR ACCURACY, EASEMENTS OR EXCEPTIONS.

HOLLAND ENGINEERING, INC. 220 HOOVER BOULEVARD HOLLAND, MICHIGAN 49423 (616) 392-5938

mark o. Dewill

MARK O. SCOVILL MICHIGAN PROFESSIONAL SURVEYOR #4001045504



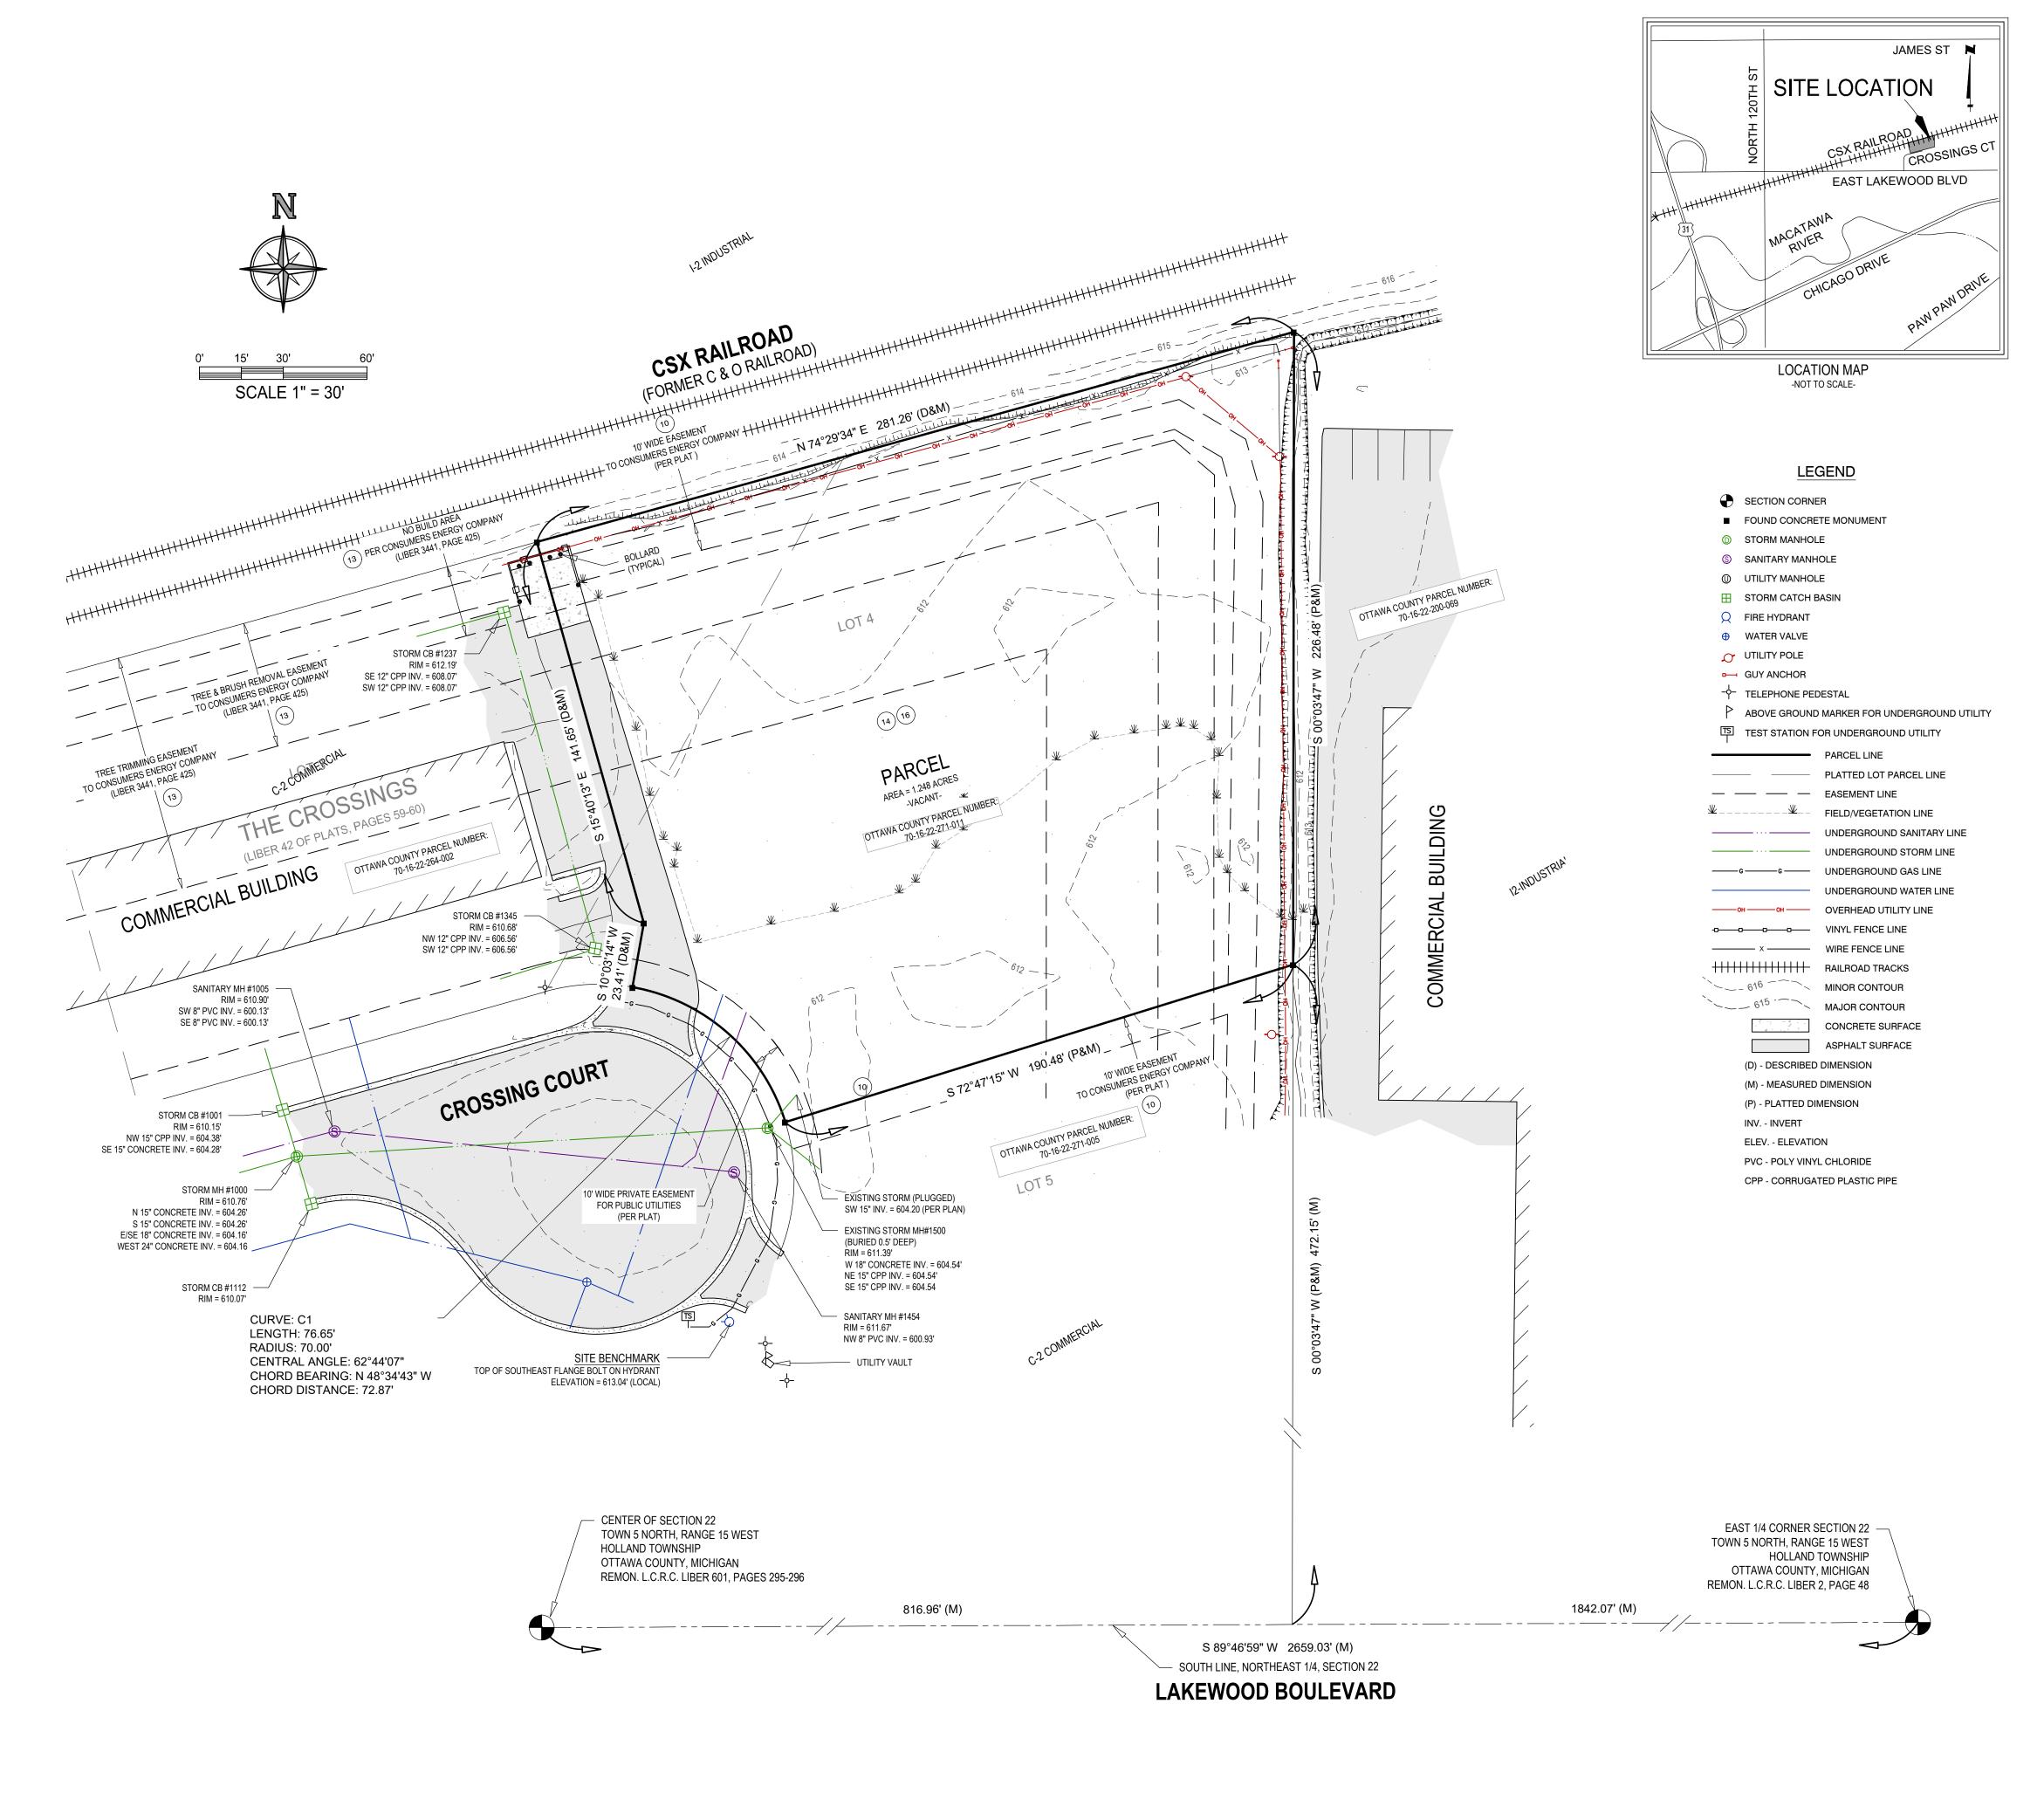

Project Manager RYAN T. YSSELDYKE


Vertical Datum Horz. Datum NGVD '29 LOCAL Drawn by JOHN M. RANKIN Checked by Survey L. A. HEI Project Number 25-08-005


EXISTING CONDITIONS

Civil

Struc.

V-101

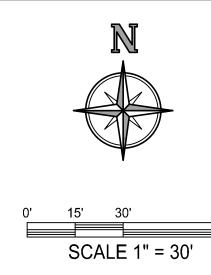

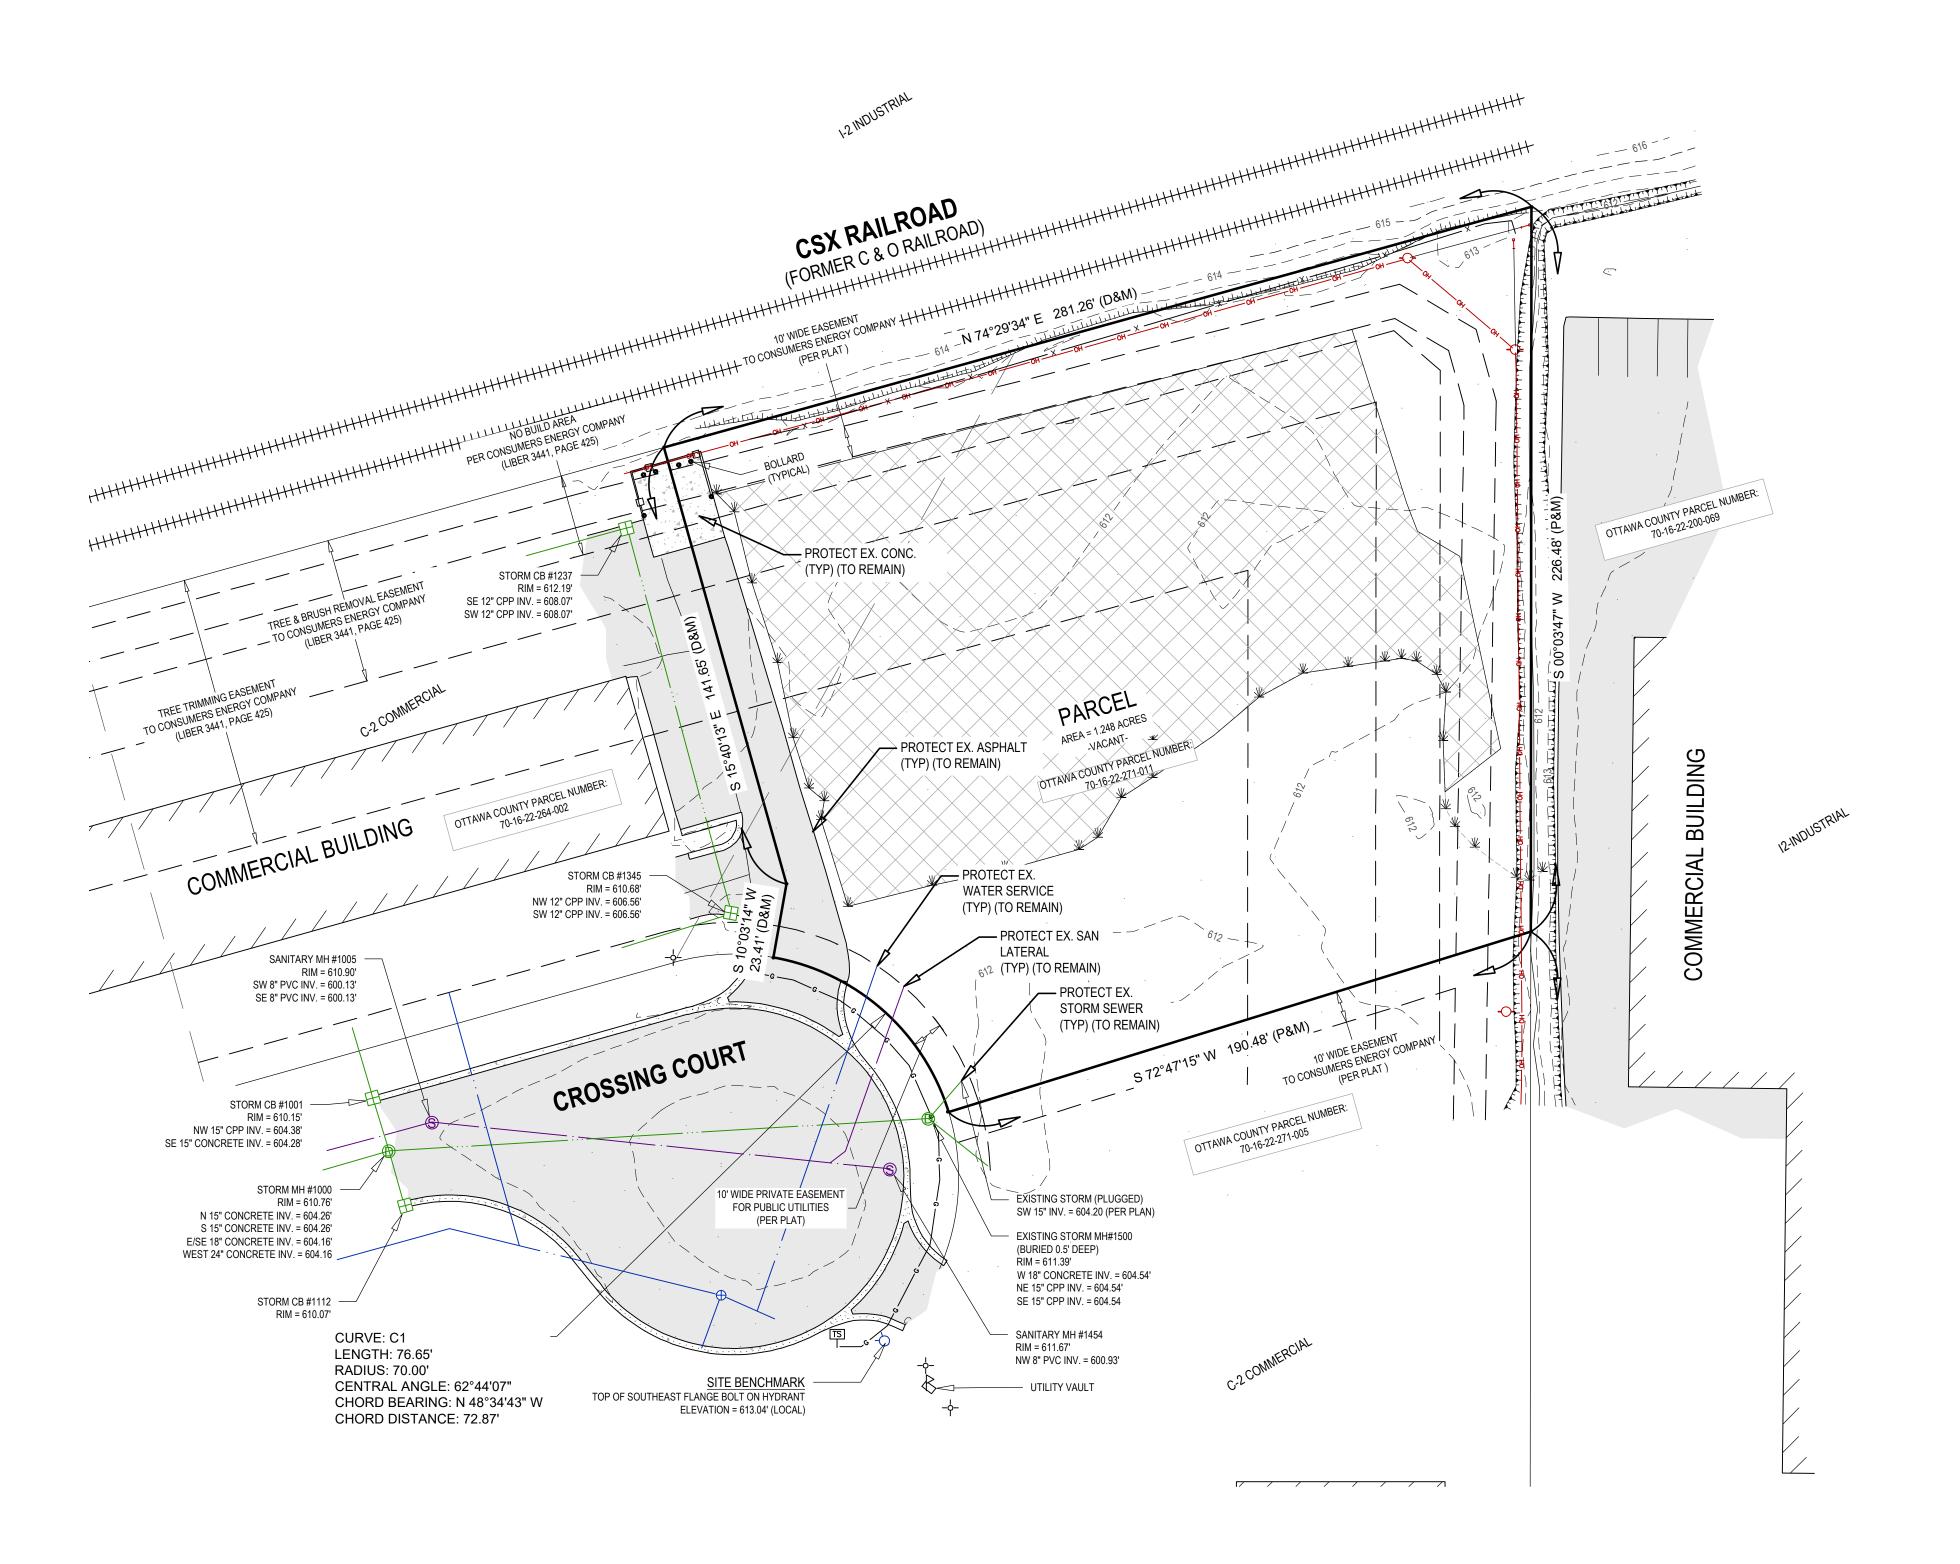

# **DEMO LEGEND**

X X X X X UTILITY REMOVAL

CIVIL DEMOLITION NOTES:

- 1. SEE BOUNDARY AND TOPOGRAPHIC SURVEY SHEET FOR PROPERTY, EASEMENT, BENCHMARK, ETC.
- 2. LOCATION OF UNDERGROUND UTILITIES HAVE BEEN SHOWN BASED ON SURFACE EVIDENCE AND RECORD INFORMATION AVAILABLE. IT IS THE CONTRACTOR'S RESPONSIBILITY TO VERIFY UTILITY LOCATIONS PRIOR TO CONSTRUCTION.
- FROM DAMAGE, SHOULD ANY DAMAGE OCCUR, CONTRACTOR SHALL MAKE ALL NECESSARY REPAIRS AT NO COST TO THE OWNER. THE PAVED ROADWAY SHALL BE SWEPT CLEAN AS NEEDED, BUT AT LEAST ONCE A WEEK.
- 4. CONTRACTOR SHALL PROVIDE BARRIERS, AS NECESSARY, TO PREVENT PEDESTRIAN AND VEHICULAR TRAFFIC FROM ENTERING THE CONSTRUCTION SITE.
- 6. REMOVAL ITEMS ARE SHOWN BASED ON BEST AVAILABLE INFORMATION AND ARE SHOWN
- APPURTENANCES. CONTRACTOR SHALL CONFIRM UTILITY LINES REMOVED WILL NOT IMPACT
- NEXT JOINT BEYOND THE LIMITS OF REMOVAL. ALL REMOVALS SHALL BE PERFORMED BY
- EQUIPMENT, STORE, STOCKPILE, OR PARK WITHIN DRIP LINE. HOLD NECESSARY DISTURBANCE TO

- PROPERTY OWNER AND UTILITY PROVIDER.
- 13. ALL WORK IN ROAD RIGHTS OF WAY SHALL BE COMPLETED IN ACCORDANCE WITH MDOT, OTTAWA
- 14. THERE ARE EXISTING WETLAND AREAS ON THE PROPERTY. THESE WETLAND AREAS SHALL NOT BE DISTURBED. SHOULD DISTURBANCE TO THE WETLAND AREAS BECOME NECESSARY,
- 15. THE PROPERTY IS ENCUMBERED BY A 100-YEAR FLOODPLAIN. CONTRACTOR SHALL NOT DISTURB
- 16. SEE OTHER SHEETS IN PLAN SET FOR MORE INFORMATION.

TALL GRASS

TREE REMOVAL

CONCRETE / ASPHALT REMOVAL

INFORMATION.

3. DURING CONSTRUCTION, CONTRACTOR SHALL PROTECT ALL EXISTING AND NEW CONSTRUCTION


- 5. CALL MISS DIG AT LEAST THREE (3) WORKING DAYS PRIOR TO STARTING ANY EXCAVATION.
- SCHEMATICALLY. THE CONTRACTOR SHALL VISIT THE SITE PRIOR TO VERIFY THE EXTENT OF WORK 7. REMOVE ALL STRUCTURES, CONCRETE CURB, CONCRETE PAVING, ASPHALT PAVING, TREES,
- STUMPS, UTILITIES, AND OTHER EXISTING SITE FEATURES WITHIN THE LIMITS OF DEMOLITION. ALL DEMOLITION MATERIALS SHALL BE REMOVED FROM THE SITE UNLESS OTHERWISE NOTED AND DISPOSED OF IN A MANNER ACCEPTABLE TO THE LOCAL AUTHORITY HAVING JURISDICTION. 8. ALL UTILITY LINES SHOWN "X" OUT SHALL BE PHYSICALLY REMOVED ALONG WITH STRUCTURES AND
- 9. ALL REMOVALS OF PAVEMENT, CONCRETE, CURB AND GUTTER, ETC. SHALL BE PERFORMED TO THE
- 10. PROTECT ALL TREES AND SHRUBS NOT SCHEDULED FOR REMOVAL. DO NOT OPERATE
- 11. ALL TREE STUMPS SHALL BE REMOVED TO BELOW GRADE BY EITHER GRINDING OR COMPLETE REMOVAL IN ALL CASES NO WOODCHIPS AND/OR STUMPS SHALL BE LEFT IN PLACE.
- 12. IT IS THE CONTRACTOR'S RESPONSIBILITY TO COORDINATE ALL UTILITIES REMOVALS WITH
- COUNTY COUNTY ROAD COMMISSION, AND HOLLAND TOWNSHIP.
- CONTRACTOR SHALL ACQUIRE A PERMIT FROM THE EGLE PRIOR TO ANY DISTURBANCE. THE FLOODPLAIN AREA UNLESS A EGLE / USACE JOINT PERMIT HAS BEEN ACQUIRED FOR THE DISTURBANCE.


VROON CONSTRUCTION

Project Manager RYAN T. YSSELDYKE Vertical Datum Horz. Datum NGVD '29 LOCAL Drawn by PETER BULTEN, P.E.

Civil L. A. HEI Project Number

25-08-005 CIVIL **DEMOLITION** 

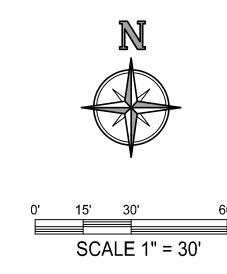

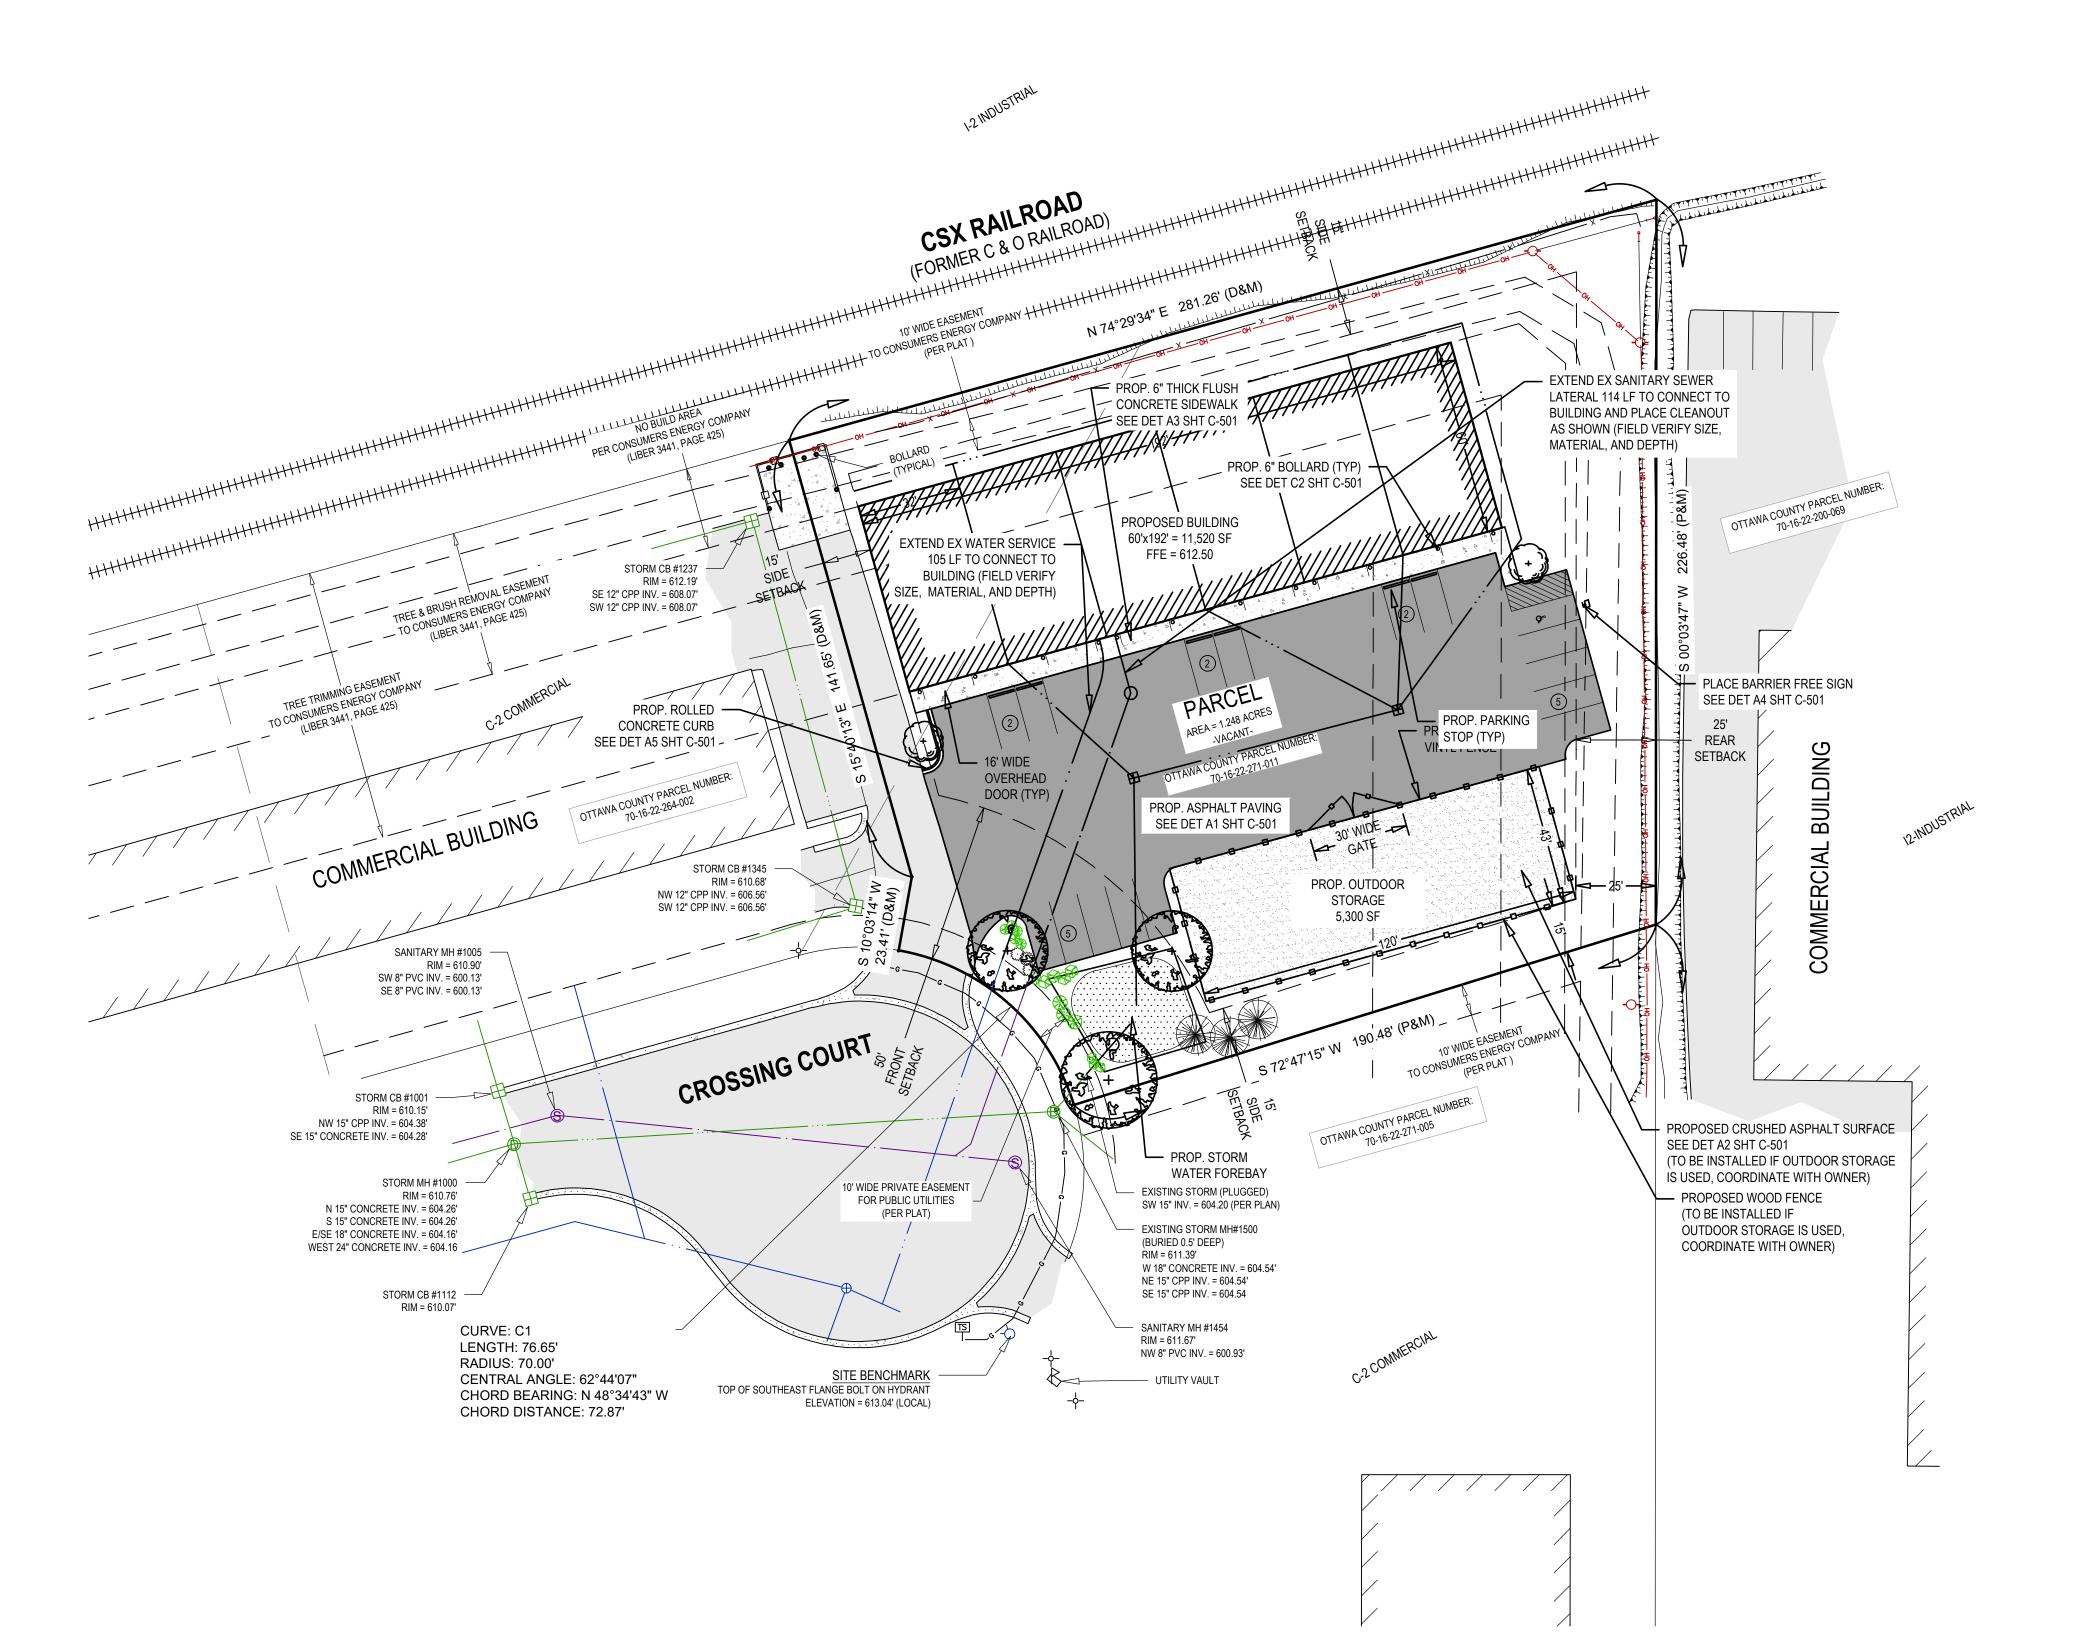

# **ZONING: C-2 COMMERCIA**

SETBACKS:

- FRONT: 50'
- SIDE: 15' OR 50' ABUTTING RESIDENTIAL
- REAR: 25' OR 50' ABUTTING RESIDENTAIL

MAX BUILDING COVERAGE: 25% MAX BUILDING HEIGHT: 35' / 50' WITH INCREASE SETBACK

PARKING REQUIREMENTS: 9'x18' WITH 24' AISLE

- OFFICE: 1 SPACE PER 300 SF •• 1 SPACE PER UNIT X 6 UNITS = 6 SPACES
- WAREHOUSE: 1 SPACE PER 2,000 SF
- •• 1,700 SF / 2,000 = 1 SPACE EPR UNIT X 6 UNITS = 6 SPACES

# OUTDOOR STORAGE: SETBACKS:

- FRONT: 50'
- SIDE: 15' TO NON-RESIDENTIAL
- REAR: 25' TO NON-RESIDENTIAL

SCREENING: ENCLOSED BY A 6' HIGH OPAQUE PRIVACY FENCE OR COMPARABLE EVERGREEN VEGETATIVE SCREEN, BERM, OR COMBINATION.

SURFACE OF STORAGE AREA SHALL BE ASPHALT OR CONCRETE; OR ALTERNATIVE MATERIAL SUCH AS GRAVEL OR CRUSHED ROCK THAT IS PROPERLY DRAINED, MINIMAL DUST, MAINTAIN CHARECTER OF DEVELOPMENT, AND MAINTAINED FREE OF WEEDS AND GRASS.

# **DEVELOPMENT SUMMARY**

LOT AREA: 1.248 ACRES (54,383 SF) PROPOSED BUILDING: 60' x 192' = 11,520 SF BUILDING COVERAGE: 11,520 / 54,383 = 21.2%

PARKING PROVIDED: 16 SPACES INCLUDING 1 BARRIER FREE SPACE

# STORAGE AREA:

- PROPOSED 6' TALL SOLID VINYL FENCE
- PROPSOED SURFACE TO BE CRUSHED ASPHALT MILLINGS

# LAYOUT & UTILITY NOTES:

- 1. SITE DESIGN WAS DEVELOPED IN ACCORDANCE WITH THE INFORMATION CONTAINED IN THE GEOTECHNICAL REPORT AND SOIL BORINGS COMPLETED FOR THE PROJECT. CONTRACTOR SHALL ACQUIRE A COPY OF THE GEOTECHNICAL REPORT AND SOIL BORING INFORMATION. SOIL CONDITIONS MAY VARY FROM THE GEOTECHNICAL INFORMATION, WHICH MAY AFFECT THE SITE DESIGN, EARTHWORK QUANTITIES, USABLE SOILS, AND SOIL EROSION AND SEDIMENTATION CONTROL PRACTICES. CONTRACTOR SHALL NOTIFY DESIGN ENGINEER AND GEOTECHNICAL ENGINEER IF SITE CONDITIONS VARY FROM SOILS INFORMATION CONTAINED IN THE GEOTECHNICAL
- 2. IT IS THE CONTRACTOR'S RESPONSIBILITY TO VERIFY THAT ALL NECESSARY PERMITS AND APPROVALS HAVE BEEN ACQUIRED PRIOR TO CONSTRUCTION.
- 3. CALL MISS DIG AT LEAST THREE (3) WORKING DAYS PRIOR TO STARTING ANY EXCAVATION. 4. CONTRACTOR SHALL CONTACT ENGINEER IF ANY DISCREPANCIES ARE DETERMINED BETWEEN SITE
- LAYOUT DIMENSIONS AND ACTUAL SITE CONDITIONS. 5. COORDINATE ALL UTILITY CONSTRUCTION WITH UTILITY PROVIDER, AS REQUIRED.
- 6. CONTRACTOR SHALL VERIFY THAT THERE ARE NO UTILITY CONFLICTS PRIOR TO CONSTRUCTION. 7. ALL SANITARY SEWER WORK SHALL BE CONSTRUCTED IN ACCORDANCE WITH THE CURRENT
- EDITION OF THE HOLLAND CHARTER TOWNSHIP WATER AND SEWER STANDARDS & SPECIFICATIONS. 8. ALL WATERMAIN, WATER SERVICES, AND FIRE PROTECTION LINES SHALL BE INSTALLED IN ACCORDANCE WITH THE CURRENT EDITION OF THE HOLLAND CHARTER TOWNSHIP WATER AND SEWER STANDARDS & SPECIFICATIONS.
- 9. ALL WORK WITHIN THE PUBLIC ROAD RIGHT-OF-WAY WILL REQUIRE A PERMIT AND OR APPROVAL FROM THE OTTAWA COUNTY ROAD COMMISSION AND SHALL BE CONSTRUCTED IN ACCORDANCE WITH THE CURRENT EDITION OF THEIR STANDARDS & SPECIFICATIONS.
- 10. COORDINATE ALL SIGNAGE REMOVAL AND RELOCATION WITHIN THE RIGHT-OF-WAY WITH OTTAWA COUNTY ROAD COMMISSION.
- 11. SITE CONTRACTOR RESPONSIBLE TO CONNECT EXISTING AND PROPOSED BUILDING TO WATER SERVICE AND SANITARY SEWER LATERAL, REFER TO PLUMBING PLANS FOR CONNECTION LOCATION
- 12. REFER TO ARCHITECTURAL DRAWINGS FOR BUILDING DIMENSIONS. BUILDING SHALL BE STAKED BASED ON FOUNDATION PLAN. CONTRACTOR SHALL NOTIFY ENGINEER IF THERE ARE DISCREPANCIES BETWEEN THE BUILDING AND SITE DRAWINGS.
- 13. ONSITE LIGHTING SHALL DIRECTED DOWNWARD AND AWAY FROM ADJACENT PROPERTIES AS REQUIRED PER THE HOLLAND CHARTER TOWNSHIP ZONING ORDINANCE.
- 14. SITE SIGNAGE SHALL MEET THE STANDARDS AND REQUIREMENTS OF THE HOLLAND CHARTER TOWNSHIP ZONING ORDINANCE. A SIGN PERMIT SHALL BE ACQUIRED PRIOR TO CONSTRUCTION.
- 15. CONTRACTOR SHALL BE RESPONSIBLE TO MEETING THE STANDARDS AND REQUIREMENTS OF
- 16. SEE OTHER SHEETS IN PLAN SET FOR MORE INFORMATION.


THE LOCAL NOISE ORDINANCE FOR ALL CONSTRUCTION PRACTICES.

VROON

Project Manager RYAN T. YSSELDYKE Vertical Datum Horz. Datum NGVD '29 LOCAL Drawn by BRUCE ZEINSTRA, LLA Checked by Survey Civil


L. A. HEI Project Number 25-08-005

**LAYOUT** PLAN

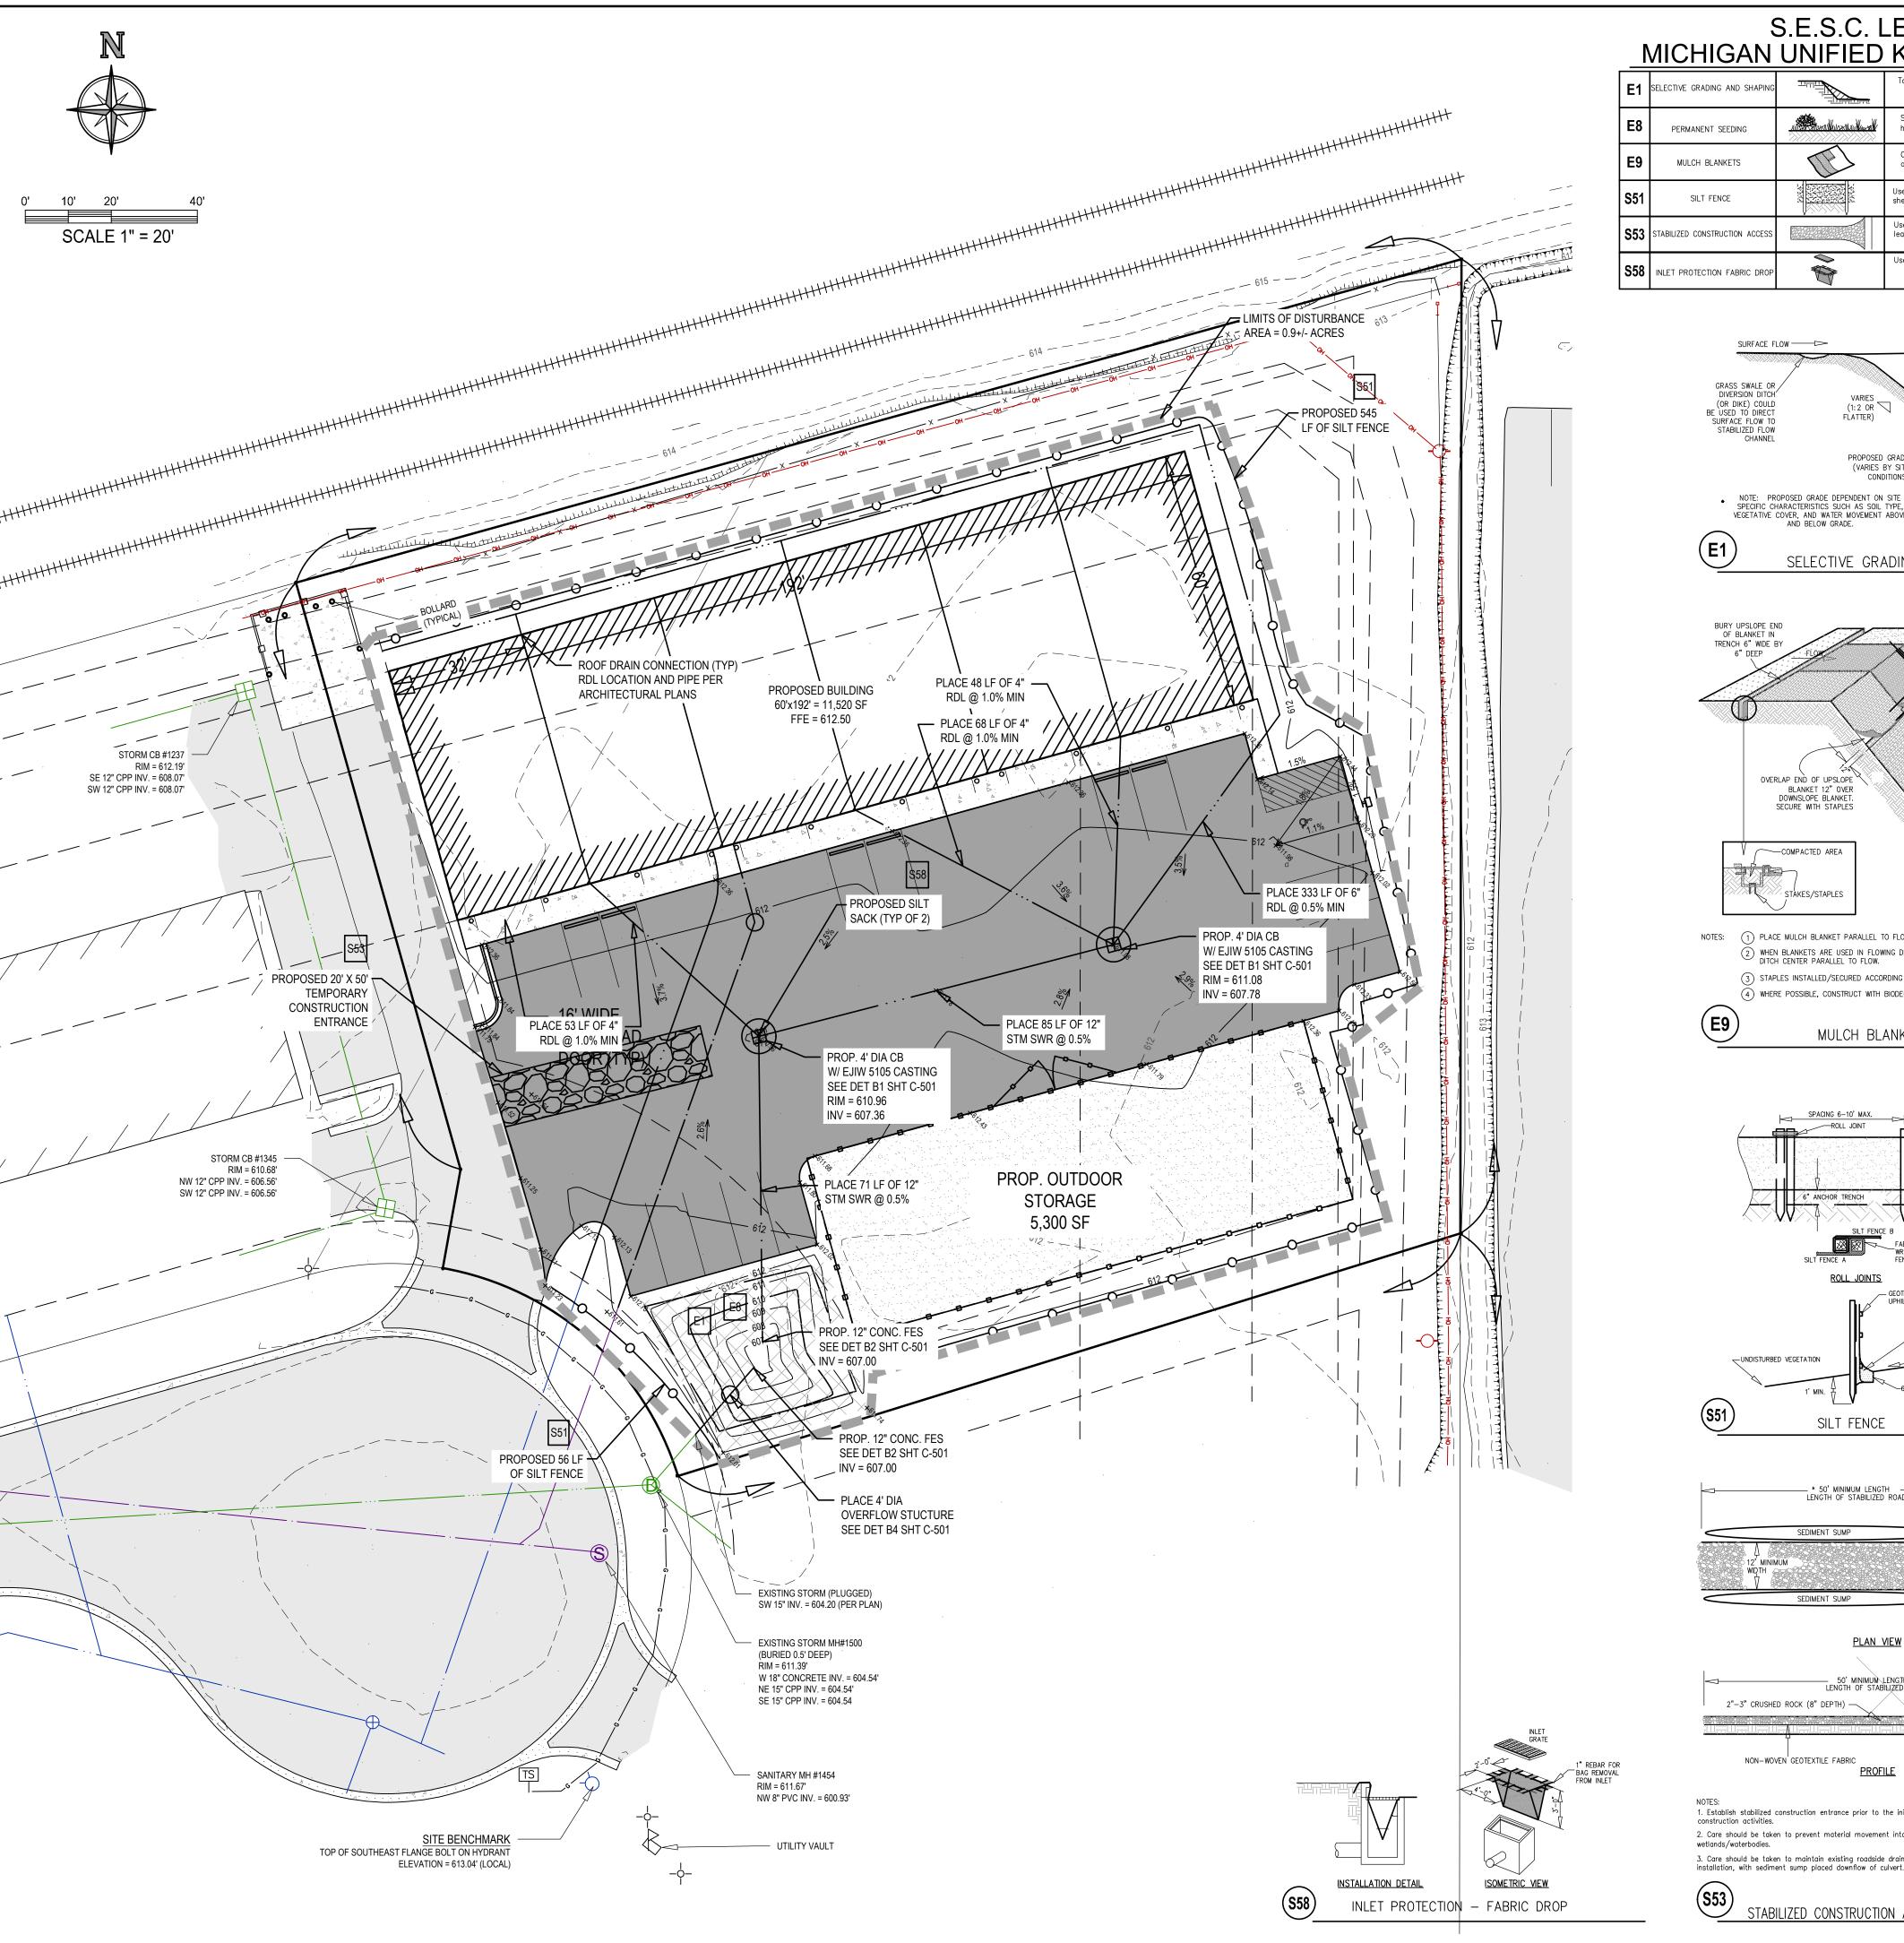


# S.E.S.C. LEGEND MICHIGAN UNIFIED KEYING SYSTEM

E1	SELECTIVE GRADING AND SHAPING		To reduce steep slopes and erosive velocities.
E8	PERMANENT SEEDING	XIXXXXII WUXXII XII WWXW	Stabilization method utilized on sites where earth change has been completed (final grading attained).
E9	MULCH BLANKETS		On exposed slopes, newly seeded areas, new ditch botton or areas subject to erosion.
S51	SILT FENCE	**************************************	Use adjacent to critical areas, to prevent sediment laden sheet flow from entering these areas.
S53	STABILIZED CONSTRUCTION ACCESS		Used at every point where construction traffic enters or leaves a construction site.
S58	INLET PROTECTION FABRIC DROP		Use at stormwater inlets, especially at construction sites.

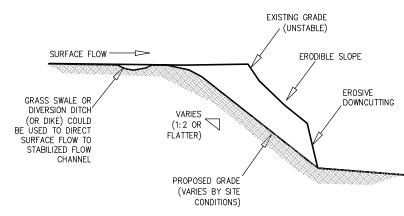

NOTE: PROPOSED GRADE DEPENDENT ON SITE SPECIFIC CHARACTERISTICS SUCH AS SOIL TYPE, VEGETATIVE COVER, AND WATER MOVEMENT ABOVE AND BELOW GRADE.


SELECTIVE GRADING AND SHAPING

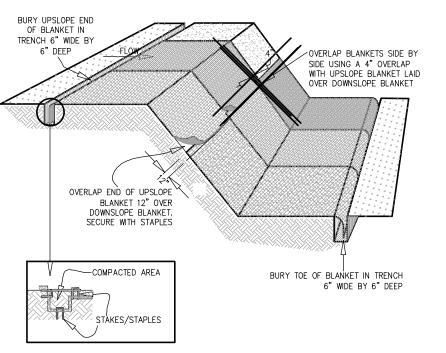



NOTES: (1) PLACE MULCH BLANKET PARALLEL TO FLOW AND ANCHOR SECURELY. WHEN BLANKETS ARE USED IN FLOWING DITCH, BLANKETS SHOULD NOT OVERLAP IN DITCH CENTER PARALLEL TO FLOW.

(3) STAPLES INSTALLED/SECURED ACCORDING TO MANUFACTURER'S SPECIFICATIONS. ) WHERE POSSIBLE, CONSTRUCT WITH BIODEGRADABLE MATERIAL.

MULCH BLANKETS

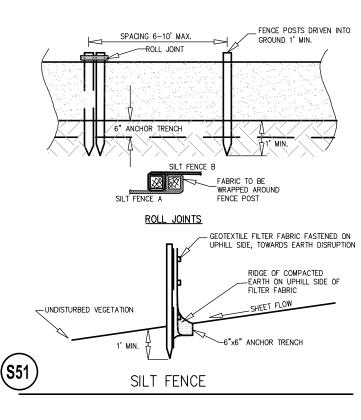

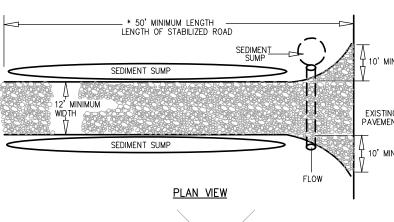

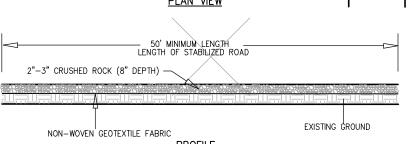

1. Establish stabilized construction entrance prior to the initiation of site construction activities. 2. Care should be taken to prevent material movement into adjacent 3. Care should be taken to maintain existing roadside drainage via culvert

STABILIZED CONSTRUCTION ACCESS

1. IT IS THE CONTRACTOR'S RESPONSIBILITY TO VERIFY THAT ALL NECESSARY PERMITS AND APPROVALS HAVE BEEN ACQUIRED PRIOR TO CONSTRUCTION.

2. SITE DESIGN WAS DEVELOPED IN ACCORDANCE WITH THE INFORMATION CONTAINED IN THE GEOTECHNICAL REPORT AND SOIL BORINGS COMPLETED FOR THE PROJECT. CONTRACTOR SHALL ACQUIRE A COPY OF THE GEOTECHNICAL REPORT AND SOIL BORING INFORMATION. SOIL CONDITIONS MAY VARY FROM THE GEOTECHNICAL INFORMATION, WHICH MAY AFFECT THE SITE DESIGN, EARTHWORK QUANTITIES, USABLE SOILS, AND SOIL EROSION AND SEDIMENTATION CONTROL PRACTICES. CONTRACTOR SHALL NOTIFY DESIGN ENGINEER AND GEOTECHNICAL ENGINEER IF SITE CONDITIONS VARY FROM SOILS INFORMATION CONTAINED IN THE GEOTECHNICAL INFORMATION. 3. CALL MISS DIG AT LEAST THREE (3) WORKING DAYS PRIOR TO STARTING ANY

4. CONTRACTOR SHALL VERIFY THAT THERE ARE NO UTILITY CONFLICTS PRIOR TO

WITH THE CURRENT EDITION OF THEIR STANDARDS & SPECIFICATIONS.

THE OTTAWA COUNTY WATER RESOURCE COMMISSION STORM WATER ORDINANCE. 7. SITE CONTRACTOR RESPONSIBLE TO CONNECT STORM / ROOF WATER TO STORM DRAIN

10. ALL STORM PIPE AND FITTINGS SHALL MEET THE REQUIREMENTS OF TABLES 1102.4, 1102.5 AND 1102.7 OF THE 2012 MICHIGAN PLUMBING CODE.

2. SITE DESIGN WAS DEVELOPED IN ACCORDANCE WITH THE INFORMATION CONTAINED IN THE GEOTECHNICAL REPORT AND SOIL BORINGS COMPLETED FOR THE PROJECT CONTRACTOR SHALL ACQUIRE A COPY OF THE GEOTECHNICAL REPORT AND SOIL BORING INFORMATION. SOIL CONDITIONS MAY VARY FROM THE GEOTECHNICAL INFORMATION, WHICH MAY AFFECT THE SITE DESIGN, EARTHWORK QUANTITIES, USABLE SOILS. AND SOIL EROSION AND SEDIMENTATION CONTROL PRACTICES. CONTRACTOR SHALL NOTIFY DESIGN ENGINEER AND GEOTECHNICAL ENGINEER IF SITE CONDITIONS VARY FROM SOILS INFORMATION CONTAINED IN THE GEOTECHNICAL INFORMATION. 3. CONTRACTOR IS RESPONSIBLE TO ACQUIRE THE OTTAWA COUNTY WATER RESOURCE COMMISSION SOIL EROSION AND SEDIMENTATION CONTROL PERMIT AND THE NPDES NOTICE OF COVERAGE AND COMPLY WITH ALL PERMIT REQUIREMENTS AND WITH ALL STANDARDS AND REQUIREMENTS OF THE AGENCIES HAVING JURISDICTION.

FOR TEMPORARY AND PERMANENT SOIL EROSION AND SEDIMENTATION CONTROL

6. THE TEMPORARY SOIL EROSION CONTROL MEASURES SHALL BE INSPECTED AND

MAINTAINED WEEKLY AND AFTER EACH SIGNIFICANT RAIN EVENT IN ACCORDANCE WITH THE EGLE REQUIREMENTS.

8. ALL WORK SHALL BE DONE IN ACCORDANCE WITH THE HOLLAND CHARTER TOWNSHIP AND OTTAWA COUNTY ROAD COMMISSION STANDARDS AND SPECIFICATIONS.

10. ALL FOREIGN MATERIAL OR DEBRIS FROM JOB SITE WHICH IS DEPOSITED ON PAVED

11. THE PAVED ROADWAY SHALL BE SWEPT CLEAN AS NEEDED, BUT AT LEAST ONCE A

12. SOIL EROSION CONTROL MEASURES ARE THE RESPONSIBILITY OF THE CONTRACTOR DURING CONSTRUCTION AND THE OWNER UPON COMPLETION.

MEASURES AS NECESSARY FOR THE SITE IMPROVEMENTS WITHIN THE LIMITATIONS OF


14. STOCKPILE AREAS SHALL BE STABILIZED WITH TEMPORARY OR PERMANENT SEED IN ACCORDANCE WITH THE OTTAWA COUNTY WATER RESOURCE COMMISSION SOIL

15. ALL EXCESS SPOILS SHALL BE HAULED OFFSITE AND LEGALLY PLACED ONSITE. 16. THERE SHALL BE NO EARTH MOVEMENT OR DISTURBANCE OUTSIDE THE LIMITS OF

RESOURCE COMMISSION.

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NOTE: CONSTRUCTION SCHEDULE MAY VARY BASED ON CONTRACTOR'S

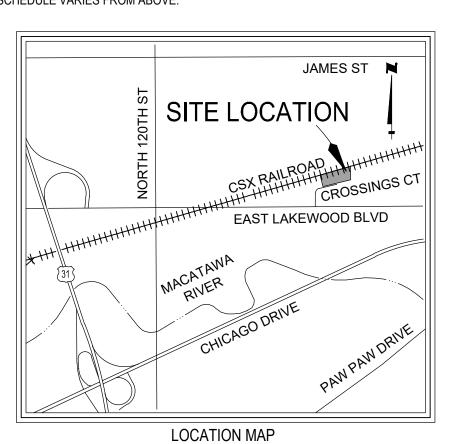

**GRADING & STORM SEWER NOTES** 

CONSTRUCTION. 5. ALL WORK WITHIN THE RIGHT-OF-WAY WILL REQUIRE A PERMIT AND OR APPROVAL FROM OTTAWA COUNTY ROAD COMMISSION AND SHALL BE CONSTRUCTED IN ACCORDANCE

6. STORM WATER MANAGEMENT SYSTEM AND GRADING SHALL BE IN ACCORDANCE WITH AS SHOWN. REFER TO PLUMBING PLANS FOR CONNECTION TO THE BUILDING AND

8. SITE SHALL BE GRADED WITH SMOOTH CONTOURS IN ALL AREAS OF DISTURBANCE AND

GRADED TO SLOPE AWAY FROM THE EXISTING AND PROPOSED BUILDINGS AND 9. ALL STORM SEWER PIPING SHALL BE ADS N-12, HANCOR HI-Q OR APPROVED EQUIVALENT POLYETHYLENE (PE) PLASTIC PIPE AND FITTINGS, UNLESS OTHERWISE NOTED. WHERE SPECIFIED IN THE PLANS, CONCRETE CLASS IV PIPE WITH RUBBER GASKETS IS

11. SEE OTHER SHEETS IN PLAN SET FOR MORE INFORMATION.

1. CONTRACTOR SHALL OBTAIN ALL STATE AND LOCAL PERMITS AS NECESSARY FOR CONSTRUCTION.

4. BEST MANAGEMENT PRACTICES SHALL BE UTILIZED DURING AND AFTER CONSTRUCTION

5. CONTRACTOR SHALL PROVIDE A CERTIFIED STORM WATER OPERATOR FROM CONSTRUCTION COMMENCEMENT THROUGH FINAL SITE STABILIZATION.

7. CALL MISS DIG AT LEAST THREE (3) WORKING DAYS PRIOR TO STARTING ANY

9. SOIL EROSION CONTROL MEASURES SHALL BE PLACED PRIOR TO EARTH MOVING OR GROUND DISTURBANCE AND REMAIN IN PLACE UNTIL FINAL RESTORATION HAS BEEN

ROADWAY SHALL BE REMOVED IMMEDIATELY.

13. CONTRACTOR SHALL PHASE THE PLACEMENT OF THE SOIL EROSION CONTROL

THE ACQUIRED SOIL EROSION CONTROL PERMIT. EROSION AND SEDIMENTATION CONTROL REQUIREMENTS. ALL EXCESS SPOILS SHALL BE

REMOVED FROM SITE. DISTURBANCE WITHOUT PRIOR AUTHORIZATION FROM THE OTTAWA COUNTY WATER


17. THE MINIMUM AMOUNT OF SOIL EROSION AND SEDIMENTATION CONTROL MEASURES ARE SHOWN THE DRAWINGS. CONTRACTOR SHALL PROVIDE ADDITIONAL CONTROL MEASURES, MAINTENANCE, AND/OR STABILIZATION MEASURES AS NECESSARY FOR CONSTRUCTION ACTIVITIES.

18. SEE OTHER SHEETS IN PLAN SET FOR MORE INFORMATION.

# PROPOSED CONSTRUCTION SCHEDULE

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SCHEDULE. CONTRACTOR SHALL UPDATE THE OCWRC IF CONSTRUCTION SCHEDULE VARIES FROM ABOVE.

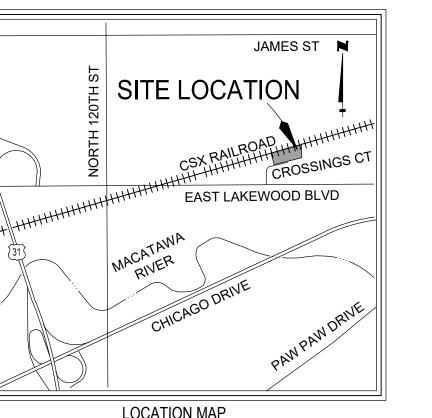

**Project Manage** 

NGVD '29

Drawn by

Checked by

Survey

Civil

Struc.

L. A.

HEI Project Number

25-08-005

GRADING


RYAN T. YSSELDYKE


PETER BULTEN, P.E.

Vertical Datum Horz. Datum


LOCAL

STORM & SESC PLAN

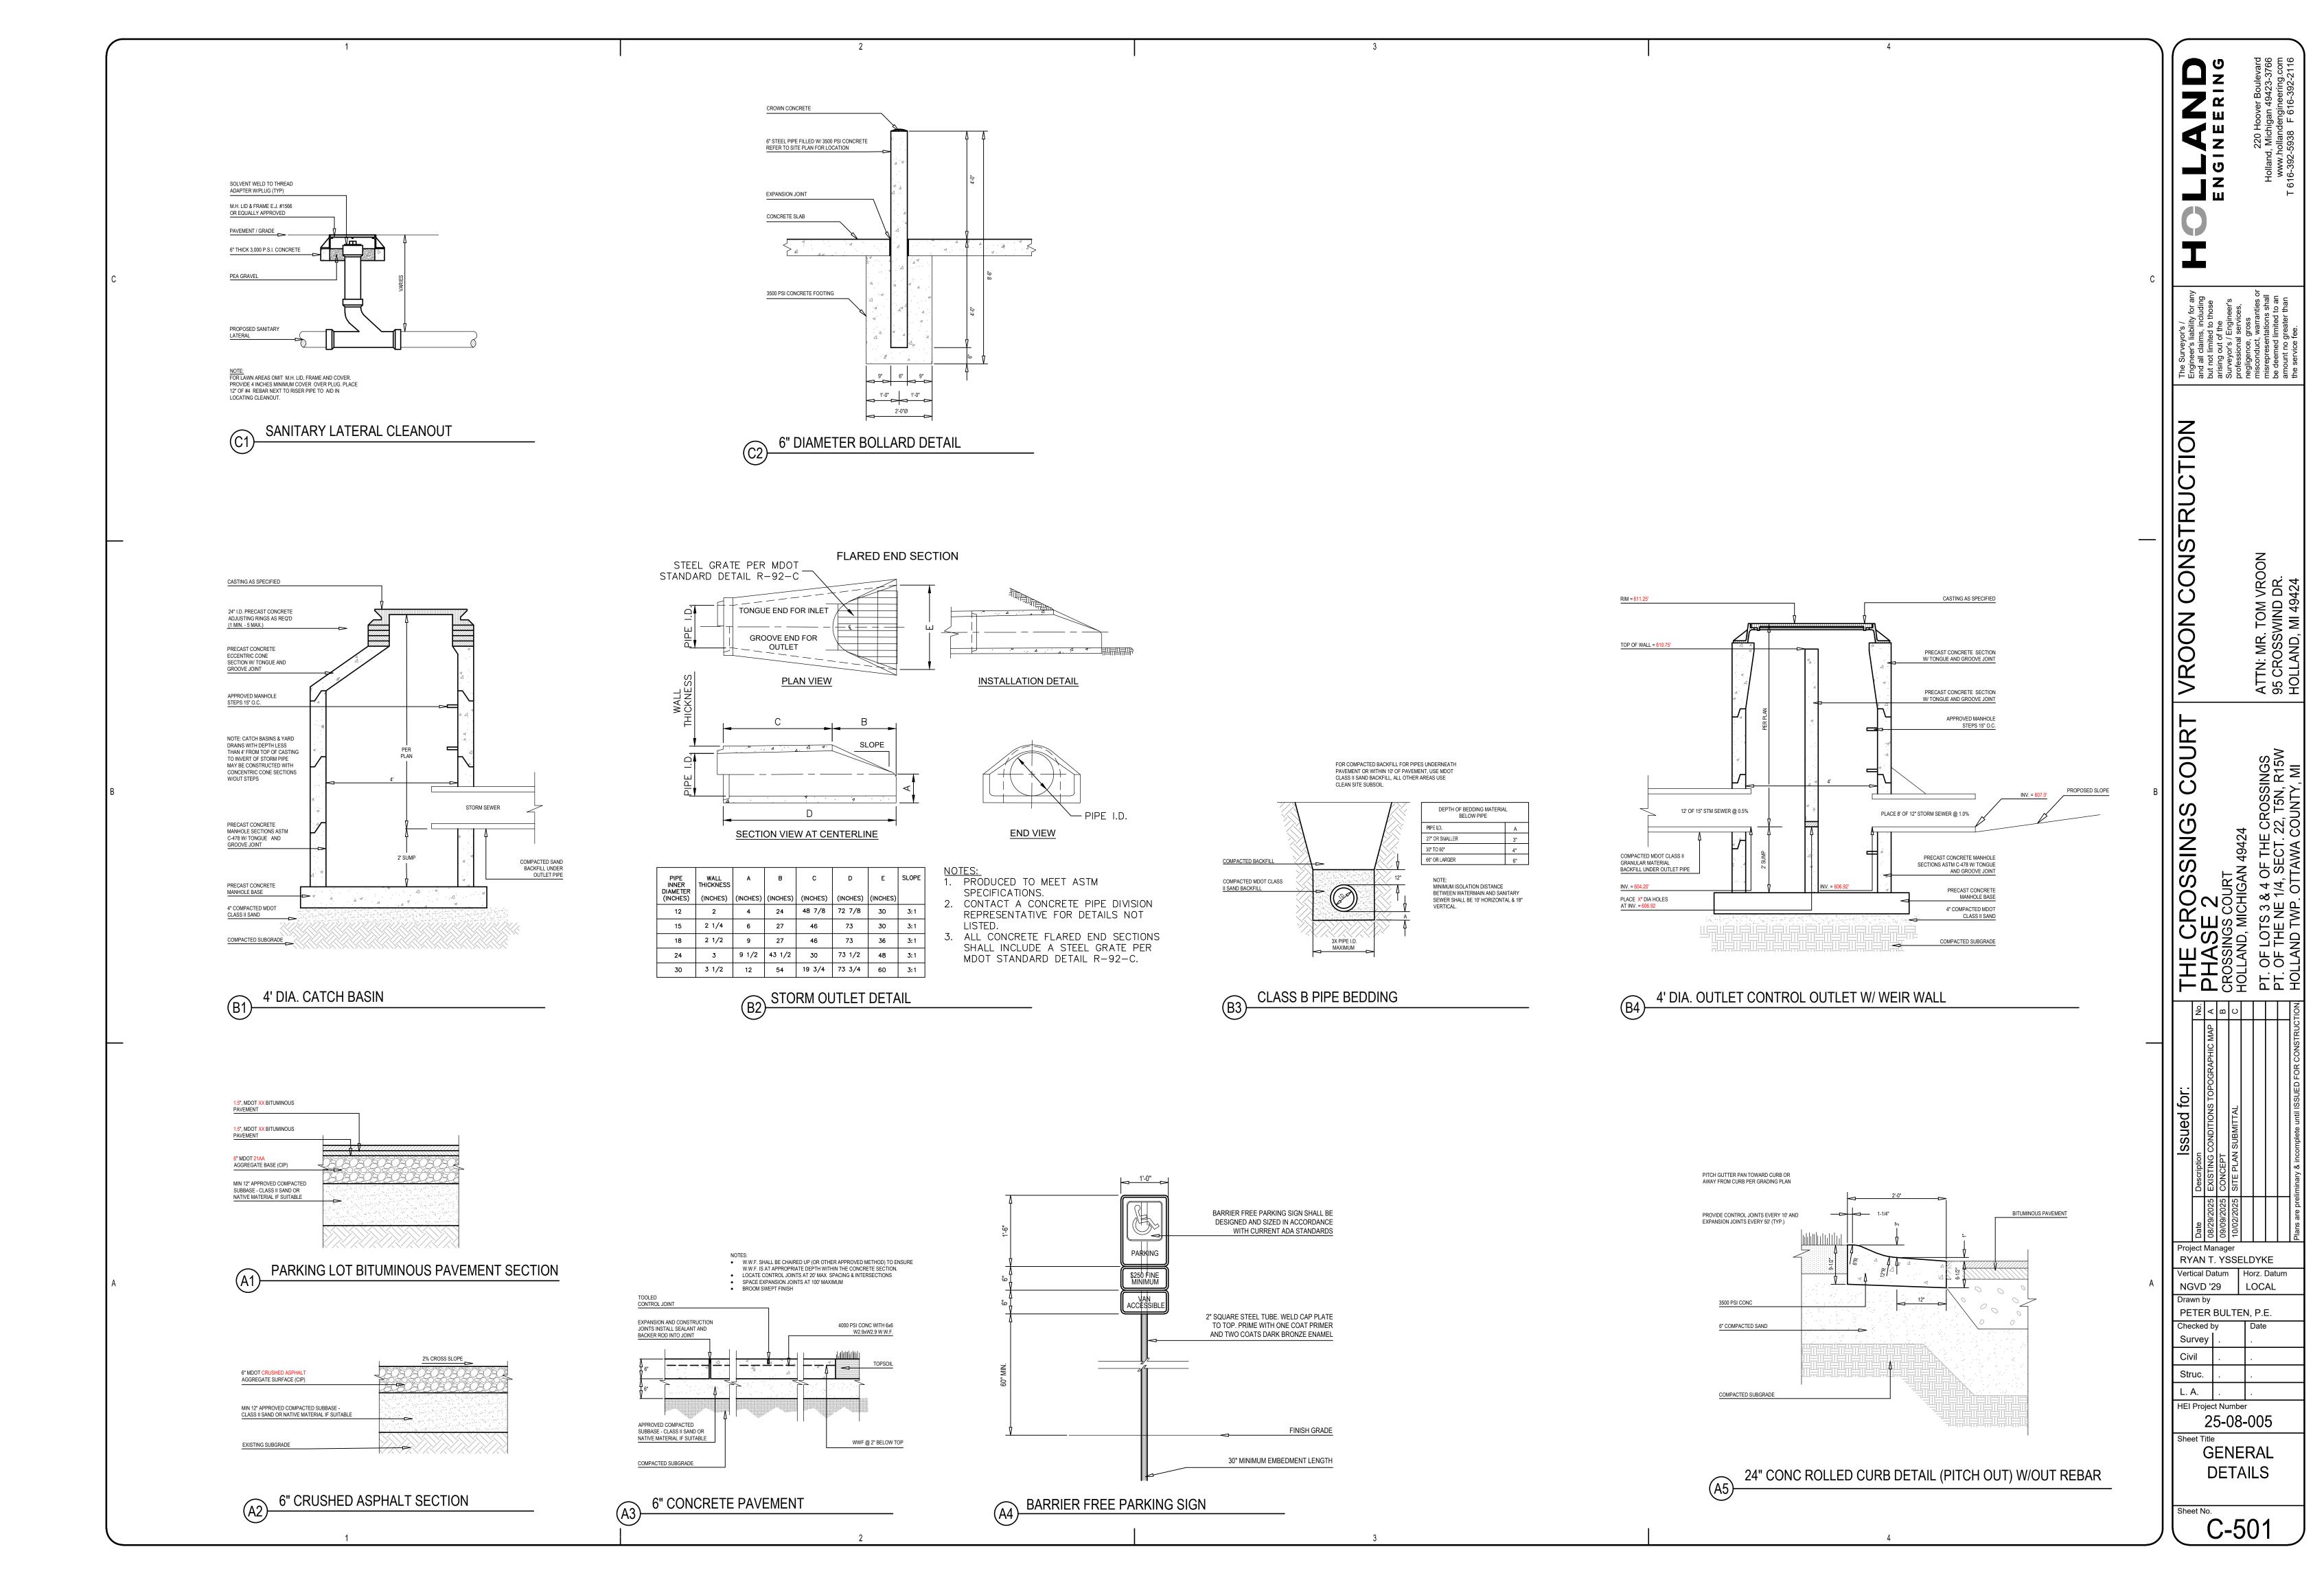

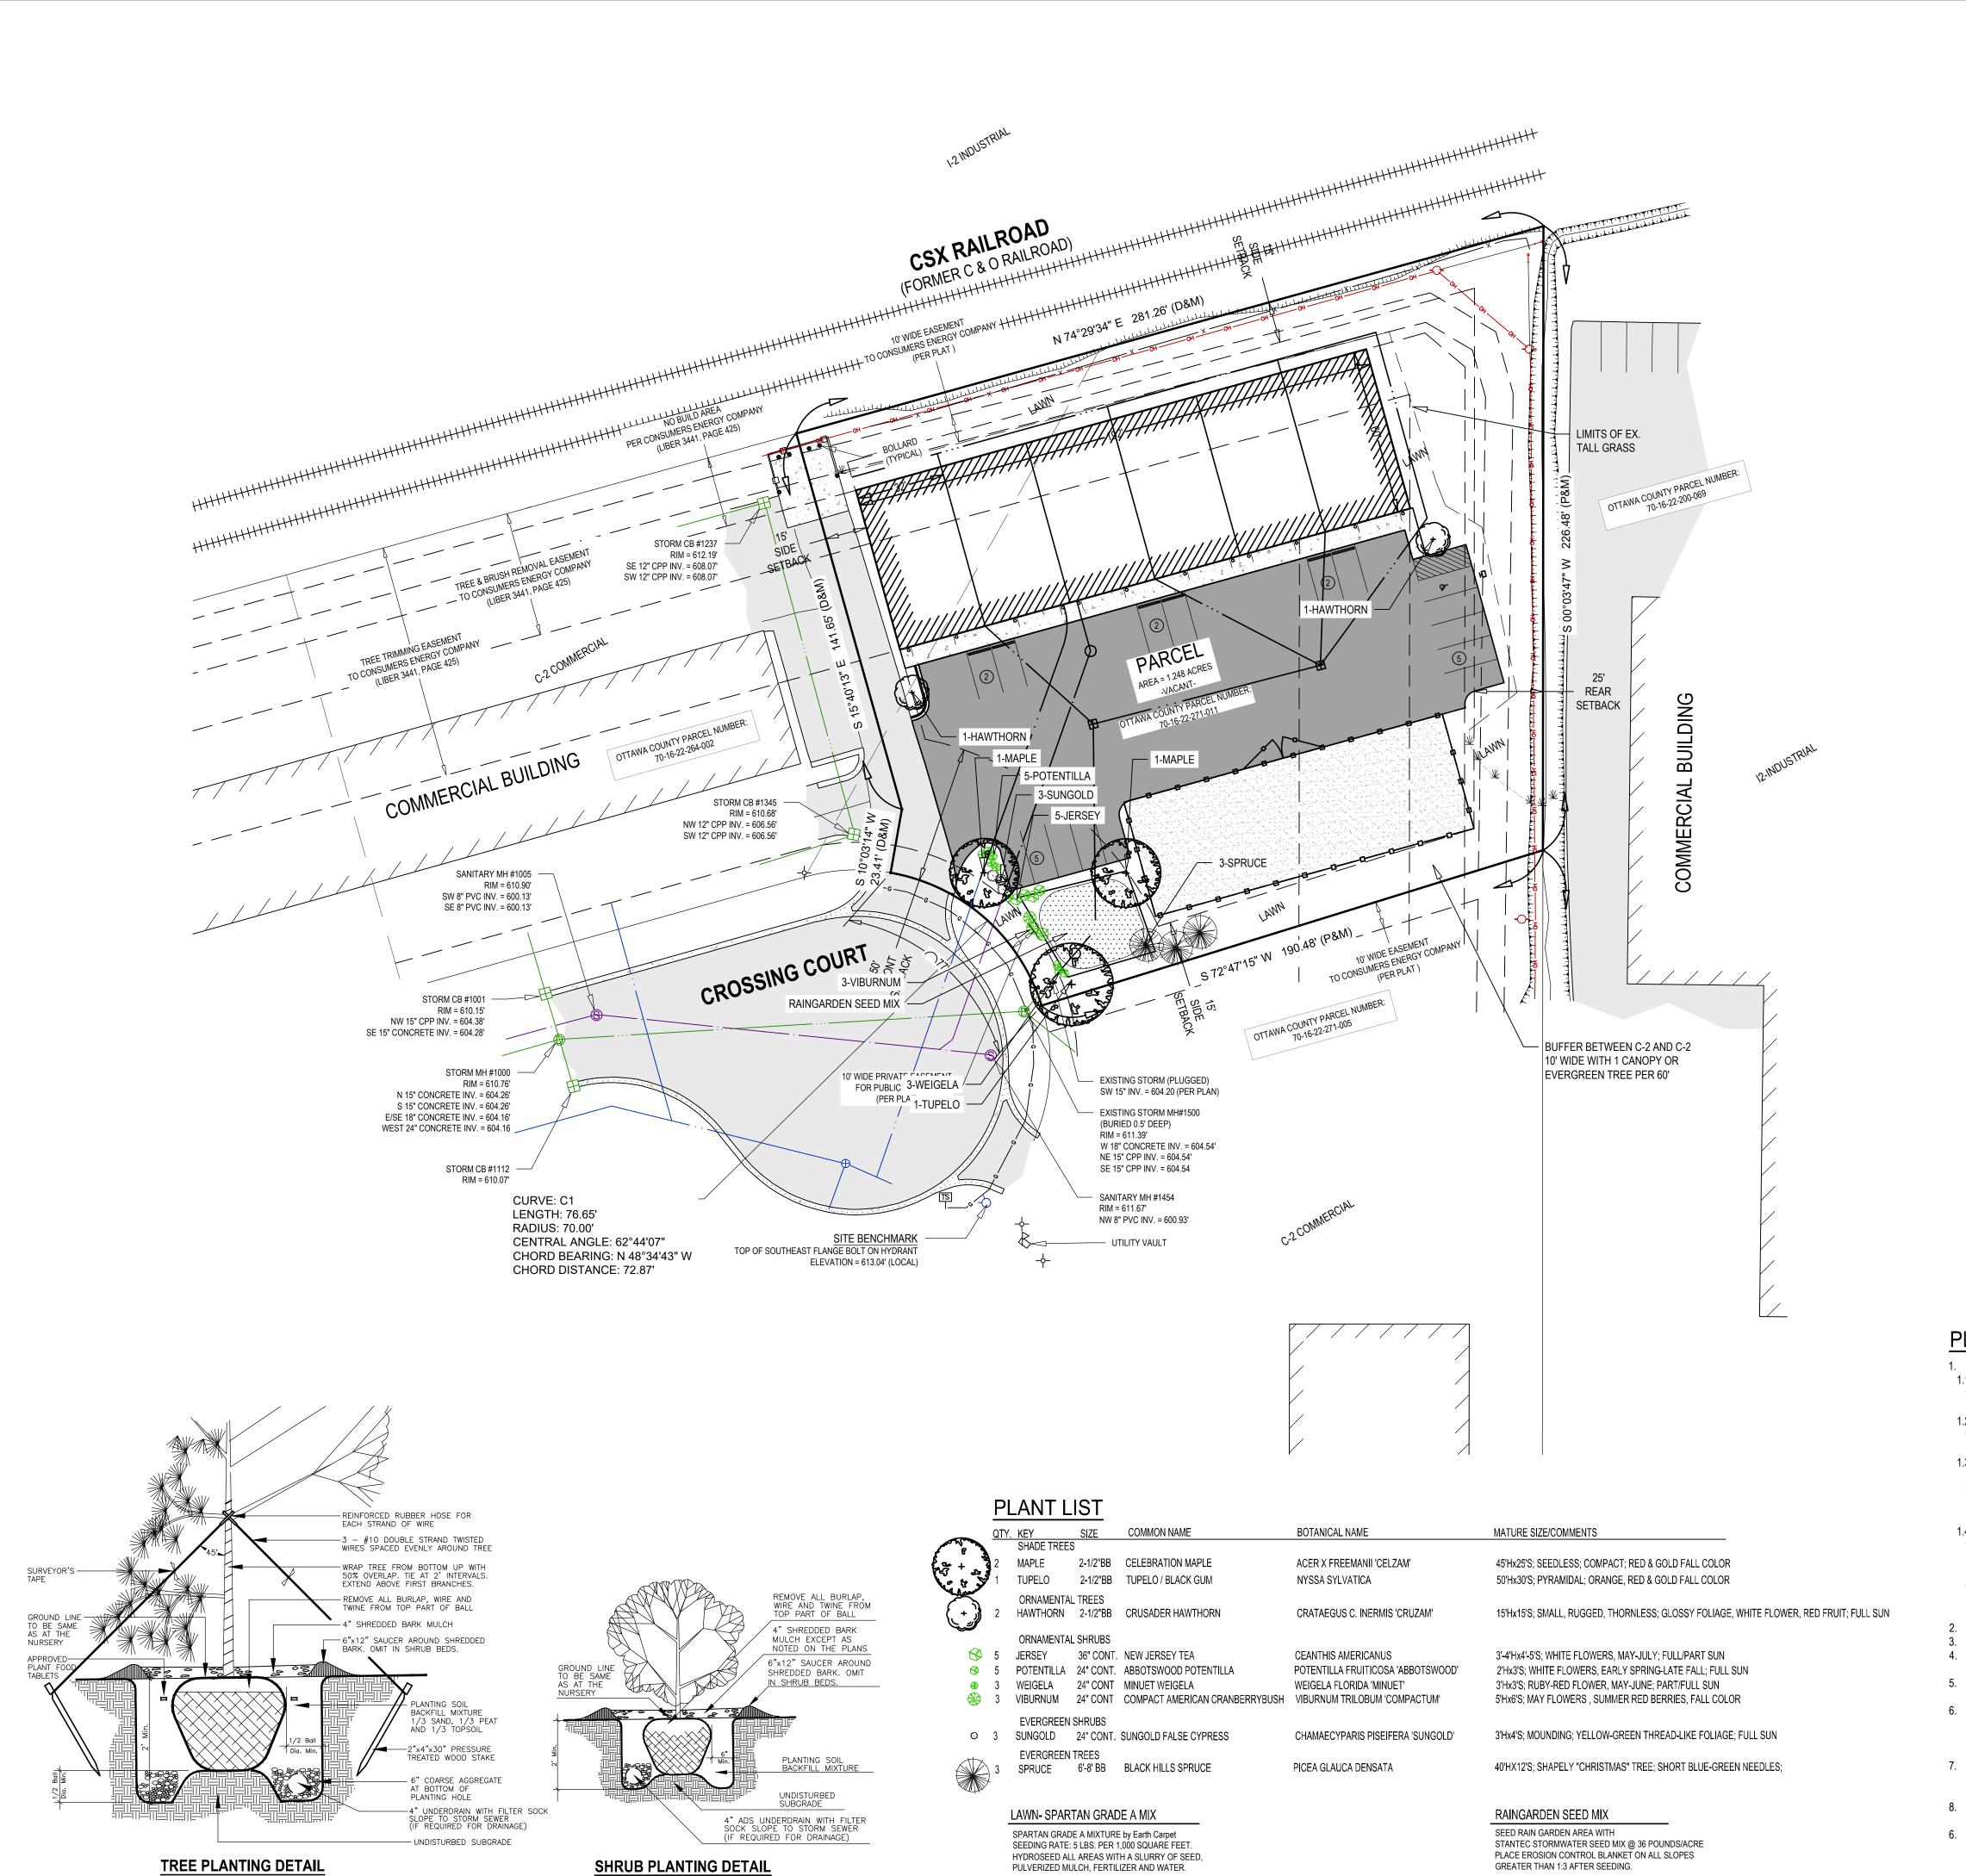

PULVERIZED MULCH, FERTILIZER AND WATER.

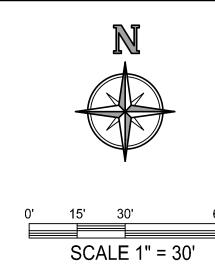

# PLANTING NOTES:

1. LANDSCAPE REQUIREMENTS FOR PROPOSED IMPROVEMENT AREA ONLY:

1.1. FRONT YARD LANDSCAPING: 1 TREE + 3 SHRUBS PER 40', PLACED BETWEEN ROW AND PARKING.

1.1.1. REQUIRED:  $70' / 40 = 1.75 \approx 2$  TREES + 6 SHRUBS PROVIDED: 2 CANOPY TREES + 6 SHRUBS

1.2. BUFFER ZONE D BETWEEN C-2 ZONES: 10' WIDE BUFFER WITH 1 CANOPY OR 1 EVERGREEN PER 60' 1.2.1. REQUIRED SOUTH PROPERTY LINE: 190' / 60 = 3.16 ≈ 3 CANOPY OR EVERGREEN TREES

PROVIDED: 3 PROPOSED EVERGREEN TREES

1.3. PARKING LOT CANOPY TREES: 1 TREE + 100 SF PER 12 SPACES; 1/2 OF TREES SHALL BE PLACED IN THE INTERIOR OF THE PARKING AREA.

REQUIRED: 16 PROPOSED SPACES / 12 = 1.3 ≈ 2 TREES PROVIDED: 1 CANOPY TREE + 2 ORNAMENTAL TREES (DUE TO ISLAND SIZE AND CONSUMERS

CONSUMERS TREE TRIMMING EASEMENT). 1.4. SCREENING: SCREEN PARKING AND DUMPSTER:

SCREEN PARKING FROM ROW AND ABUTTING AGRICULTURE AND RESIDENTIAL DISTRICTS WITH HEDGEROW

PROPOSED: 13 SHRUBS ALONG PARKING

DUMPSTER SHALL HAVE ENCLOSURE CONSTRUCTED OF MASONRY, CONCRETE, METAL, TREATED WOOD,

OR SIMILAR; PARKING SHALL BE SCREENED BY WALL OR HEDGEROW 30" TALL.

PROPOSED: EXISTING DUMPSTER ENCLOSURE 2. ALL TREES AND SHRUBS SHALL BE PLANTED A MINIMUM OF 4' AWAY FROM PAVEMENT.

3. TREES ADJACENT TO PARKING LOTS AND DRIVES SHALL HAVE BRANCHES TRIMMED TO A MINIMUM HEIGHT OF 14'.

4. ALL LAWN AND PLANTING AREAS SHALL BE MAINTAINED IN SUCH WAY TO KEEP VEGETATION IN A HEALTHY AND GROWING MANNER.

5. ALL LANDSCAPE AREAS SHALL BE MAINTAINED BY OWNER. TREES AND OTHER VEGETATION THAT DIE SHALL BE

PROMPTLY REPLACED WITH IN KIND VEGETATION. 6. CONTRACTOR SHALL PROVIDE SPECIFIED TREES, SHRUBS, GROUND COVERS AND OTHER PLANT MATERIAL THAT COMPLY WITH ALL RECOMMENDATIONS AND REQUIREMENTS OF ANSI Z60.1 "AMERICAN STANDARD FOR NURSERY

INSTALLED IN ACCORDANCE WITH METHODS ESTABLISHED BY THE AMERICAN ASSOCIATION OF NURSERYMEN. 7. SEED SHALL BE PLACED OVER 6" TOPSOIL IN ALL PROPOSED LAWN AREAS AND ALL AREAS DISTURBED BY CONSTRUCTION EXCEPT AS NOTED ON THE PLANS. SOD SHALL BE PLACED IN ALL AREAS AS SHOWN ON THE PLANS

**OVER 4" TOPSOIL** 8. PLANTING SOIL CONSISTING OF 1/3 TOPSOIL, 1/3 PEAT MOSS AND 1/3 SAND SHALL BE PLACED IN ALL GROUND COVER AND FLOWER BEDS. DEPTH SHALL BE NOT LESS THAN 8".

STOCK." PLANT MATERIAL SHALL BE HEALTHY, VIGOROUS STOCK GROWN WITH GOOD HORTICULTURAL PRACTICE AND

6. FOLLOWING CONSTRUCTION, RESTORE ALL DISTURBED AREAS WITH EARTH CARPET SPARTAN GRADE "A" SEED MIX, UNLESS OTHERWISE NOTED.

and all claims, including	
but not limited to those	
arising out of the	
Surveyor's / Engineer's	
professional services,	
negligence, gross	
misconduct, warranties or	
misrepresentations shall	
be deemed limited to an	
amount no greater than	
the service fee.	

CONSTRUCTION


Project Manager RYAN T. YSSELDYKE LOCAL

Vertical Datum Horz. Datum NGVD '29 Drawn by BRUCE ZEINSTRA, LLA Checked by Survey Civil

Struc. L. A. HEI Project Number


25-08-005 LANDSCAPE

**PLANTING** PLAN

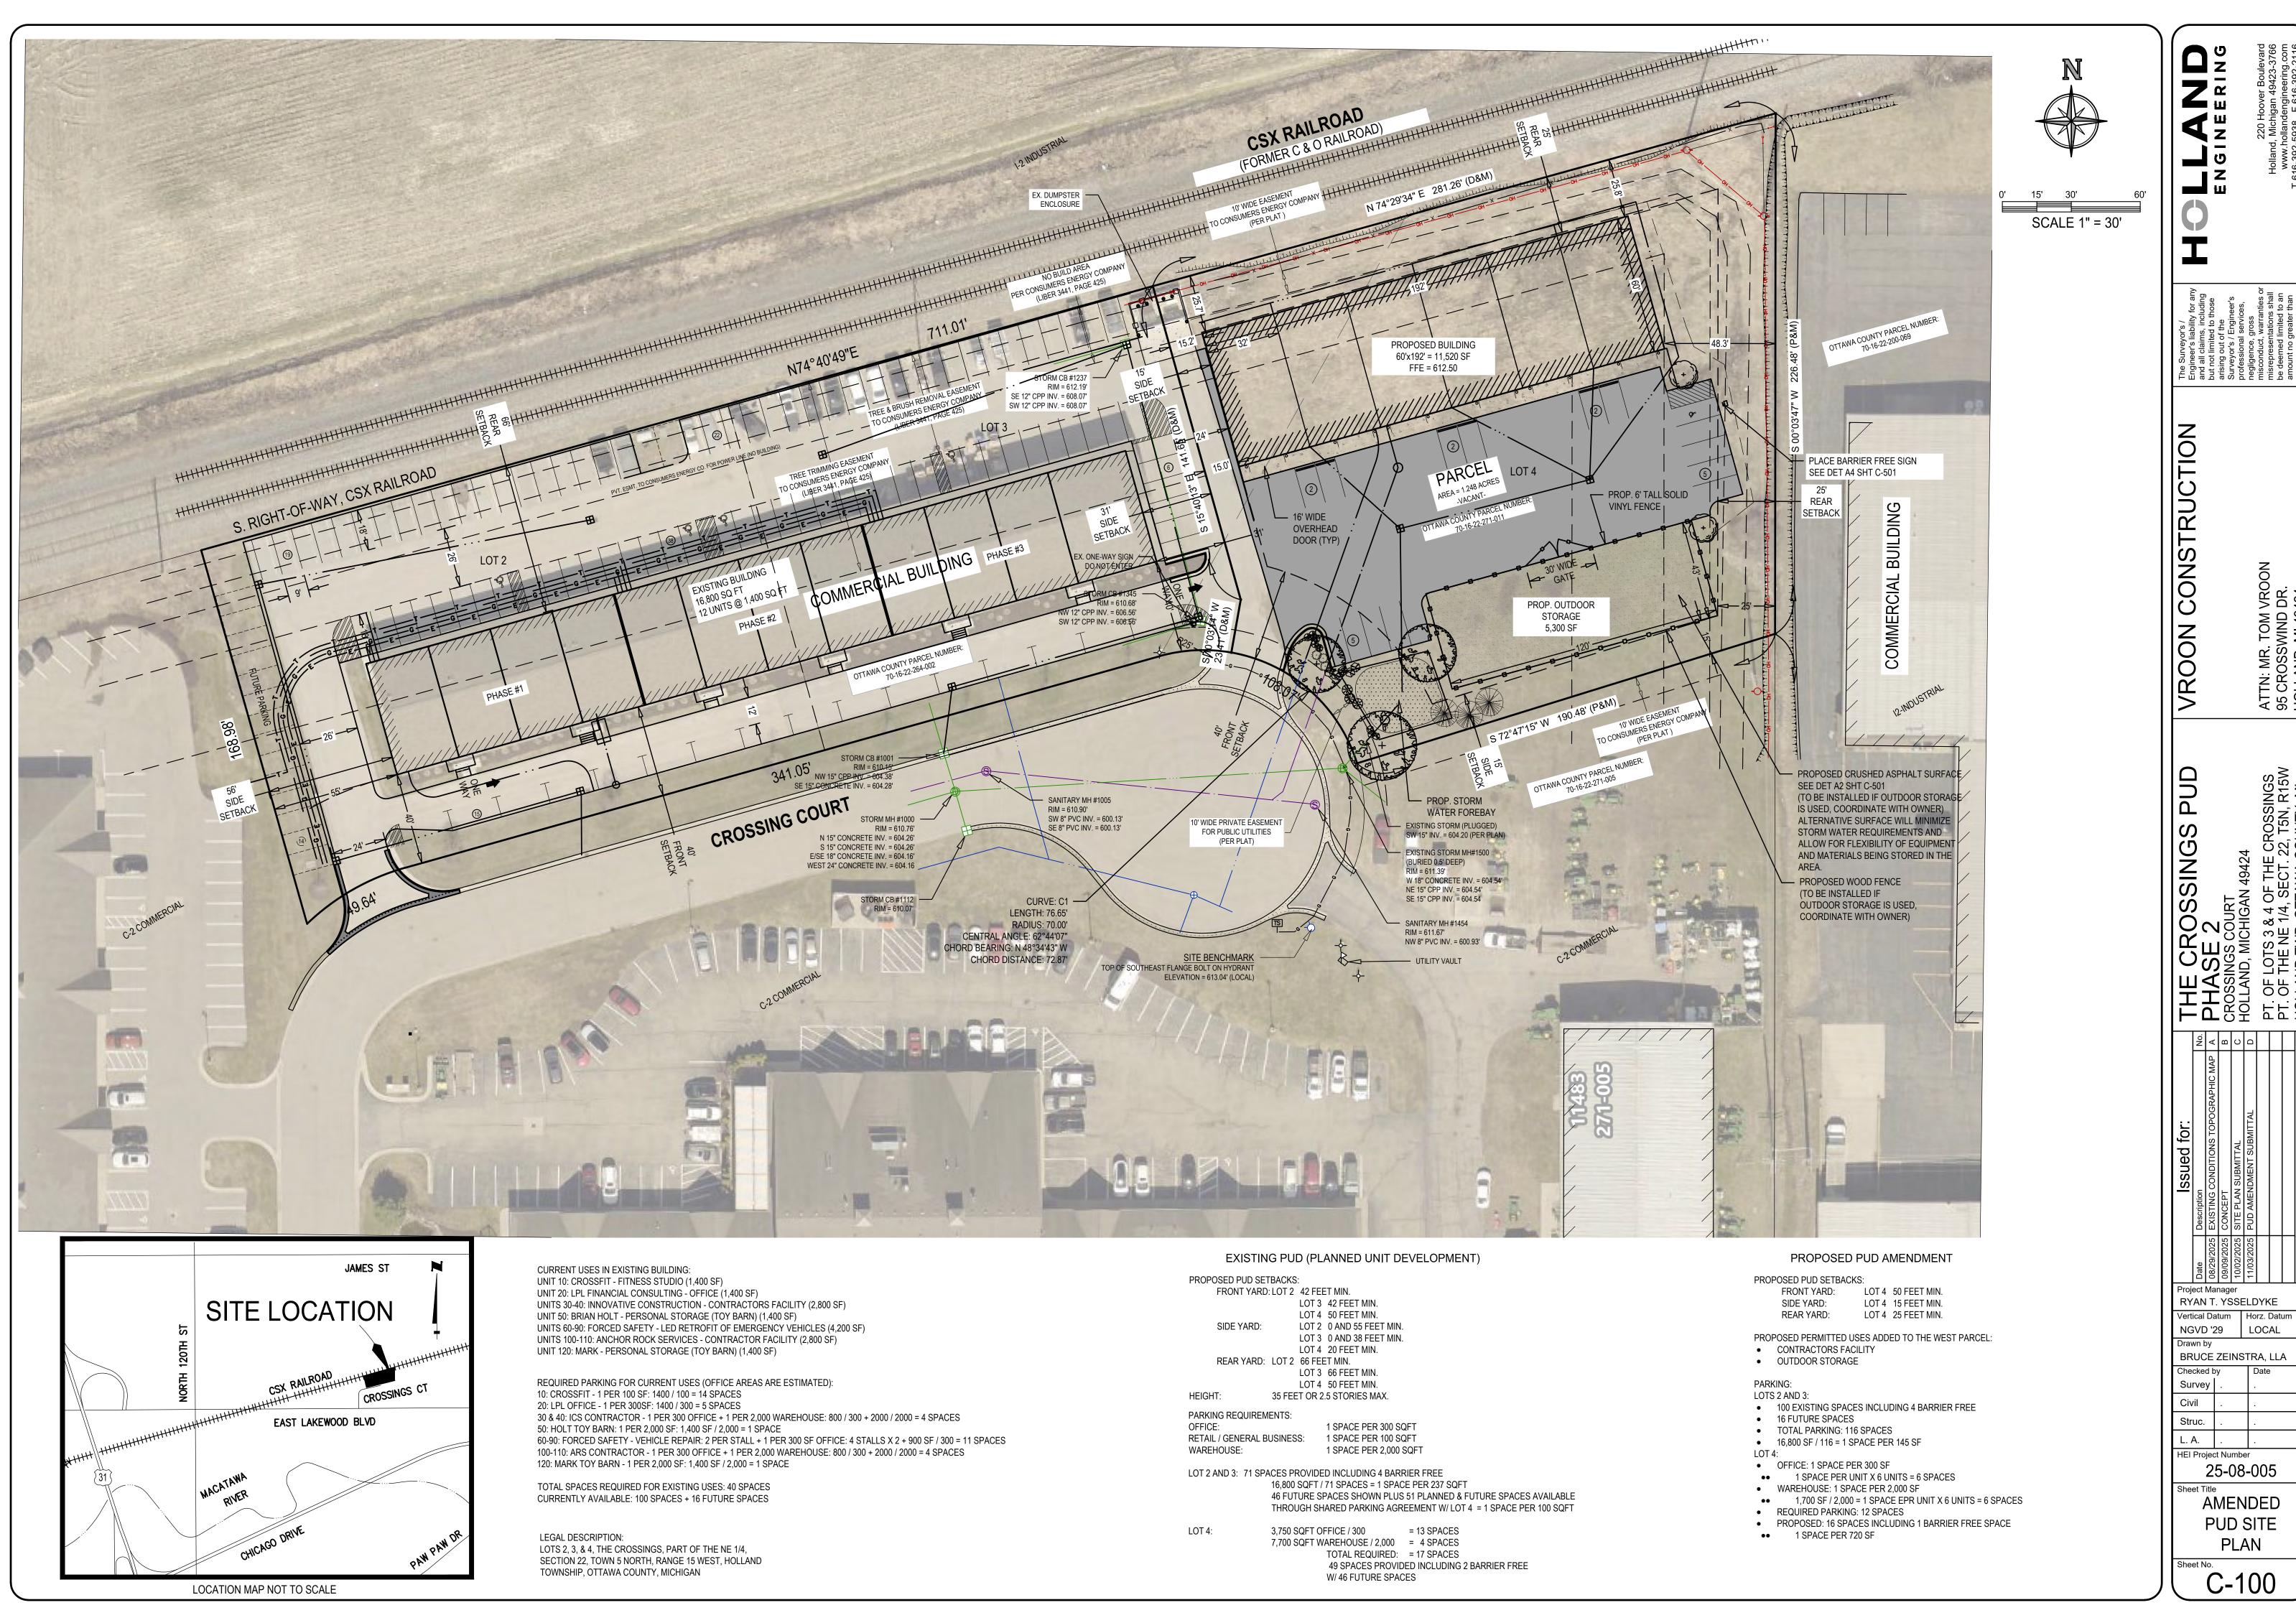

25-08-005 AMENDED PUD SITE PLAN

C-100

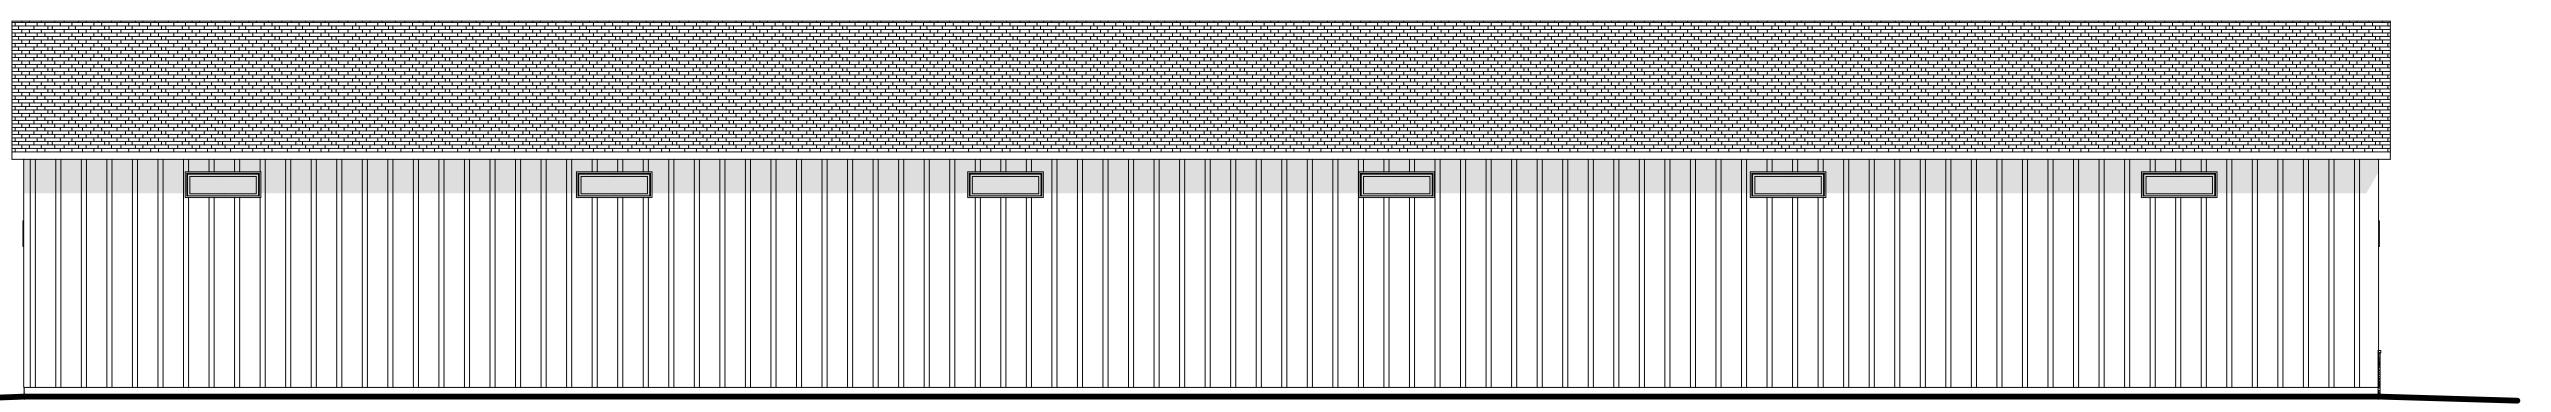

# North Elevation

SCALE: 1/8" = 1'-0"

# Project Information Governing Codes: • Michigan Building Code 2021; Incorporating the 2021 International Building Code • Michigan Plumbing Code 2021 • Michigan Mechanical Code 2021 • Michigan Electrical Code 2023 • ICC/ANSI A117.1-2017

Code of Ordinances: Holland Charter Township, MI

Enforcing Agency: Holland Charter Township 353 120th Ave., Holland, MI 49324

SITE ADDRESS: Crossings Court Holland, MI 49424


Parcel No.: 70-16-22-271-011


Property Description:
THAT PART OF LOTS 3 & 4 LYING E OF A LINE COM
N 74D 29M 34S E 192 FT FROM NW COR OF LOT 3,
TH S 15D 40M 13S E 141.65 FT, TH S 10D 03M 14S W
23.41 FT TO N LI OF CROSSINGS CT AND END OF
SD LINE. THE CROSSINGS

Zoning: C-2, Community Commercial District


Building Construction Type: 5B

Use Group: S-1 Moderate-Hazard Storage

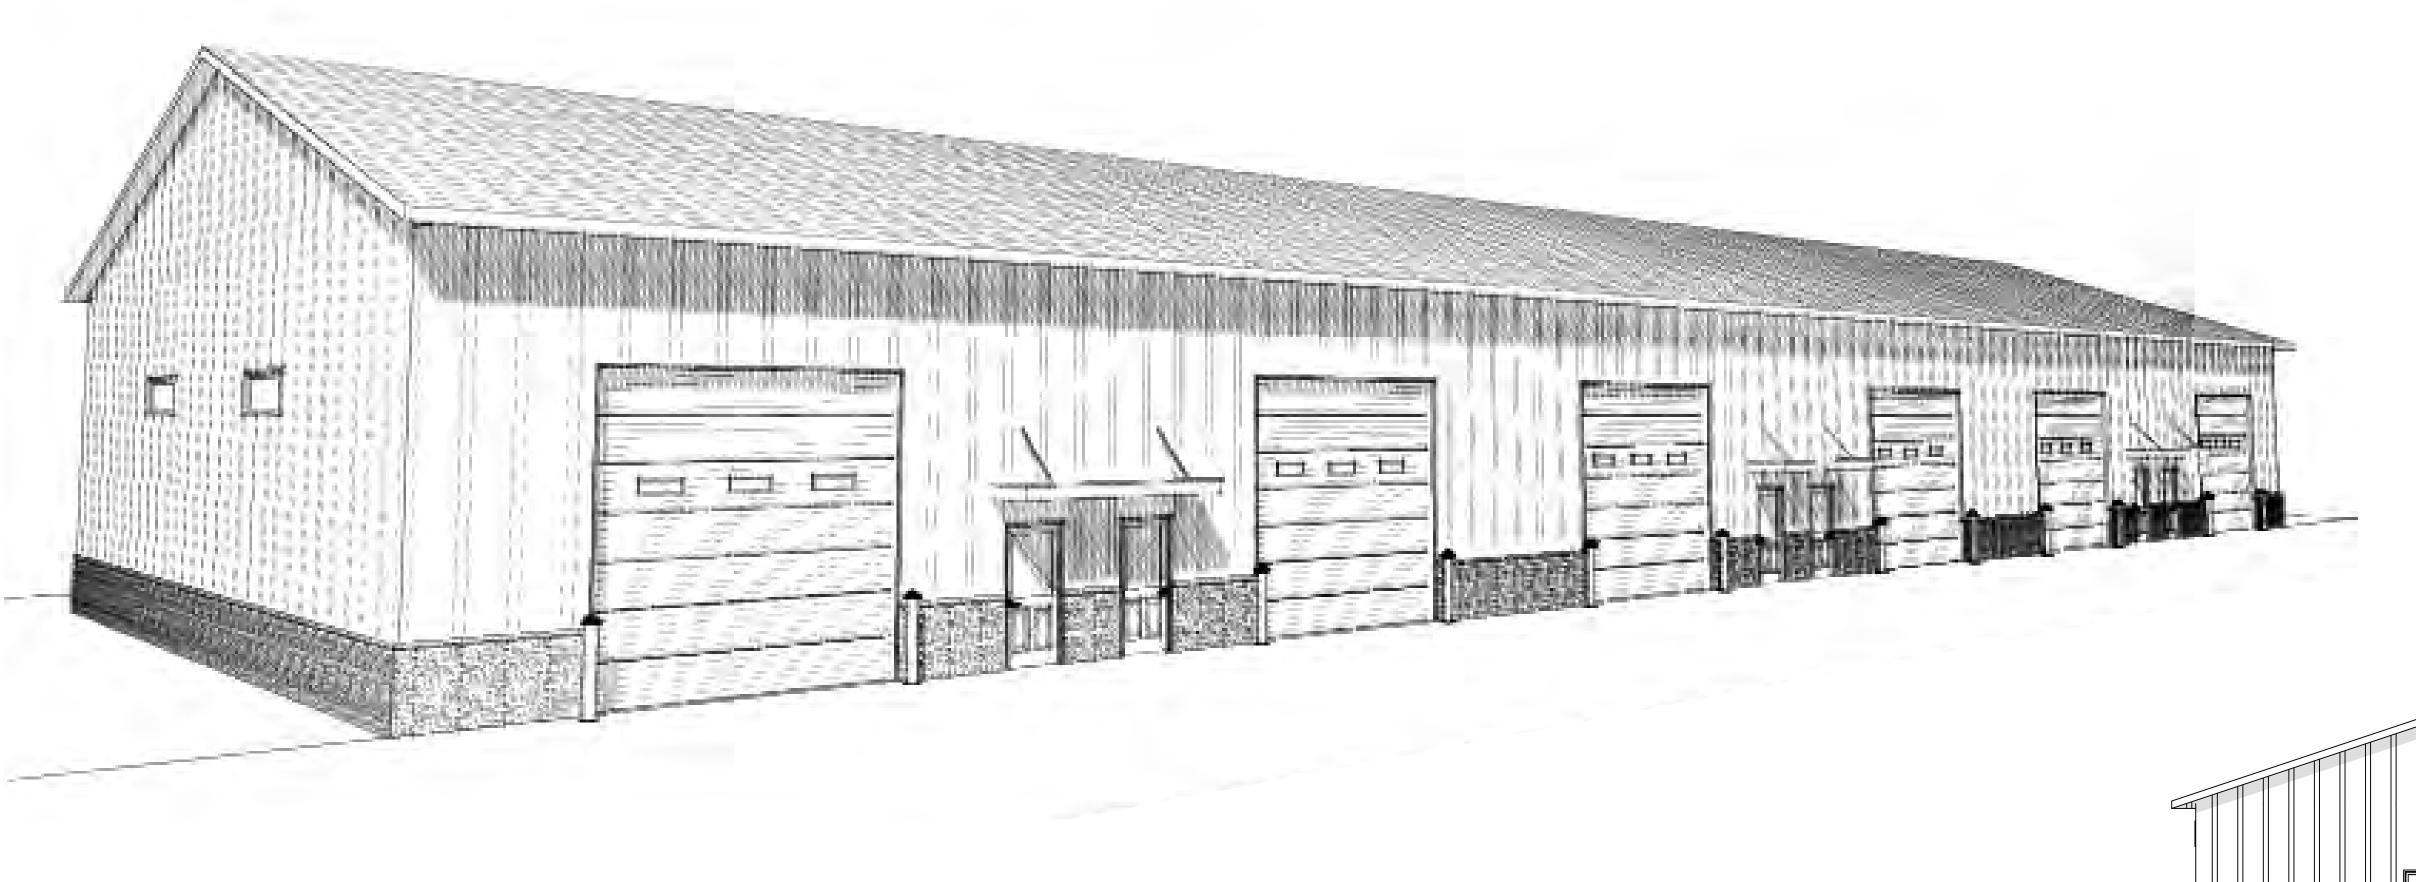

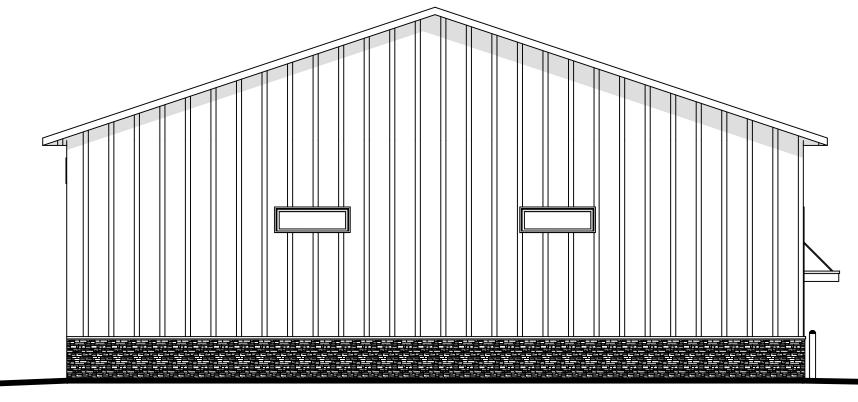

West Elevation

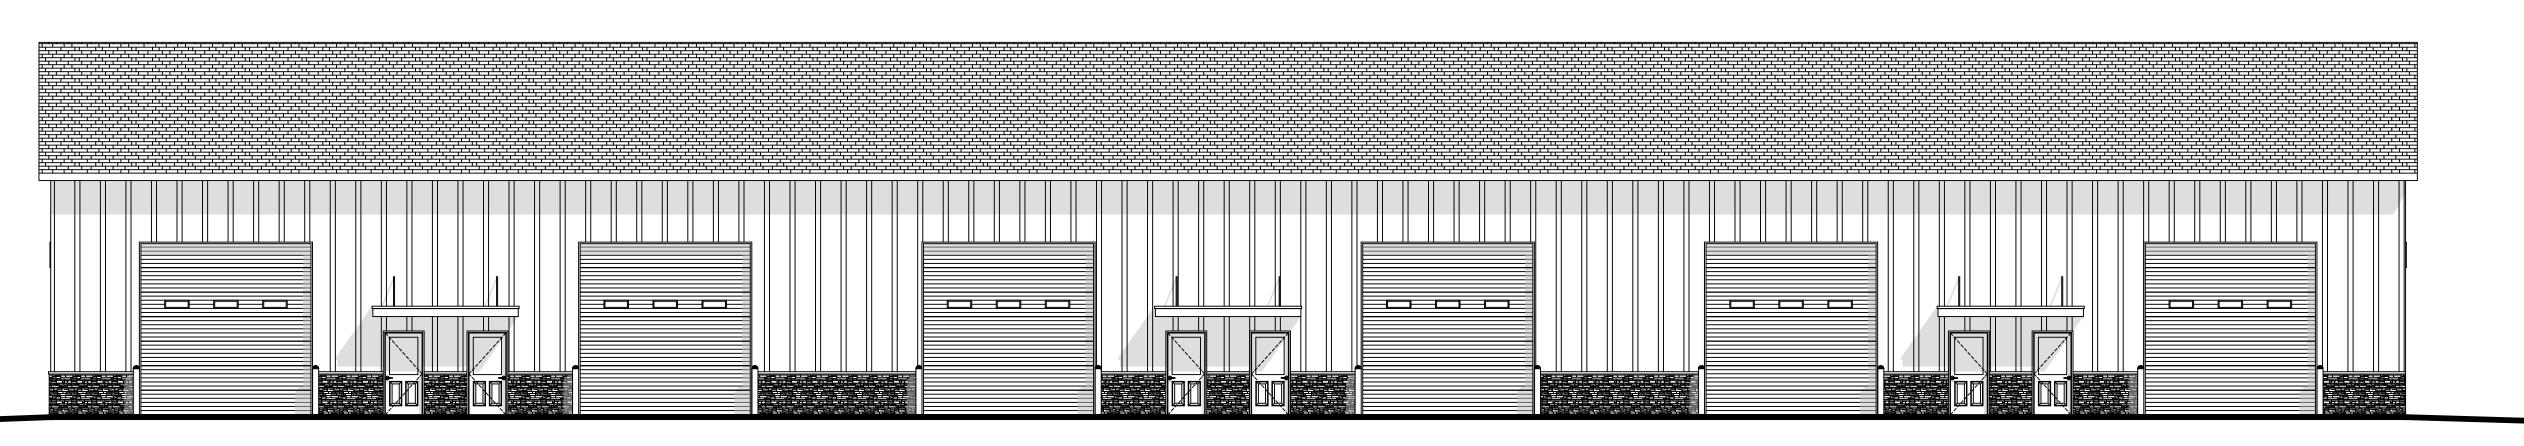

GEN 1
Architectural Group
9818 Perry Street, Zeeland MI 49464 Ph: 616.931.3671 gen1-architectural.com

"The Crossings"
Crossings Court, Holland, MI 49424

Exterior Elevations
Architectural Plan

© Gen1 Architectural Group,

SCALE: 1/8" = 1'-0"

Scale: 1/8" = 1'-0" October 02, 2025