

APPLICATION FOR SPECIAL USE APPROVAL

Applicant Information CC Equities LLC Contact Name Mark "Chip" McComb Company Address 2065 112th Avenue 616-566-7209 Phone Fax / Email chip@autoexchangeofholland.cor Holland, MI. 49424 Owner Information CC Equities LLC Contact Name Mark "Chip" McComb Company 616-566-7209 Address 2065 112th Avenue Phone Fax / Email chip@autoexchangeofholland.cor Holland, Ml. 49424 Plan Preparer Information Contact Name John Tenpas, P.E. Driesenga & Associates Company Address 12330 James St., Suite H80 Phone 616-396-0255 Fax / Email johnt@driesenga.com Holland, MI 49424

353 North 120th Avenue · Holland, MI 49424 · Phone: 616.395.0151 · Fax: 616.396.2537

Property Information

Address or Location	n <u>2065 112th Avenue, Hollan</u>	<u>a Lownsnip</u>	
Parcel Number	70 - 16 - <u>22</u> - <u>200</u> - <u>055</u>	Zoning District C-2, Con	nmercial
Present Use(s) Aut	to Sales		

Description of Special Use (attach additional pages as needed): Expanding display area and storage parking for existing auto sales use.

The undersigned does hereby request a public hearing before the Holland Charter Township Planning Commission for consideration of Special Use approval.

A hearing fee of \$350.00 shall be submitted with eleven (11) complete copies of: this form, the site plan review requirements list including a response to each item listed, and the site plan including an electronic copy of the site plan on CD or other file sharing device.

Site plans required for Special Use consideration <u>MUST</u> be submitted with this form. Applications submitted without the required site plans shall not be accepted. The copies must be submitted to the Zoning Administrator no later than four (4) weeks prior to the hearing date.

NOTE: You are required to be present at the hearing to present your application. You will be notified as to date and time. Your neighbors within 300 feet will also be notified concerning this hearing.


Property Owner's Certification

I, the undersigned owner of the above-described property, certify that I understand conditions and restrictions may be placed upon this special use approval as deemed necessary by the Holland Charter Township Planning Commission and hereby agree to conform to and abide by any and all such conditions and restrictions.

I, acknowledge there are Specific Special Land Use Approval Standards in addition to those outlined in Section 15.3 (below) that apply to the following uses and by selecting a use below further acknowledge they have reviewed the associated standards and have addressed each of them in this submittal:


-	Special Use – Earth-sheltered Building
	Special Use — Mineral Extraction
***************************************	Special Use – Wireless Communications


I further agree to authorize members of the Planning Commission and representatives from the Holland Charter Township Building Department to enter my property in order to review the particulars of my request.

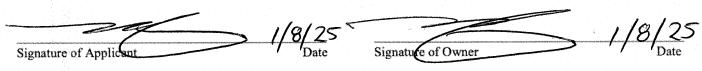

Section 15.3 - General Standards of Approval. The Planning Commission shall review the particular circumstances and facts applicable to each proposed special land use with respect to the following standards:

- The use is designed and constructed, and will be operated and maintained to be harmonious and appropriate in appearance
 with the existing or intended character of the general vicinity; will be compatible with adjacent uses of land; and will not
 change the essential character of the area in which it is proposed.
- The use is, or as a result of the special land use approval, will be served adequately by public services and facilities, including, but not limited to, streets, police and fire protection, drainage structures, refuse disposal, water and sewer facilities, and schools.
- 3. The use will not involve activities, processes, materials and equipment or conditions of operation that will be detrimental to any persons, property or the general welfare due to traffic, noise, smoke, fumes, glare, vibration, or odors.
- 4. The special land use will be consistent with the intent and purposes of this ordinance and the most recent updates to the Holland Charter Township Comprehensive Plan.
- 5. It will not be hazardous or disturbing to existing or future uses in the same general vicinity and in the community as a whole.
- It will not create excessive additional requirements at public cost for infrastructure and will not be detrimental to the economic welfare of the community.
- 7. It will ensure that the environment shall be preserved in its natural state, insofar as practicable, by minimizing tree and soil removal and topographic modifications, which result in maximum harmony with adjacent areas.
- 8. It shall conform with all specific requirements applicable to the proposed use, as applicable.
- 9. The use will not result in traffic congestion, nor have an adverse impact on roads, nor cause hazards.
- 10. There is need for the proposed use within the township.

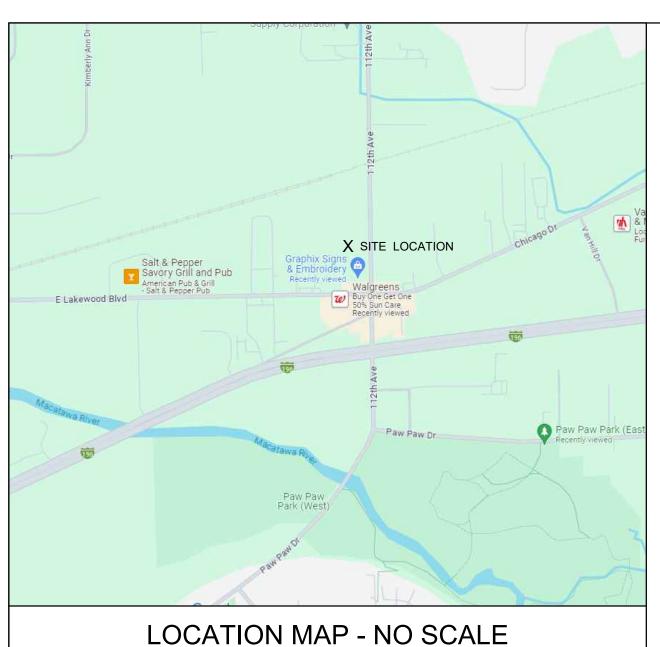

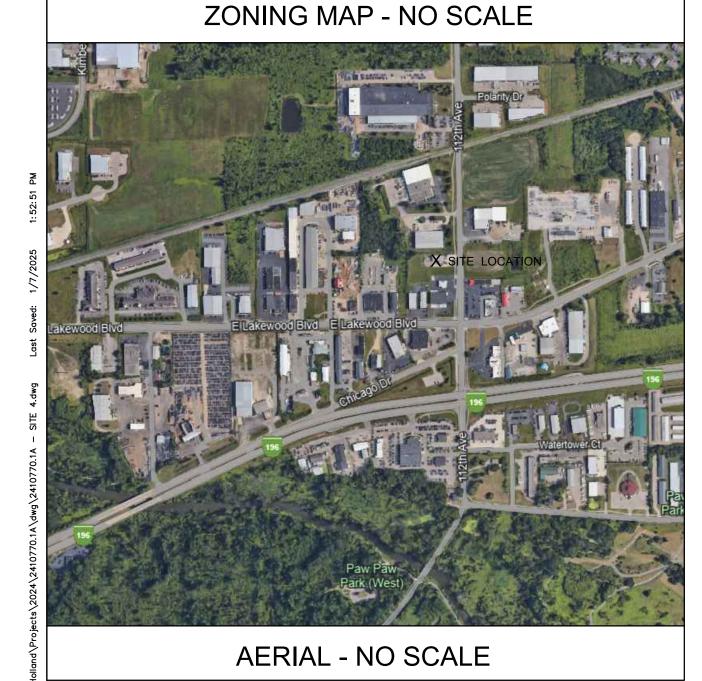

CC EQUITIES C/O AUTO EXCHANGE OF HOLLAND, LLC AUTO EXCHANGE OF HOLLAND

2065 112TH AVENUE SECTION 22, T05N, R15W HOLLAND, MICHIGAN 49424

SHEET INDEX

G-001	TITLE SHEET

V-101 EXISTING TOPOGRAPHIC PLAN

CD-101 CIVIL DEMOLITION PLAN

C-101 SITE PLAN

STORM SEWER, GRADING AND SOIL EROSION CONTROL PLAN C-102

C-501 DETAILS

L-100 LANDSCAPING PLAN EX-1 WATERSHED EXHIBIT



ISSUED FOR **APPROVAL**

SITE ADDRESS

AUTO EXCHANGE OF HOLLAND 2065 112TH AVENUE HOLLAND, MI 49424

OWNER CC EQUITIES C/O AUTO EXCHANGE OF HOLLAND, LL 2065 112TH AVENUE HOLLAND, MI 49424

(616) 566-7209 MARK McCOMB chip@autoexchangeofholland.com

CIVIL ENGINEER

DRIESENGA & ASSOCIATES, INC. 12330 JAMES STREET, SUITE H80 HOLLAND, MICHIGAN 49424 (616) 396-0255 JOHN TENPAS, P.E. johnt@driesenga.com

DRIESENGA & ASSOCIATES, INC Engineering

Surveying Testing

Holland, MI 616-396-0255

Grand Rapids, MI

616-249-3800 Kalamazoo, MI

269-544-1455

517-889-6210

Ypsilanti, MI 734-368-9483

ISSUED FOR:

OWNER REVIEW 12-22-2024 D: AA C: TLH 01-07-2024 D: AA C: TLF

JOHN TENPAS

TITLE SHEET

G-001 1 of 7



SCHEDULE "A" LEGAL DESCRIPTION FROM: TRANSNATION TITLE AGENCY OF MICHIGAN LAKESHORE DIVISION FILE NO.: 447258LKS (EFFECTIVE DATE: OCTOBER 10, 2024)

PART OF THE NORTHEAST 1/4 OF SECTION 22. TOWN 5 NORTH, RAGE 15 WEST, HOLLAND TOWNSHIP, OTTAWA COUNTY, MICHIGAN, DESCRIBED AS: BEGINNING AT A POINT ON THE EAST LINE OF SECTION 22, DISTANT NORTH 00 DEGREES 15 MINUTES 22 SECONDS EAST 398.85 FEET FROM THE EAST 1/4 CORNER OF SECTION 22 AND PROCEEDING THENCE SOUTH 89 DEGREES 58 MINUTES 14 SECONDS WEST 383.00 FEET PARALLEL WITH THE EAST AND WEST 1/4 LINE OF SECTION 22; THENCE NORTH 00 DEGREES 15 MINUTES 02 SECONDS EAST 101.15 FEET; THENCE NORTH 89 DEGREES 58 MINUTES 14 SECONDS EAST 383.00 FEET; THENCE ALONG THE EAST LINE OF SECTION 22, *SOUTH 00 DEGREES 15 MINUTES 02 SECONDS EAST 101.15 FEET TO THE POINT OF BEGINNING.

*POSSIBLE TYPOGRAPHICAL ERROR: <u>SOUTH 00 DEGREES 15 MINUTES 02 SECONDS EAST</u> SHOULD BE <u>SOUTH 00 DEGREES 15 MINUTES 02 SECONDS WEST</u>. FURTHER RESEARCH RECOMMENDED.

SCHEDULE B-II MATTERS CONCERNING THE PROPERTY FROM: TRANSNATION TITLE AGENCY OF MICHIGAN LAKESHORE DIVISION FILE NO.: 447258LKS (EFFECTIVE DATE: OCTOBER 10, 2024)

RIGHT(S) OF WAY AND/OR EASEMENT(S) AND THE RIGHTS INCIDENTAL THERETO, AS GRANTED IN A DOCUMENT: GRANTED TO: CONSUMERS POWER COMPANY (NOW KNOWN AS CONSUMERS ENERGY) LIBER: 270, PAGE: 215. (BLANKET EASEMENT OVER ENTIRE PARCEL, ROUTE SHOWN ON DRAWING)

SURVEY CONTROL

GROUND COORDINATES AS DERIVED FROM THE MICHIGAN STATE PLANE COORDINATE SYSTEM, SOUTH ZONE, INTERNATIONAL FEET. SURVEY DATA AND CONTROL HAVE BEEN PROJECTED TO THE GROUND AT EAST 1/4 COR (GRID TO GROUND SCALE FACTOR: 1:1.0001157176)

POINT NUMBER	NORTHING (GROUND)	EASTING (GROUND)	ELEVATIO (NAVD 88
51	480522.9573'	12669092.3183'	605.19'
53	480559.2613'	12669465.4939'	606.72'
54	480545.2355'	12669165.6666'	605.27'
55	480684.2433'	12669273.9281'	611.46'

TIN: 70-16-22-200-016

11269 LAKEWOOD BLVD

IRON (HEI)

CB #1 - 2'Ø CONCRETE MH-A - 4'Ø CONCRETE RIM 606.02 RIM 606.70 INV (S) 6" PVC=605.50 INV (N) 15" PVC=590.82 SUMP=605.50

CB #2 - 2'Ø CONCRETE MH-B - 4'Ø CONCRETE RIM 606.40 RIM 612.77 INV (NW) 6" PVC=604.83 INV (N) 15" PVC=591.37 INV (S) 6" PVC=604.80 INV (S) 15" PVC=591.32 SUMP=604.42

CB #3 - 4'Ø CONCRETE RIM 605.57 INV (W) 6" PVC=603.02 INV (N) 15" CPE=602.47 INV (E) 12" RCP=602.17 SUMP=600.22

STORM

STRUCTURE DATA

RIM 606.37 UNABLE TO OPEN CB #5 - 1'Ø CLAY

INV (S) 3" PVC=605.73

MH #4

RIM 606.58

≻1.0'± NORTH OF PROPERTY LINE

TIN: 70-16-22-200-055

SUMP=605.38

INV (S) 15" PVC=590.80

TIN: 70-16-22-200-062 KSG PROPERTIES LLC

______M= S89'49'07"E 383.00'

ASPHALT CORNER IS 0.4'± NORTH OF

SANITARY

STRUCTURE DATA

1. UTILITIES SHOWN ARE APPROXIMATE LOCATIONS DERIVED FROM ACTUAL FIELD MEASUREMENTS AND AVAILABLE RECORDS. THIS MAP IS NOT TO BE INTERPRETED AS SHOWING EXACT LOCATIONS OR SHOWING ALL UTILITIES IN THE AREA.

SURVEYOR'S NOTES

2. NOTE TO CONTRACTORS: THREE WORKING DAYS BEFORE YOU DIG - CALL MISS DIG AT 811.

TOPOGRAPHIC / BOUNDARY SURVEY

3. CONTOUR INTERVAL = 1 FOOT.

4. BY GRAPHIC PLOTTING ONLY, THIS PROPERTY IS IN ZONE(S) "X" OF THE FLOOD INSURANCE RATE MAP, COMMUNITY PANEL NO. 26139C0316E, WHICH BEARS AN EFFECTIVE DATE OF DECEMBER 16, 2011. ZONE "X" AREAS DETERMINED TO BE OUTSIDE OF 0.2% ANNUAL CHANCE FLOODPLAIN.

5. THE FIELD WORK WAS COMPLETED ON OCTOBER OCTOBER 18, 2024.

BENCHMARK DATA

NAVD '88 AS DERIVED FROM PREVIOUS DRIESENGA & ASSOCIATES PROJECT NO. 2410360.5A DATED 05/28/2024.

BM #1 EL= 605.99' (NAVD 88)

D= N89°58'14"E 383.00'

RETAINING WALL IS

(OVERHEAD DOOR)

SET COTTON SPINDLE IN NORTH SIDE OF UTILITY POLE, LOCATED 25'± WEST OF THE CENTERLINE OF 112TH AVENUE AND 15'± NORTH OF THE CENTERLINE OF THE NORTH DRIVEWAY ENTRANCE TO GRAPHIX.

BM #2 EL= 607.66' (NAVD 88) SET "X" ON THE UPPER NORTH SIDE OF CONCRETE LIGHT POLE BASE, LOCATED 195'± WEST OF THE CENTERLINE OF 112TH AVENUE AND 1'± SOUTH OF THE SOUTH EDGE OF ASPHALT DRIVE FOR AUTOMOTIVE EXCHANGE.

BM #3 EL= 609.25' (NAVD 88) SET COTTON SPINDLE IN THE WEST SIDE OF UTILITY POLE, LOCATED 35'± WEST OF THE CENTERLINE OF 112TH AVENUE AND 35'± NORTH OF THE CENTERLINE OF AUTOMOTIVE EXCHANGE DRIVE ENTRANCE.

8" CONC RETAINING WALL

ONE STORY

EL=607.62

OVERHEAD DOOR)

(CONCRETE)

BRICK/SHEET METAL BUILDING

EL=607.66

厂(OVERHEAD

EL=607.67

_ 4 _ - 4 _ - 4

(STOOP)

FF=607.66

COMMUNICATION PER

RETAINING WALL IS

CONCRETE CORNER IS 0.8'± SOUTH OF

OVERHEAD SIGN IS

LOCATION OF GAS SERVICE PER SEMCO

DESC IN EASEMENT
GRANTED TO CONSUMERS
POWER COMPANY REC.

COMMUNICATION PER AT&T MISS DIG MAP



- COMCAST - 10/14/2024 (MAPS PROVIDED)

- SEMCO ENERGY - 10/16/2024 (MAPS PROVIDED)

- CONSUMERS ENERGY UNDER GROUND ELECTRIC - 10/14/2024 (RESPONSE RECEIVED - CLEAR)

- ACD.NET - 10/10/2024 (MAPS PROVIDED)

NOT TO SCALE


BM #1

CORNER OF SEC 22, TO5N, R15W

- HOLLAND BPW - 10/14/2024 (MAPS PROVIDED)


- HOLLAND CHARTER TOWNSHIP - 10/10/2024 (MAPS PROVIDED)

- EVERSTREAM - 10/14/2024 (RESPONSE RECEIVED - CLEAR)

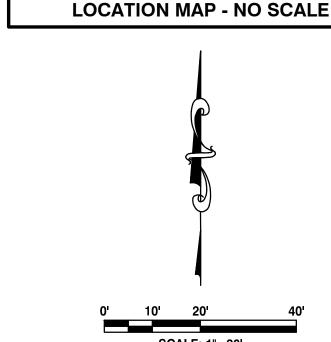

X SITE LOCATION


SET CONCRETE MONUMENT MONUMENT FOUND SET CAPPED REBAR #62695 FOUND IRON SET CHISELED "X" FOUND CHISELED "X" CONTROL POINT PLATTED DESCRIBED STORM SEWER MANHOLE $\oplus \blacksquare \blacksquare$ **CATCH BASIN** ROOF DRAIN WELL HEAD FIRE HYDRANT FIRE DEPARTMENT CONNECTION SPRINKLER CONTROL VALVE SPRINKLER HEAD VALVE (WATER & GAS) **GAS METER** UTILITY RISERS E_{RS} G_{RS} T_{RS} F_{RS} C_{RS} **UTILITY POLE** LIGHT POLE **GUY ANCHOR** TRANSFORMER HAND HOLE (ELECTRIC ELECTRIC METER GROUND MOUNTED LIGHT SOIL BORING **BOLLARD POST** UNDERGROUND ELECTRIC LINE MARKER FENCE LINE **OVERHEAD UTILITIES** UNDERGROUND ELECTRI COMMUNICATIONS **GAS LINE EXISTING WATER LINI** ___ w ___ EXISTING STORM SEWE EXISTING SANITARY SEWER BITUMINOUS SURFACE CONCRETE SURFACE

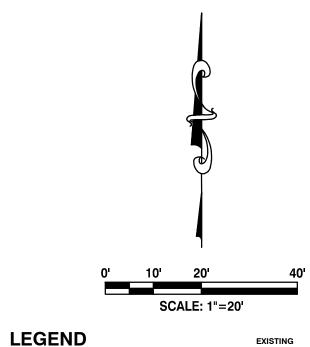


DECIDUOUS TREE

GRAVEL SURFACE ORNAMENTAL BUSH

SURVEY

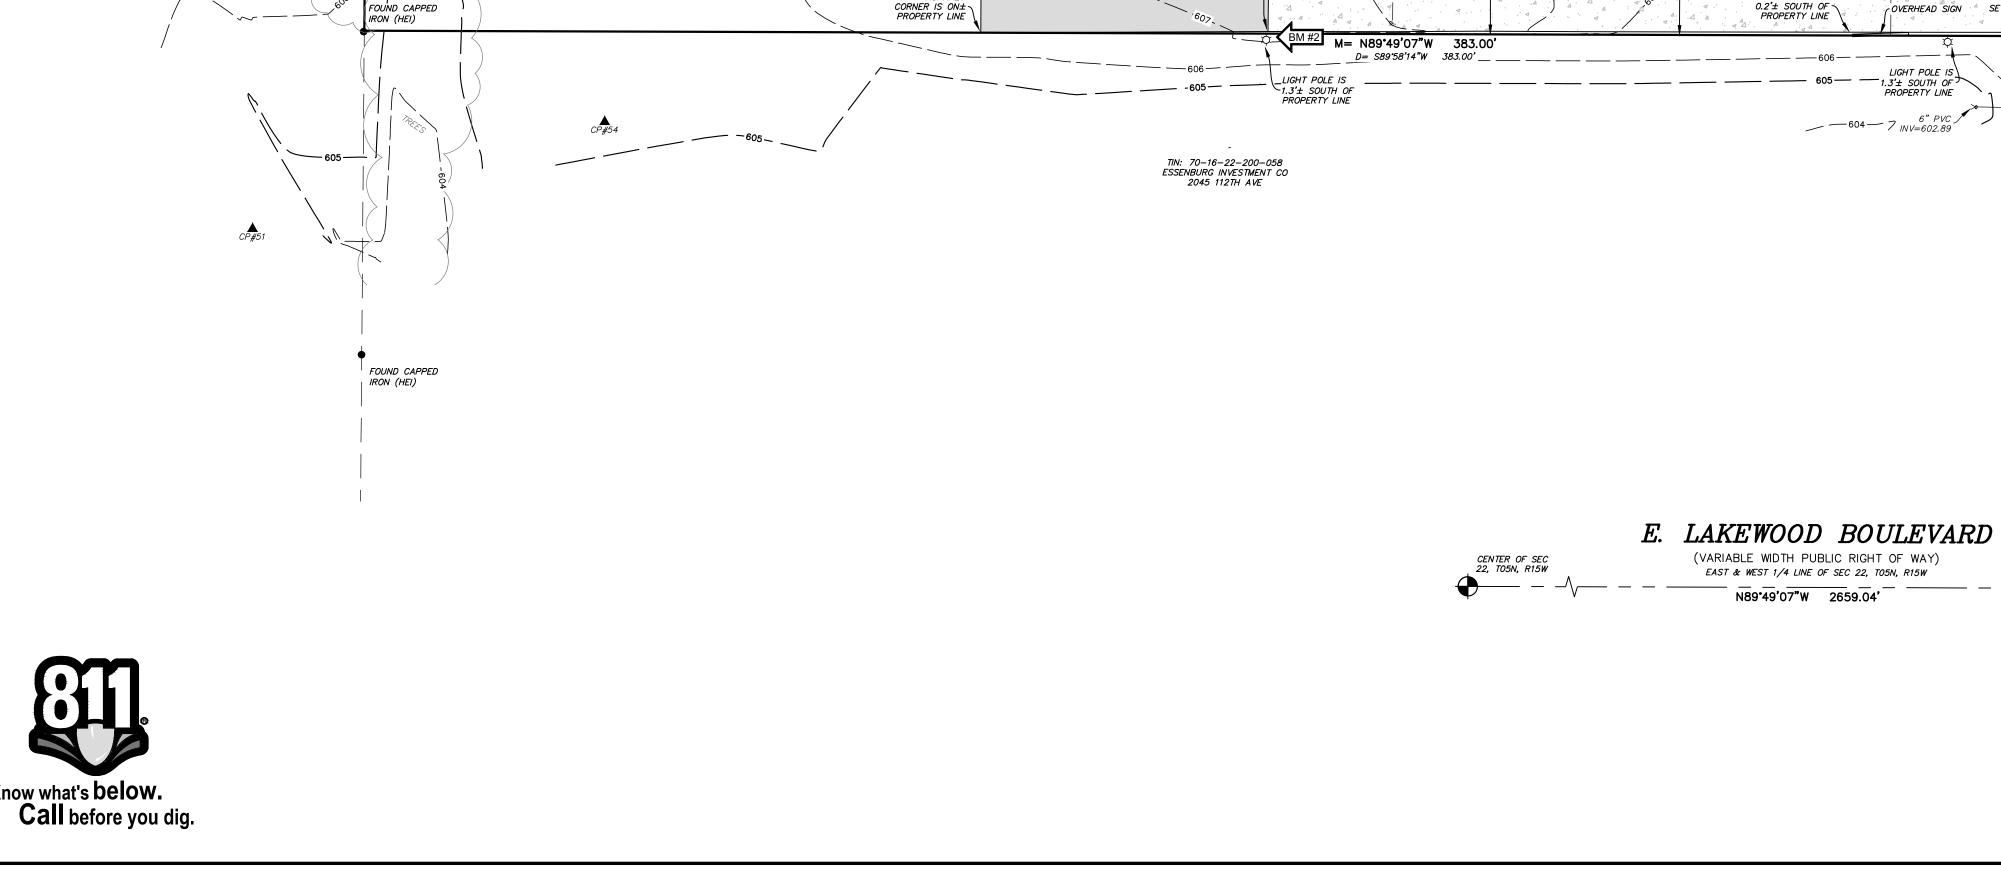

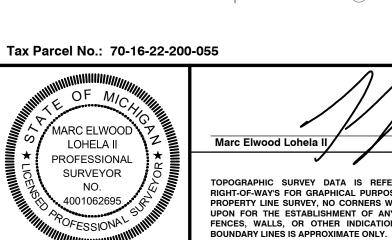

UPON FOR THE ESTABLISHMENT OF ANY PROPERTY LINES. THE LOCATION OF FENCES, WALLS, OR OTHER INDICATIONS OF OCCUPANCY ALONG OR NEAR

OPOGRAPHIC SURVEY DATA IS REFERENCED TO SECTION LINES AND/OR RIGHT-OF-WAY'S FOR GRAPHICAL PURPOSES ONLY. IT DOES NOT REPRESENT A PROPERTY LINE SURVEY, NO CORNERS WERE SET, AND IT SHALL NOT BE RELIED

Know what's below.

MJD 1"=20'

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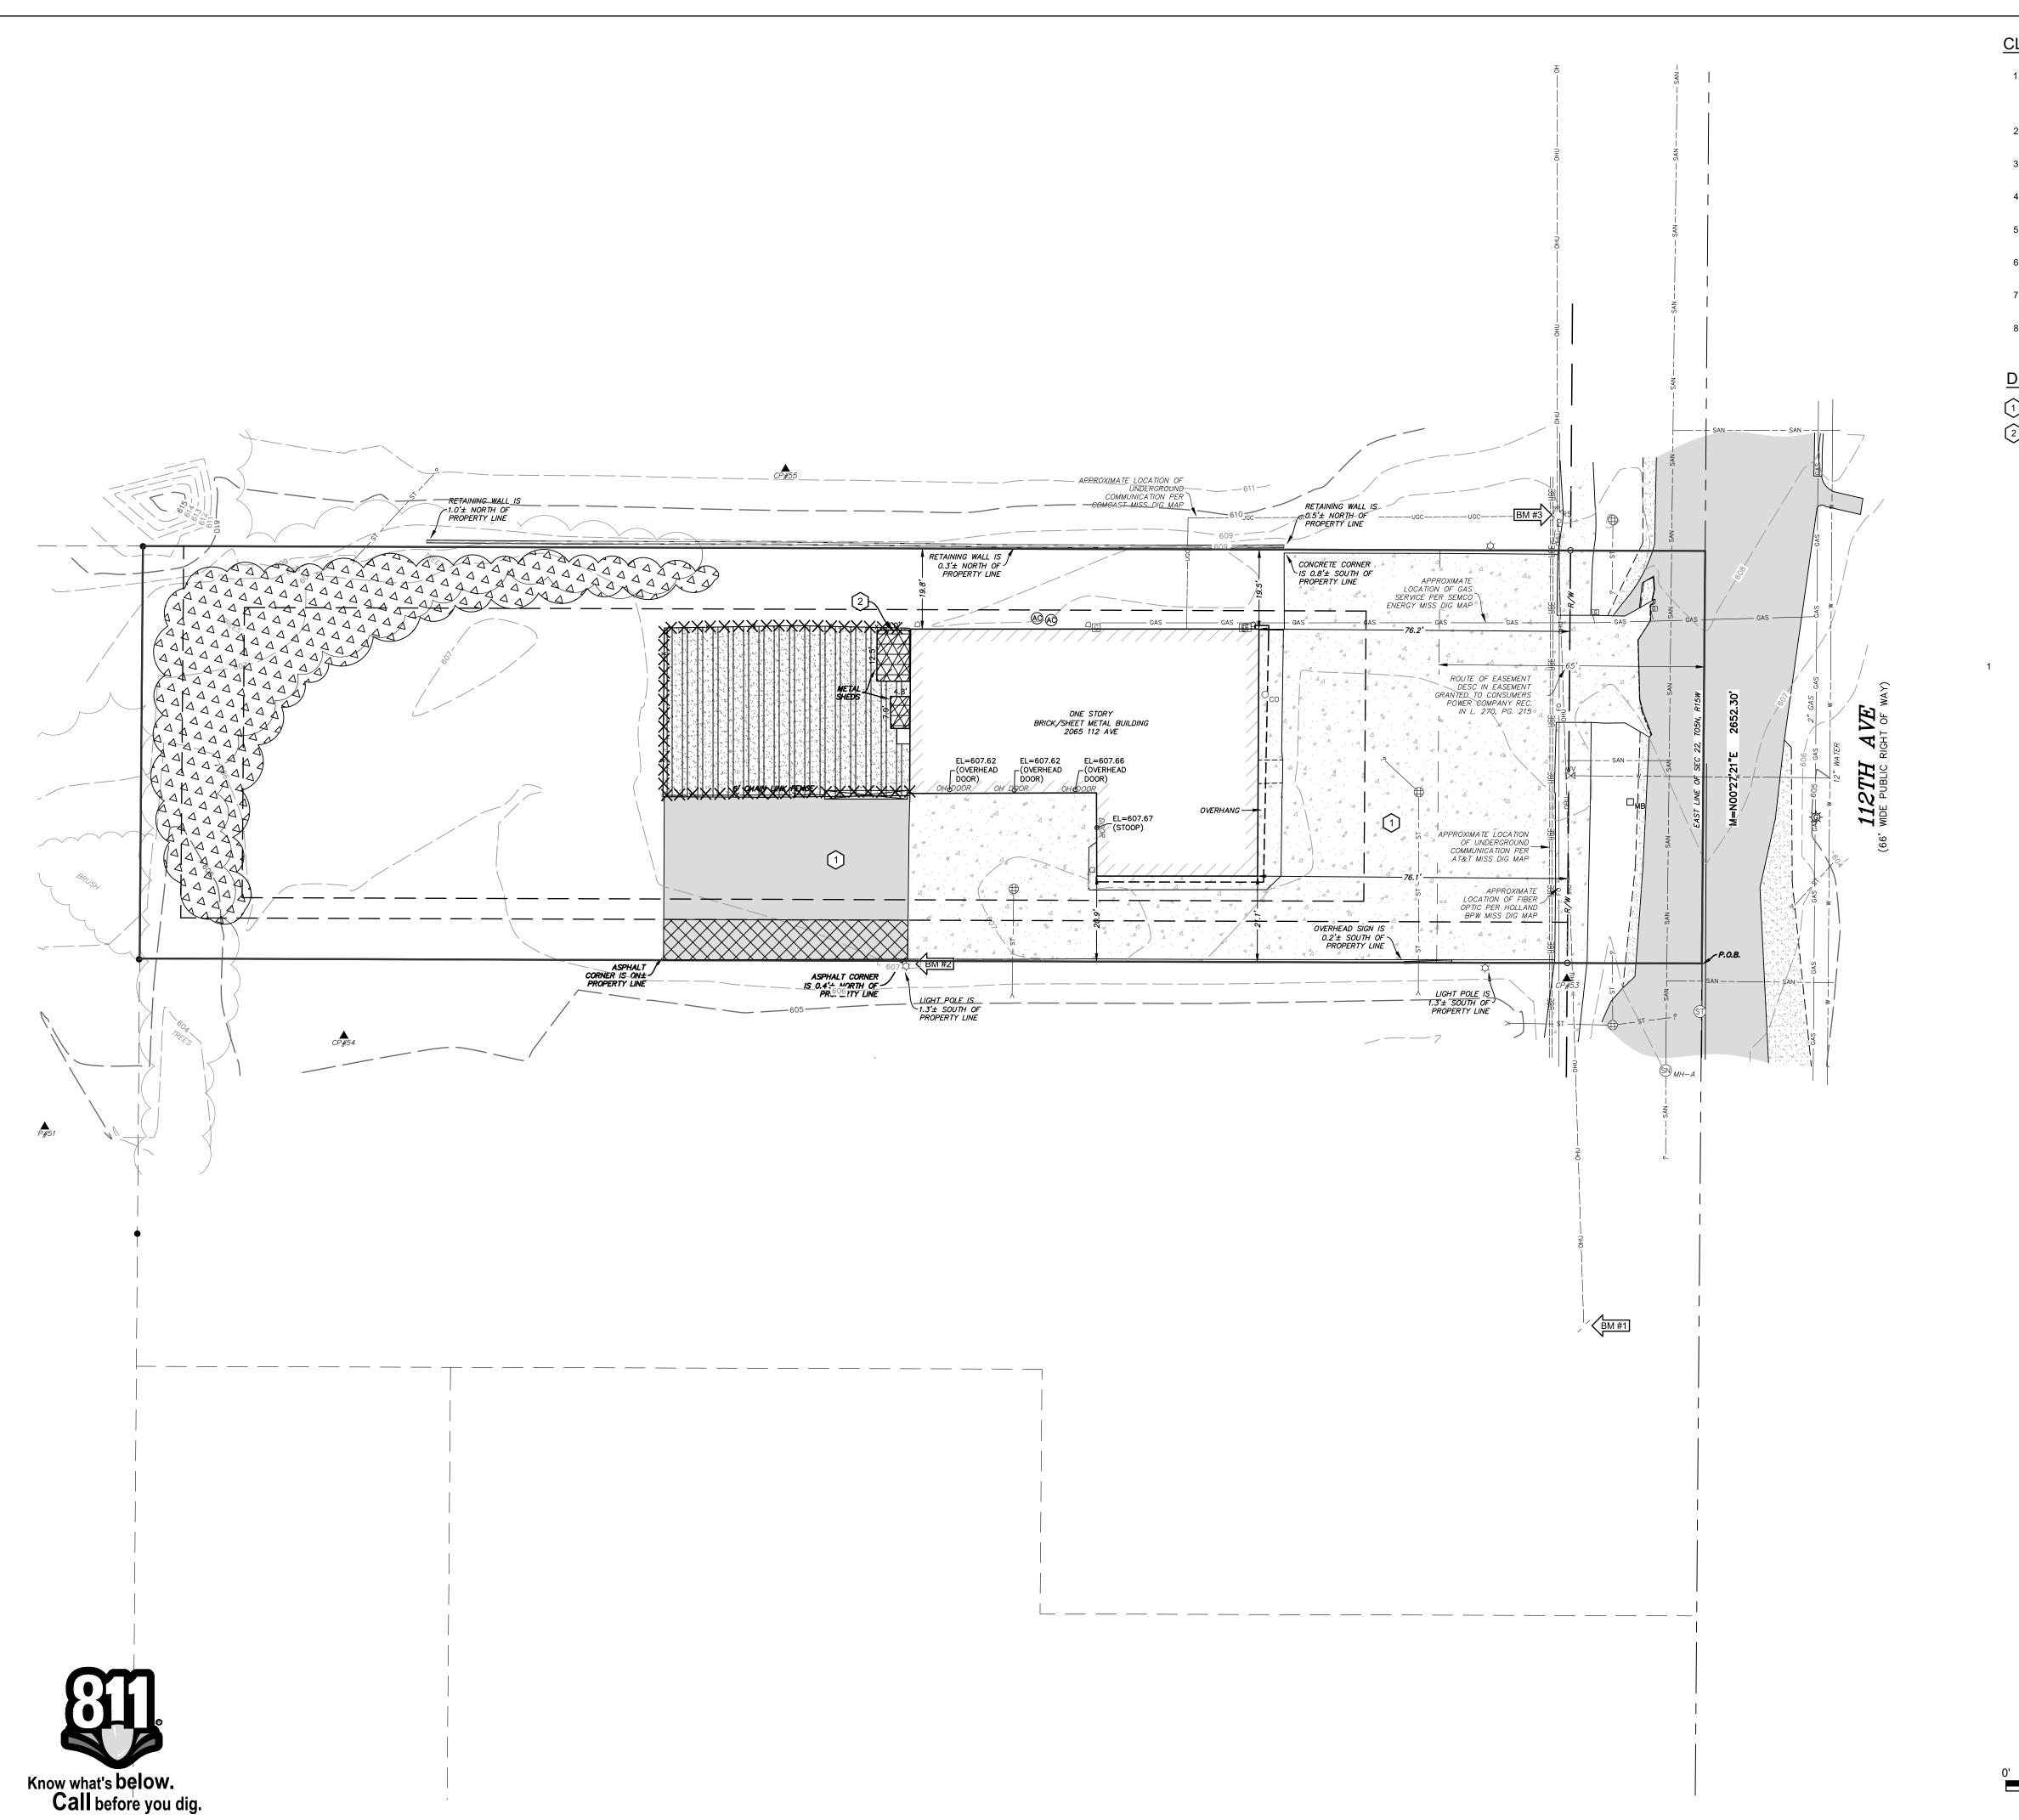
REVISIONS

HOLL/

10-23-2024 2410770.5A

TOPOGRAPHIC / BOUNDARY

1 of 1




CLEARING & DEMOLITION NOTES:

- 1. REMOVE ALL STRUCTURES, SUPPORT COLUMNS, FOOTINGS, ASPHALT PAVING, CONCRETE CURB, SIDEWALKS, CONCRETE PADS, TREES, STUMPS, HEDGES, UTILITIES, AND OTHER EXISTING SITE FEATURES WITHIN LIMITS OF DEMOLITION. ALL DEMOLITION MATERIALS SHALL BE REMOVED FROM THE SITE UNLESS OTHERWISE INDICATED AND DISPOSED OF IN A MANNER ACCEPTABLE TO AUTHORITIES HAVING JURISDICTION.
- 2. MOVEMENT OF CLEARED WOOD IS RESTRICTED; REFER TO EMERALD ASH BORER QUARANTINE INFORMATION AT WWW.MICHIGAN.GOV. CONTRACTOR IS RESPONSIBLE FOR COMPLYING WITH ALL QUARANTINE REQUIREMENTS.
- 3. CONSTRUCTION FENCE SHALL BE PLACED AT THE DRIP LINE OF ALL TREES WITHIN THE PROJECT AREA THAT ARE INDICATED TO BE PROTECTED. DO NOT OPERATE EQUIPMENT OR STORE MATERIALS OR VEHICLES WITHIN THIS AREA.
- 4. UNLESS INDICATED TO BE ABANDONED IN PLACE, ALL UTILITIES TO BE DEMOLISHED SHALL BE REMOVED IN THEIR ENTIRETY. UTILITIES TO BE ABANDONED IN PLACE SHALL BE FILLED WITH FLOWABLE FILL AND SECURELY CAPPED.
- 5. EXCEPT FOR THOSE UTILITIES INDICATED TO BE ABANDONED OR REMOVED, RECONNECT ALL UTILITIES ENCOUNTERED DURING CONSTRUCTION.
- 6. ALL CATCHBASIN AND MANHOLE FRAMES AND COVERS SPECIFIED TO BE REMOVED SHALL BE SALVAGED, CLEANED AND INSPECTED, AND MAY BE REUSED WITH APPROVAL BY ENGINEER.
- 7. ANY REMOVAL OF PAVEMENT, SIDEWALK, CURB AND GUTTER OR OTHER HARD SURFACES SHALL BE TO A SAWCUT LINE AT THE NEXT JOINT BEYOND REMOVAL LIMITS SHOWN.
- 8. DEMOLITION WORK IS INDICATED BASED ON BEST AVAILABLE INFORMATION. CONTRACTOR SHALL INSPECT THE SITE AND BE FAMILIAR WITH THE EXTENT OF DEMOLITION WORK REQUIRED.

DEMOLITION KEY:

- 1 PROTECT EX. PAVEMENT TO REMAIN
- 2 SALVAGE AND RELOCATE EXISTING SHED(S) COORD W/ OWNER



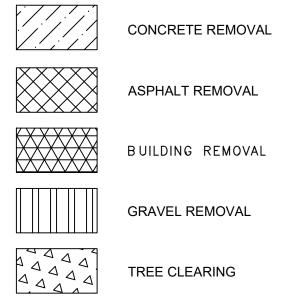



TREE/SHRUB REMOVAL

XXXX FENCE/WALL/UTILITY/MISC. REMOVAL



PROPOSED SANITARY SEWER

EXISTING
EXISTING
BITUMINOUS SURFACE

PROPOSED
BITUMINOUS SURFACE

CONCRETE SURFACE

CONCRETE SURFACE

CONCRETE SURFACE

CONCRETE SURFACE

CONCRETE SURFACE

CONCRETE SURFACE


ORNAMENTAL BUSH

FIBER OPTIC GAS LINE

EXISTING WATER LINE

EXISTING STORM SEWER
PROPOSED STORM SEWER

ISSUED FOR APPROVAL

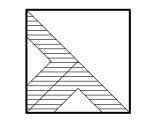

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AUTO EXCHANGE OF HOLLAND
2065 112TH AVENUE
CTION 22, T05N, R15W, HOLLAND CHARTER TWP., OTTAWA CO
-FORQUITIES C/O AUTO EXCHANGE OF HOLLAND, I
2065 112TH AVENUE. HOLLAND MI 49424

ISSUED FOR:	
1	OWNER REVIEW 12-22-2024 D: AA C: TLH
2	TOWNSHIP REVIEW 01-07-2024 D: AA C: TLH

JOHN TENPAS

Project #
2410770.1A

Sheet Title:

CIVIL


DEMOLITION

Project Manager:

CIVIL DEMOLITION PLAN

Sheet #

CD-101

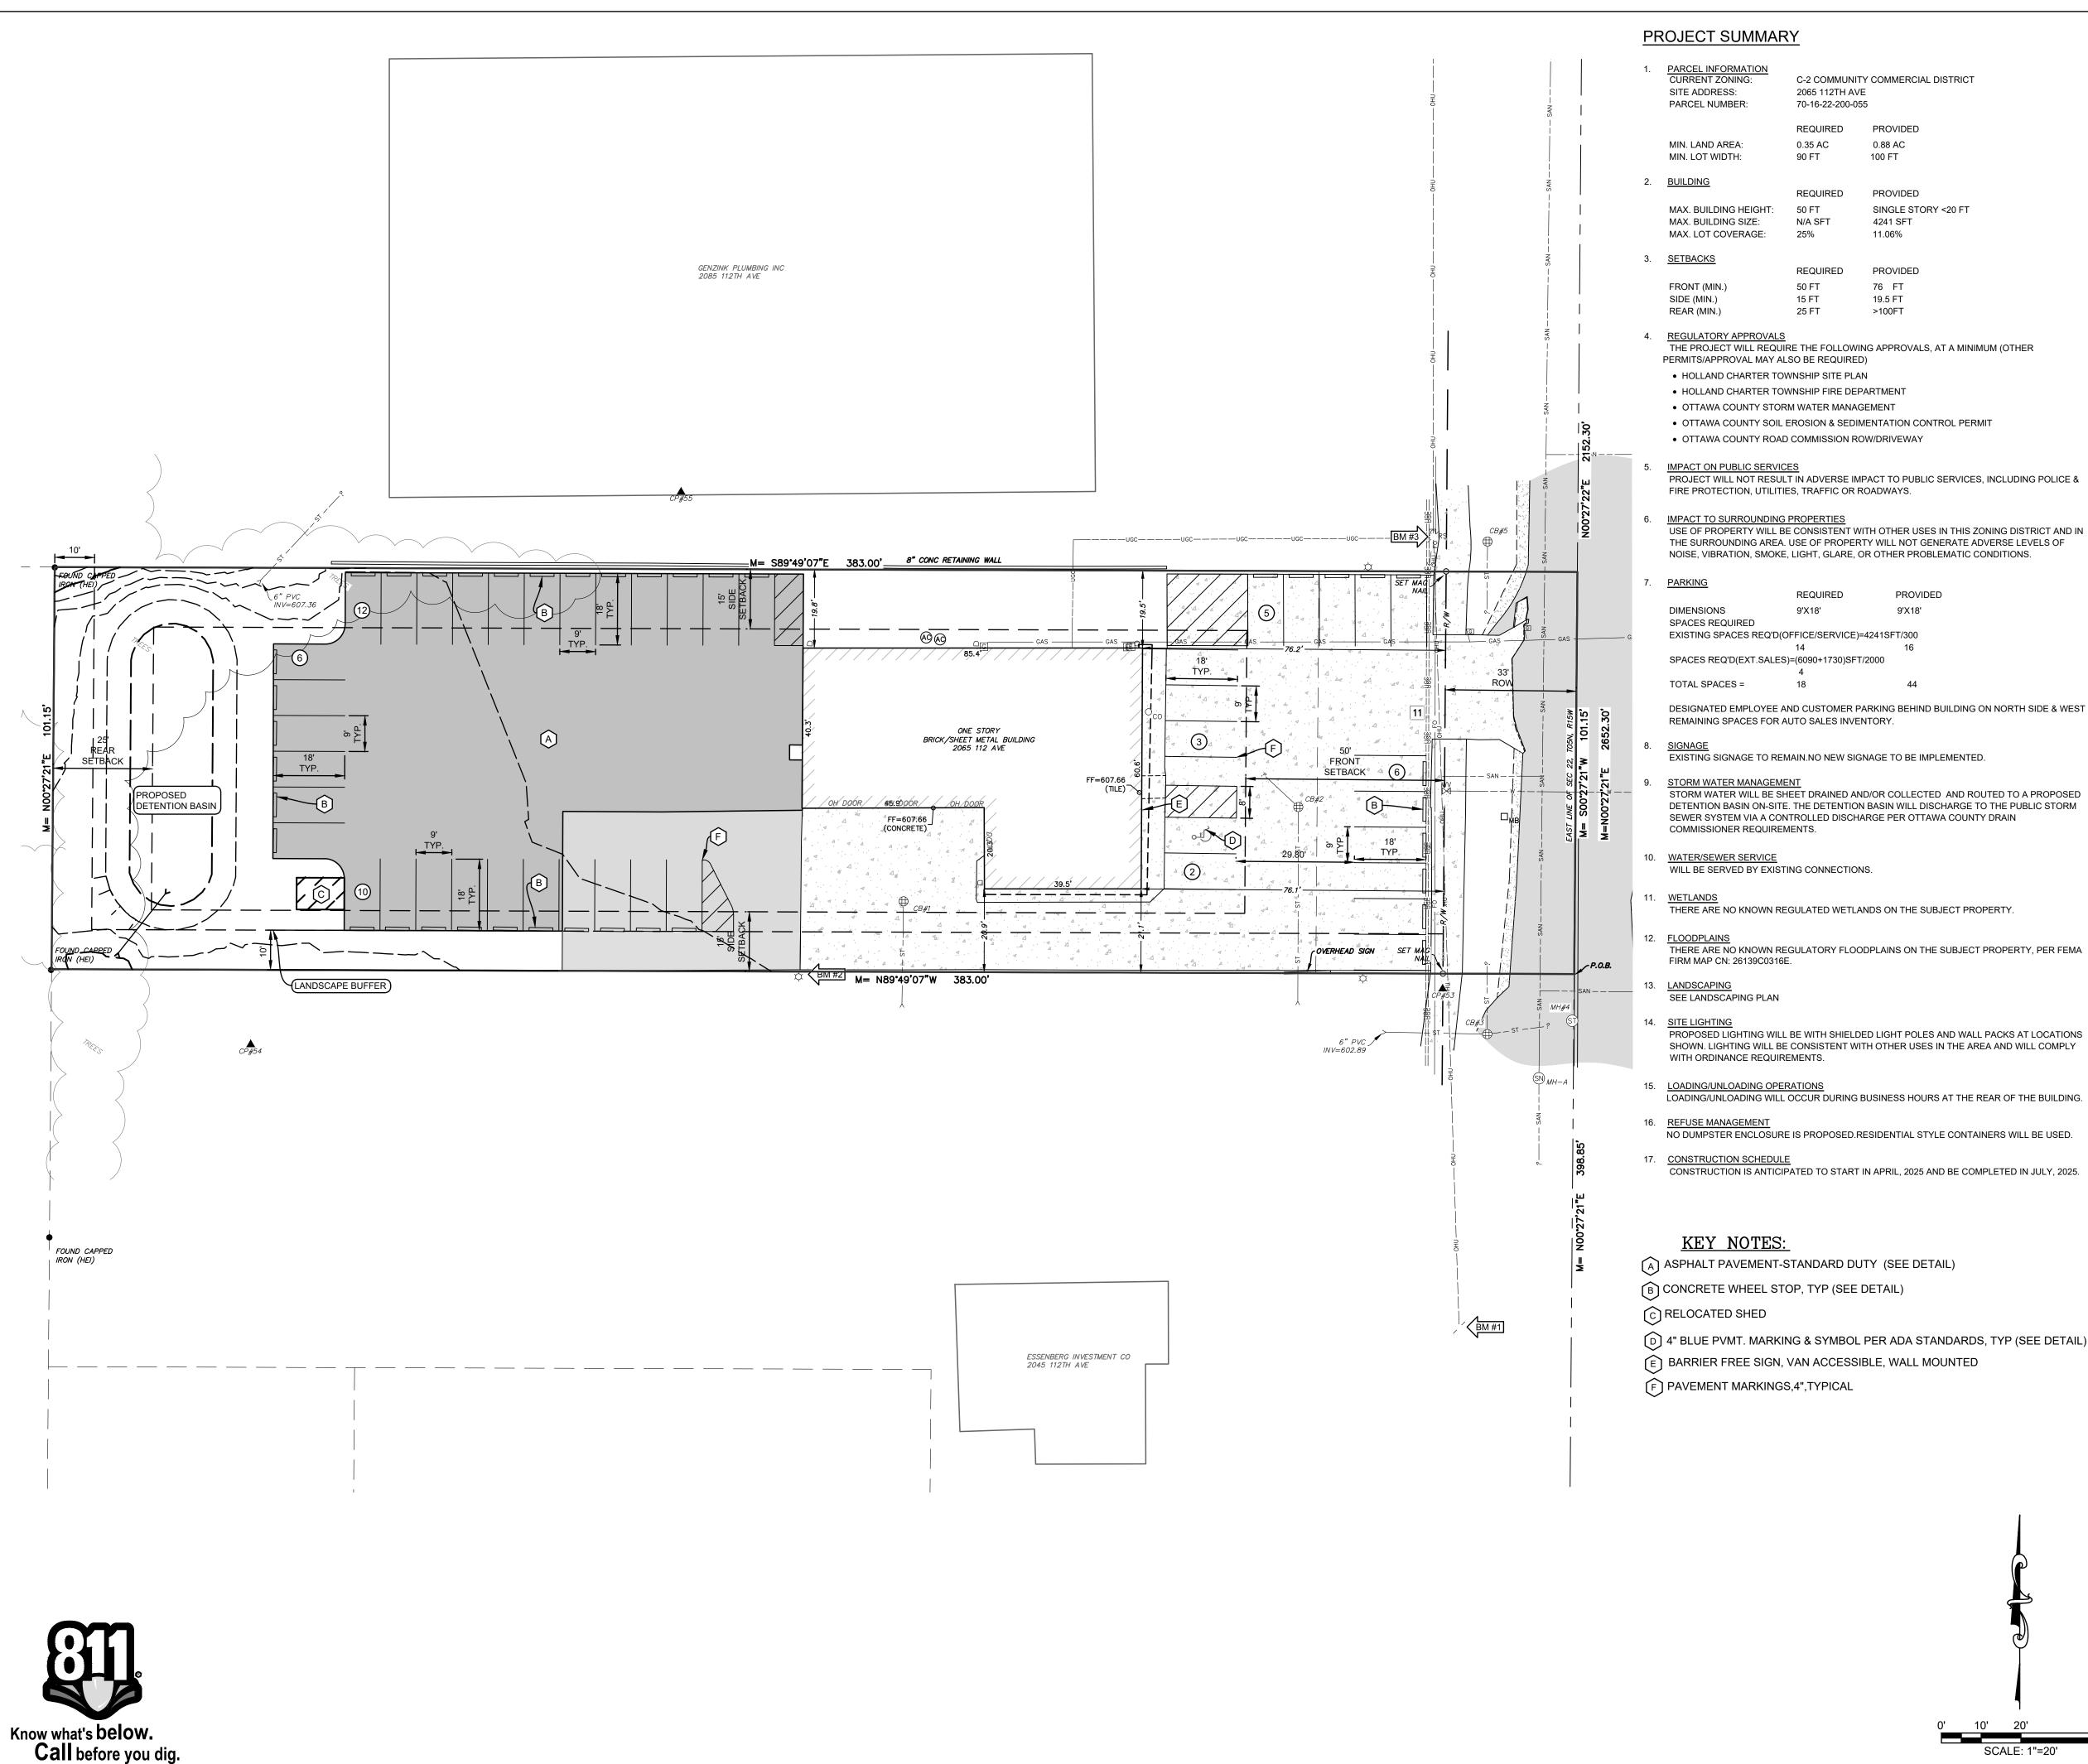

- C-2 COMMUNITY COMMERCIAL DISTRICT 2065 112TH AVE 70-16-22-200-055 REQUIRED PROVIDED 0.88 AC
- PROVIDED 50 FT SINGLE STORY <20 FT

100 FT

76 FT

19.5 FT

>100FT

- N/A SFT 4241 SFT 25% 11.06% REQUIRED PROVIDED
- THE PROJECT WILL REQUIRE THE FOLLOWING APPROVALS, AT A MINIMUM (OTHER
- PERMITS/APPROVAL MAY ALSO BE REQUIRED)
- HOLLAND CHARTER TOWNSHIP SITE PLAN

- OTTAWA COUNTY SOIL EROSION & SEDIMENTATION CONTROL PERMIT

PROJECT WILL NOT RESULT IN ADVERSE IMPACT TO PUBLIC SERVICES, INCLUDING POLICE & FIRE PROTECTION, UTILITIES, TRAFFIC OR ROADWAYS.

USE OF PROPERTY WILL BE CONSISTENT WITH OTHER USES IN THIS ZONING DISTRICT AND IN THE SURROUNDING AREA. USE OF PROPERTY WILL NOT GENERATE ADVERSE LEVELS OF NOISE, VIBRATION, SMOKE, LIGHT, GLARE, OR OTHER PROBLEMATIC CONDITIONS.

	REQUIRED	PROVIDED
S	9'X18'	9'X18'
QUIRED		
PACES REC	D'D(OFFICE/SERVICE)=4	241SFT/300
	1.4	16

SPACES REQ'D(EXT.SALES)=(6090+1730)SFT/2000

STORM WATER WILL BE SHEET DRAINED AND/OR COLLECTED AND ROUTED TO A PROPOSED DETENTION BASIN ON-SITE. THE DETENTION BASIN WILL DISCHARGE TO THE PUBLIC STORM SEWER SYSTEM VIA A CONTROLLED DISCHARGE PER OTTAWA COUNTY DRAIN

WILL BE SERVED BY EXISTING CONNECTIONS.

THERE ARE NO KNOWN REGULATED WETLANDS ON THE SUBJECT PROPERTY.

THERE ARE NO KNOWN REGULATORY FLOODPLAINS ON THE SUBJECT PROPERTY, PER FEMA

PROPOSED LIGHTING WILL BE WITH SHIELDED LIGHT POLES AND WALL PACKS AT LOCATIONS SHOWN. LIGHTING WILL BE CONSISTENT WITH OTHER USES IN THE AREA AND WILL COMPLY WITH ORDINANCE REQUIREMENTS.

LOADING/UNLOADING WILL OCCUR DURING BUSINESS HOURS AT THE REAR OF THE BUILDING.

NO DUMPSTER ENCLOSURE IS PROPOSED.RESIDENTIAL STYLE CONTAINERS WILL BE USED.

CONSTRUCTION IS ANTICIPATED TO START IN APRIL, 2025 AND BE COMPLETED IN JULY, 2025.

ASPHALT PAVEMENT-STANDARD DUTY (SEE DETAIL)

(B) CONCRETE WHEEL STOP, TYP (SEE DETAIL)

(D) 4" BLUE PVMT. MARKING & SYMBOL PER ADA STANDARDS, TYP (SEE DETAIL)

BARRIER FREE SIGN, VAN ACCESSIBLE, WALL MOUNTED

(F) PAVEMENT MARKINGS,4",TYPICAL

GENERAL NOTES:

- 1. CONTRACTOR SHALL OBTAIN ALL NECESSARY LOCAL, STATE AND FEDERAL PERMITS REQUIRED.
- 2. ALL CONSTRUCTION MATERIALS AND WORKMANSHIP SHALL CONFORM TO THE
- STANDARDS AND SPECIFICATIONS OF AUTHORITIES HAVING JURISDICTION.
- 3. CALL "MISS DIG", 811, 72 HOURS PRIOR TO THE START OF ANY EXCAVATION. 4. EXISTING UNDERGROUND UTILITIES ARE SHOWN BASED ON AVAILABLE RECORDS
- AND/OR TOPOGRAPHIC SURVEY DATA. THIS PLAN MAY NOT SHOW UTILITIES IN THEIR EXACT LOCATION AND MAY NOT SHOW ALL UTILITIES IN THE AREA. 5. CONTRACTOR SHALL MAINTAIN UTILITY SERVICES AT ALL TIMES. ANY

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AND

HOLL

O≡

616-396-0255

SCHEDULED WITH THE OWNER, UTILITY PROVIDER, AND AFFECTED PROPERTIES 48 HOURS PRIOR TO THE INTERRUPTION. 6. CONTRACTOR SHALL PROTECT ALL EXISTING AND NEW CONSTRUCTION FROM

INTERRUPTION IN SERVICES TO THIS SITE OR ADJACENT SITES MUST BE

- DAMAGE. SHOULD ANY DAMAGE OCCUR, CONTRACTOR SHALL MAKE ALL NECESSARY REPAIRS AT NO COST TO THE OWNER. 7. IF ANY DISCREPANCIES OR CONFLICTS ARE FOUND, CONTRACTOR SHALL NOTIFY
- ENGINEER IMMEDIATELY PRIOR TO CONSTRUCTION OF AFFECTED WORK TO DETERMINE COURSE OF ACTION. 8. CONTRACTOR SHALL COORDINATE THEIR WORK WITH OTHER CONTRACTORS ON
- OR ADJACENT TO THE PROJECT SITE. 9. CONTRACTOR SHALL BE RESPONSIBLE FOR NOTIFYING AND COORDINATING
- THEIR WORK WITH ALL UTILITY PROVIDERS PRIOR TO CONSTRUCTION.
- 10. PROVIDE BARRIERS OR OTHER PROTECTION TO KEEP VEHICULAR AND PEDESTRIAN TRAFFIC AWAY FROM CONSTRUCTION AREA AND OFF NEWLY PAVED

LAYOUT NOTES:

BENCHMARK

CLEANOUT

WELL HEAD FIRE HYDRANT

GAS METER

UTILITY RISERS

TRANSFORMER

SOIL BORING

GATE

FENCE LINE

TELEPHONE FIBER OPTIC GAS LINE

EXISTING WATER LINE PROPOSED WATER LINE

EXISTING STORM SEWER PROPOSED STORM SEWER EXISTING SANITARY SEWER PROPOSED SANITARY SEWER

EXISTING

BITUMINOUS SURFACE

PROPOSED


CONIFEROUS TREE

BOLLARD POST

UTILITY POLE

LIGHT POLE GUY ANCHOR

- CONTRACTOR SHALL REVIEW AND VERIFY SITE LAYOUT PRIOR TO CONSTRUCTION.
- 2. CONTRACTOR SHALL ENGAGE A LICENSED SURVEYOR TO PERFORM ALL
- CONSTRUCTION LAYOUT AND STAKING AS NECESSARY. ALL COORDINATE POINTS AND DIMENSIONS GIVEN, UNLESS OTHERWISE NOTED,
- ARE TO BACK OF CURB AND FACE OF BUILDING WALL.
- 4. REFER TO ARCHITECTURAL AND STRUCTURAL DRAWINGS FOR BUILDING
- 5. INSTALL EXPANSION JOINTS AT ALL LOCATIONS WHERE NEW CONCRETE MEETS EXISTING CONCRETE OR BITUMINOUS PAVEMENT.

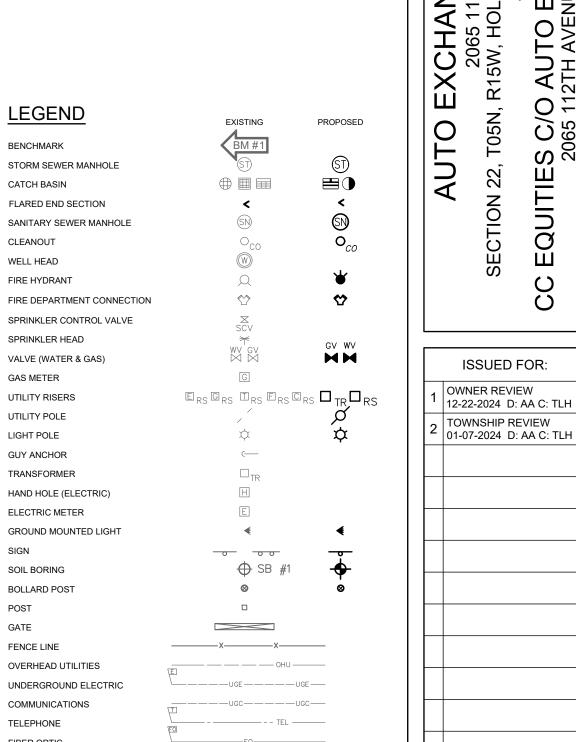

Project Manager: JOHN TENPAS Project # 2410770.1A Sheet Title:

PLAN

C-101 4 of 7


ISSUED FOR **APPROVAL**

CONCRETE SURFACE

_____ ST _____ ST ____

CONCRETE SURFACE GRAVEL SURFACE

DECIDUOUS TREE ORNAMENTAL BUSH

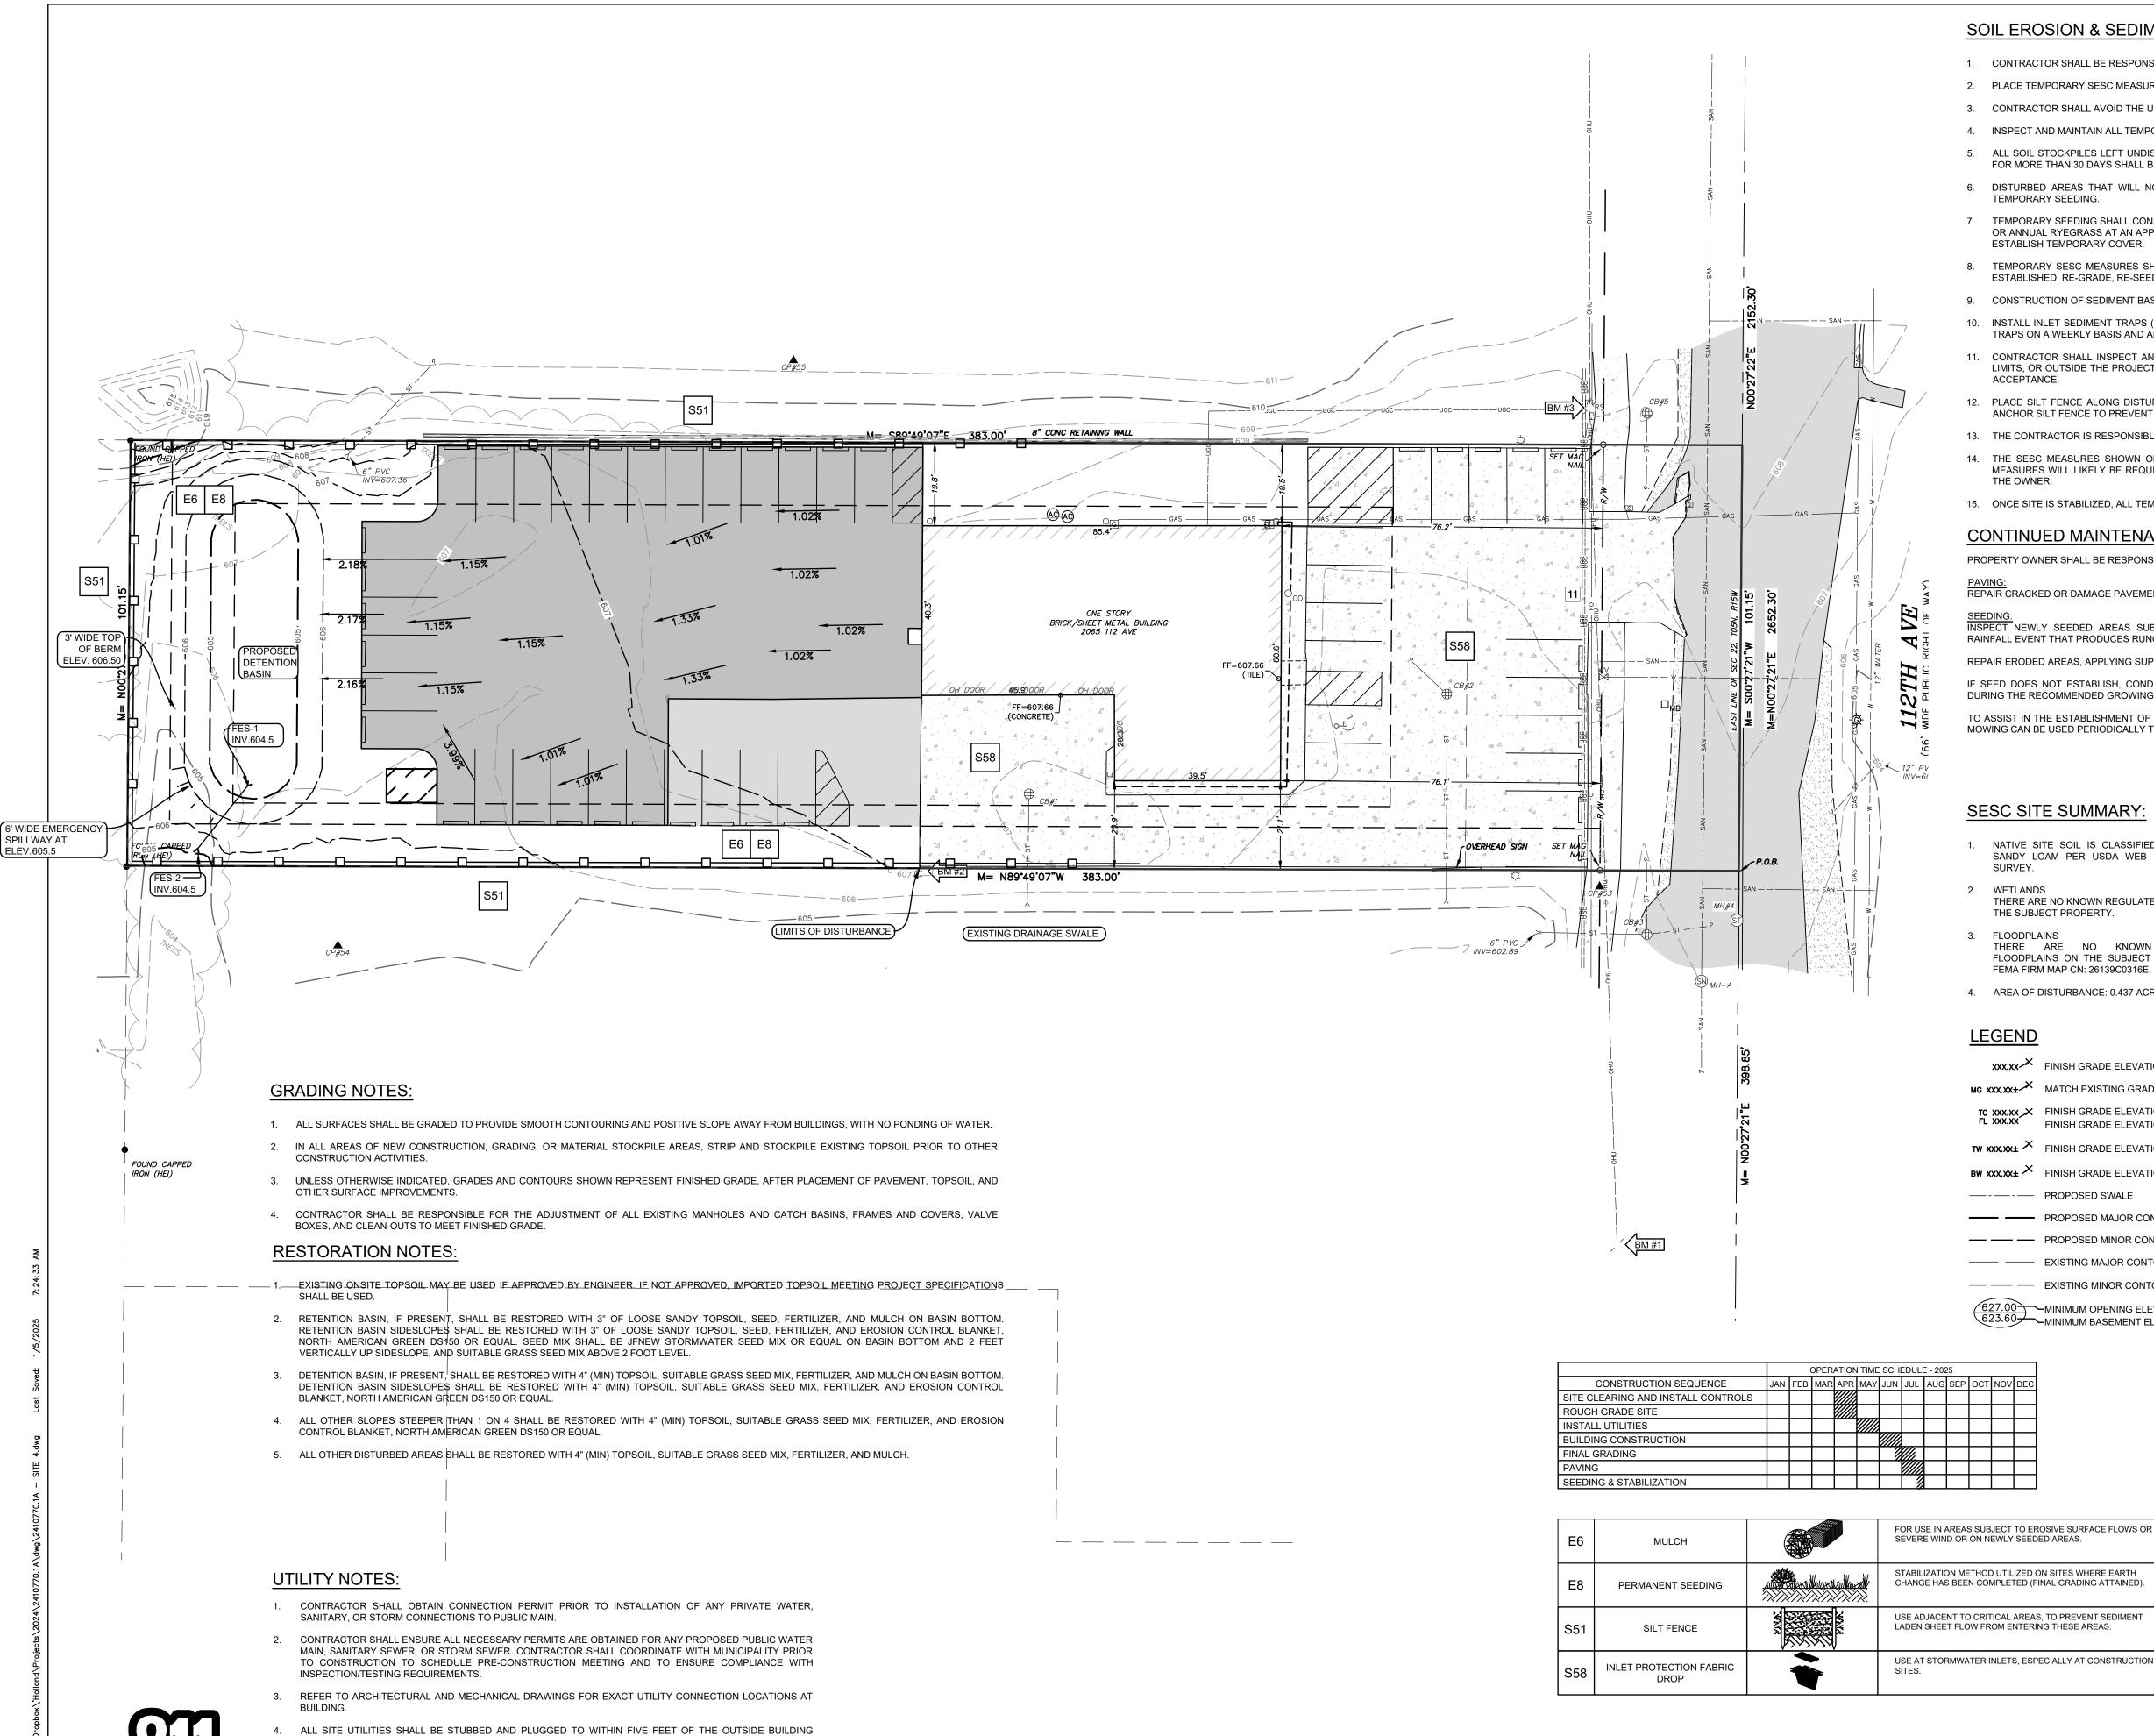

FOUNDATION WALL UNLESS OTHERWISE NOTED.

UTILITY STUBS AND CONDUITS INSTALLED.

PLACEMENT OF AGGREGATE BASE.

Know what's below.

Call before you dig

CONTRACTOR SHALL DOCUMENT, AND FURNISH TO OWNER AND ENGINEER, WITNESS DIMENSIONS FOR ALL

ALL UTILITY WORK SHALL BE COMPLETED, INCLUDING TRENCH BACKFILL AND COMPACTION, PRIOR TO

SOIL EROSION & SEDIMENTATION CONTROL (SESC) NOTES:

- 1. CONTRACTOR SHALL BE RESPONSIBLE FOR OBTAINING AND COMPLYING WITH THE SESC PERMIT.
- 2. PLACE TEMPORARY SESC MEASURES AS INDICATED ON DRAWING PRIOR TO EARTH MOVING AND GRADING ACTIVITIES.
- 3. CONTRACTOR SHALL AVOID THE UNNECESSARY DISTURBING OR REMOVING OF EXISTING VEGETATED TOPSOIL OR EARTH COVER.
- 4. INSPECT AND MAINTAIN ALL TEMPORARY SESC MEASURES AFTER STORM EVENTS AND AS NECESSARY TO ASSURE PROPER FUNCTION.
- 5. ALL SOIL STOCKPILES LEFT UNDISTURBED FOR MORE THAN 7 DAYS SHALL HAVE PERIMETER SILT FENCE. ALL SOIL STOCKPILES LEFT UNDISTURBED FOR MORE THAN 30 DAYS SHALL BE STABILIZED WITH TEMPORARY SEEDING.
- 6. DISTURBED AREAS THAT WILL NOT BE BROUGHT TO FINAL GRADE AND PERMANENTLY STABILIZED WITHIN 30 DAYS SHALL BE STABILIZED WITH TEMPORARY SEEDING.
- 7. TEMPORARY SEEDING SHALL CONSIST OF OATS AND/OR BARLEY AT AN APPLICATION RATE OF 2.0 LBS/1000 SFT MINIMUM APRIL 1 THROUGH AUGUST 31 OR ANNUAL RYEGRASS AT AN APPLICATION RATE OF NOT LESS THAN 2.0 LBS/1000 SFT AUGUST 1 THROUGH NOVEMBER 15. IRRIGATE IF NECESSARY TO
- 8. TEMPORARY SESC MEASURES SHALL REMAIN IN PLACE UNTIL ALL PERMANENT SESC MEASURES ARE INSTALLED, AND VEGETATION IS UNIFORMLY ESTABLISHED. RE-GRADE, RE-SEED AND PLACE ADDITIONAL TOPSOIL IN ERODED AREAS AS NECESSARY UNTIL FINAL LANDSCAPING IS INSTALLED.
- 9. CONSTRUCTION OF SEDIMENT BASINS AND DIVERSION DITCHES SHALL BE COMPLETED PRIOR TO SITE CLEARING AND GRADING.
- 10. INSTALL INLET SEDIMENT TRAPS ("SILT SACK" OR EQUAL) IN ALL PROPOSED CATCHBASINS AS INDICATED ON THIS DRAWING. CLEAN INLET SEDIMENT TRAPS ON A WEEKLY BASIS AND AFTER RAIN EVENTS AS REQUIRED.
- 11. CONTRACTOR SHALL INSPECT AND CLEAN OUT ALL EXISTING AND PROPOSED STORM SEWER CATCHBASINS AND MANHOLES WITHIN THE PROJECT LIMITS, OR OUTSIDE THE PROJECT LIMITS IF SUBJECT TO CONSTRUCTION SITE RUNOFF, AS NECESSARY DURING CONSTRUCTION AND PRIOR TO FINAL
- 12. PLACE SILT FENCE ALONG DISTURBED AREAS WHERE SURFACE WATER WILL FLOW INTO EXISTING SWALES, DITCHES AND ADJACENT PROPERTIES. ANCHOR SILT FENCE TO PREVENT UNCONTROLLED RELEASE OF SILT LADEN WATER.
- 13. THE CONTRACTOR IS RESPONSIBLE FOR THE DAILY SWEEPING OF TRACKED MATERIALS FROM ALL ROADWAYS.
- 14. THE SESC MEASURES SHOWN ON THIS PLAN ARE THE MINIMUM MEASURES REQUIRED. DUE TO SITE ACTIVITIES AND SCHEDULES, ADDITIONAL MEASURES WILL LIKELY BE REQUIRED TO MAINTAIN SITE ACCORDING TO APPLICABLE STATE AND FEDERAL GUIDELINES AT NO ADDITIONAL COST TO

LEGEND

STORM SEWER MANHOLE

FLARED END SECTION SANITARY SEWER MANHOLE

FIRE DEPARTMENT CONNECTION SPRINKLER CONTROL VALVE

E_{RS} G_{RS} T_{RS} E_{RS} C_{RS} T_{TR} C_{RS}

→ SB #1

_____ _ _ _ _ _ _ _ _ _ _ ____

_____ ST _____ ST ____

BENCHMARK

CLEANOUT WELL HEAD

FIRE HYDRANT

SPRINKLER HEAD VALVE (WATER & GAS)

GAS METER

UTILITY RISERS

UTILITY POLE

LIGHT POLE

GUY ANCHOR

TRANSFORMER

ELECTRIC METER

SOIL BORING

BOLLARD POST

GATE

FENCE LINE

TELEPHONE

FIBER OPTIC

GAS LINE

OVERHEAD UTILITIES

COMMUNICATIONS

EXISTING WATER LINE

PROPOSED WATER LINE

EXISTING STORM SEWER

UNDERGROUND ELECTRIC

HAND HOLE (ELECTRIC)

GROUND MOUNTED LIGHT

15. ONCE SITE IS STABILIZED, ALL TEMPORARY SESC MEASURES SHALL BE REMOVED.

CONTINUED MAINTENANCE OF PERMANENT SESC MEASURES

PROPERTY OWNER SHALL BE RESPONSIBLE TO MAINTAIN PERMANENT SESC MEASURES

REPAIR CRACKED OR DAMAGE PAVEMENT AS NEEDED.

NSPECT NEWLY SEEDED AREAS SUBSEQUENT TO ANTICIPATED GERMINATION DATE AND AFTER EACH SIGNIFICANT RAINFALL EVENT THAT PRODUCES RUNOFF UNTIL AREAS ARE STABILIZED.


REPAIR ERODED AREAS, APPLYING SUPPLEMENTAL SEED, MULCH AND WATER AS NEEDED.


IF SEED DOES NOT ESTABLISH, CONDUCT SOIL TESTS, AMEND SOILS AS NEEDED, AND REAPPLY SEED AND/OR MULCH DURING THE RECOMMENDED GROWING SEASON.

TO ASSIST IN THE ESTABLISHMENT OF NATIVE SPECIES REMOVE UNWANTED COMPETING VEGETATION IN THE FIRST YEAR. MOWING CAN BE USED PERIODICALLY TO DISCOURAGE WEEDS.

SESC SITE SUMMARY:


- 1. NATIVE SITE SOIL IS CLASSIFIED AS SANDY LOAM PER USDA WEB SOIL
- THERE ARE NO KNOWN REGULATED WETLANDS ON THE SUBJECT PROPERTY.
- FLOODPLAINS THERE ARE NO KNOWN REGULATORY FLOODPLAINS ON THE SUBJECT PROPERTY, PER
- 4. AREA OF DISTURBANCE: 0.437 ACRES
- xxx.xx FINISH GRADE ELEVATION
- MG XXX.XX± MATCH EXISTING GRADE ELEVATION
- TC XXX.XX X FINISH GRADE ELEVATION AT BACK OF CURB FINISH GRADE ELEVATION AT FLOW LINE
- TW XXX.XX± FINISH GRADE ELEVATION AT TOP OF WALL
- BW XXX.XX± FINISH GRADE ELEVATION AT BOTTOM OF WALL AT GROUND
- ----- PROPOSED MAJOR CONTOUR
- — PROPOSED MINOR CONTOUR
- ----- EXISTING MAJOR CONTOUR
- — EXISTING MINOR CONTOUR
- 627.00 MINIMUM OPENING ELEV. (M.O.E.)
 623.60 MINIMUM BASEMENT ELEV. (M.B.E.)

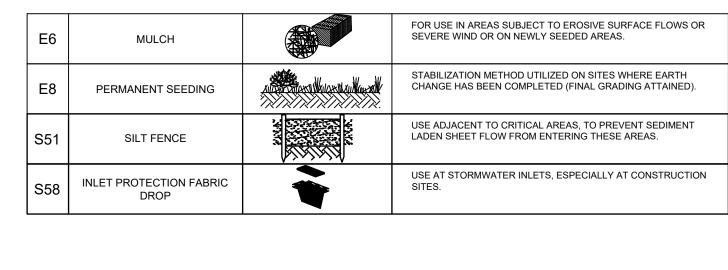

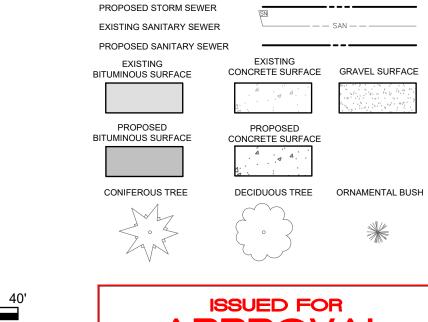

ISSUED FOR

PROPOSED

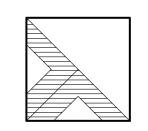

DRIESENGA 8 ASSOCIATES, INC

Engineering Surveying Testing

www.driesenga.com -

Holland, MI 616-396-0255

Grand Rapids, MI 616-249-3800

Kalamazoo, MI

269-544-1455

Lansing, MI

517-889-6210

Ypsilanti, MI

734-368-9483

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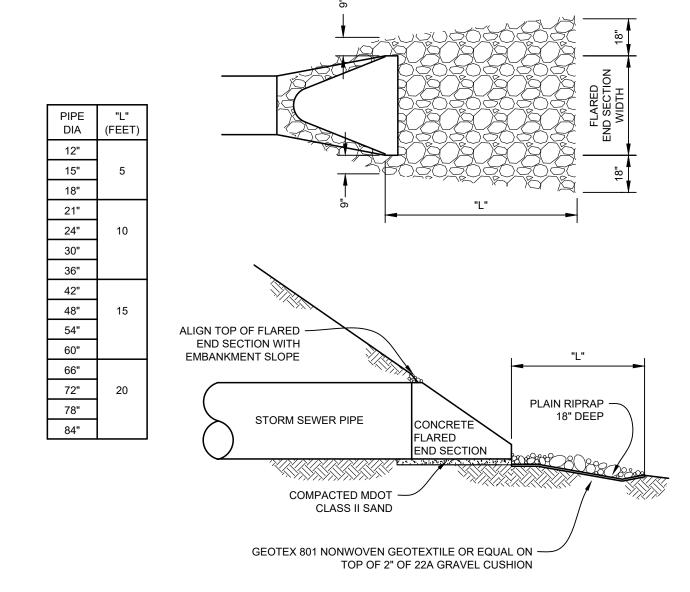
ISSUED FOR: OWNER REVIEW 12-22-2024 D: AA C: TLH TOWNSHIP REVIEW 01-07-2024 D: AA C: TLH

> Project Manager: JOHN TENPAS Proiect #

2410770.1A Sheet Title: STORM SEWER **GRADING AND** SOIL EROSION CONTROL PLAN

5 of 7

NO SCALE



FLARED END SECTION

1. ALL FACILITIES FOR THE DISABLED SHALL CONFORM WITH THE AMERICANS WITH DISABILITIES ACT AND ALL REVISIONS.

FINISHED GRADE

1 1/2" MDOT HMA 13A TOP COURSE 1 1/2" MDOT HMA 13A LEVELING COURSE

98% OF MAXIMUM DENSITY

MAXIMUM DENSITY

COMPACTED SUB GRADE

8" MDOT 21AA AGGREGATE BASE COMPACTED TO

*NOTE: HMA SHALL MEET CURRENT MDOT

STANDARDS & SPECIFICATIONS WITH 95% OF

12" MDOT CLASS II SAND COMPACTED TO 95% OF

50-BLOW MARSHALL DENSITY.


HMA PAVEMENT SECTION (STANDARD DUTY)

NO SCALE


2. THE CHARACTERS AND THE BACKGROUND OF SIGNS SHALL BE EGGSHELL, MATTE, OR OTHER NON-GLARE FINISH. CHARACTERS AND SYMBOLS SHALL CONTRAST WITH THEIR BACKGROUND. LIGHT CHARACTERS ON DARK BACKGROUND ARE PREFERRED.

3. CONTRAST LEVELS OF SYMBOLS TO BACKGROUND TO BE A MINIMUM OF 70%.

4. CONTRACTOR SHALL VERIFY THAT THE SYMBOL SHOWN MEETS THE CURRENT STANDARDS FOR THE INTERNATIONAL SYMBOL OF ACCESSIBILITY AND SHALL BE IN COMPLIANCE WITH ICC/ANSI FIGURE 703.7.2.1.

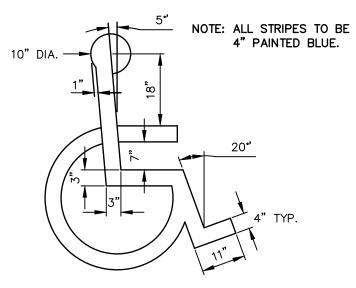

BARRIER FREE SYMBOL

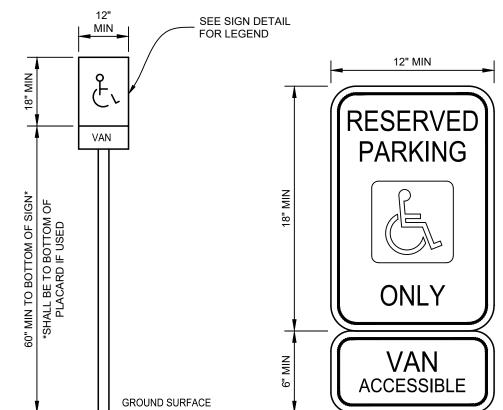

BARRIER FREE SIGN

NO SCALE

VAN ACCESSIBLE SPACES SHALL BE IDENTIFIED WITH "VAN ACCESSIBLE" PLACARD


GEOTEXTILE FILTER FABRIC 6" ANCHOR TRENCH SUPPORT FENCE FRONT ELEVATION (IF REQUIRED) - 2"X2" HARDWOOD STAKE AT 6' ON CENTER (MAX.). - ECOLOFENCE MDOT BY PRICE AND COMPANY, INC. OR APPROVED EQUAL. GEOTEXTILE FABRIC SHALL BE USED TO MEET MICHIGAN SOIL EROSION & SEDIMENTATION CONTROL METHODS:21, 22, 33, 37-39, 53. - 6"x6" ANCHOR TRENCH OVER SIDE ELEVATION END OF SECTION JOINT PLAN

SPACING 6' MAX.

- HARDWOOD STAKES DRIVEN

INTO GROUND 1' MIN.


SILT FENCE

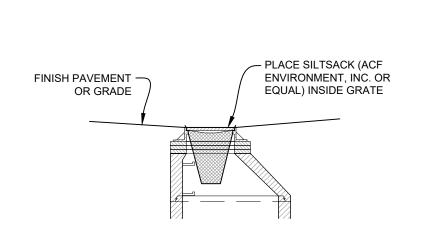

SILT SACK

NO SCALE

3' OVERFLOW WEIR ─ TOP OF BERM ELEV. 607.0 TOP OF WEIR ELEV. 606.00 **EROSION CONTROL** BLANKET (NAG SC250 OR -APPROVED EQUAL) ELEVATION VIEW 6' MIN.

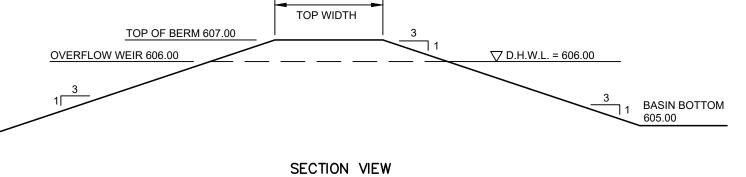

WEST DETENTION BASIN - OVERFLOW WEIR NO SCALE

Know what's below. Call before you dig.

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Engineering Surveying Testing www.driesenga.com -

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Kalamazoo, MI

269-544-1455 Lansing, MI 517-889-6210 Ypsilanti, MI 734-368-9483

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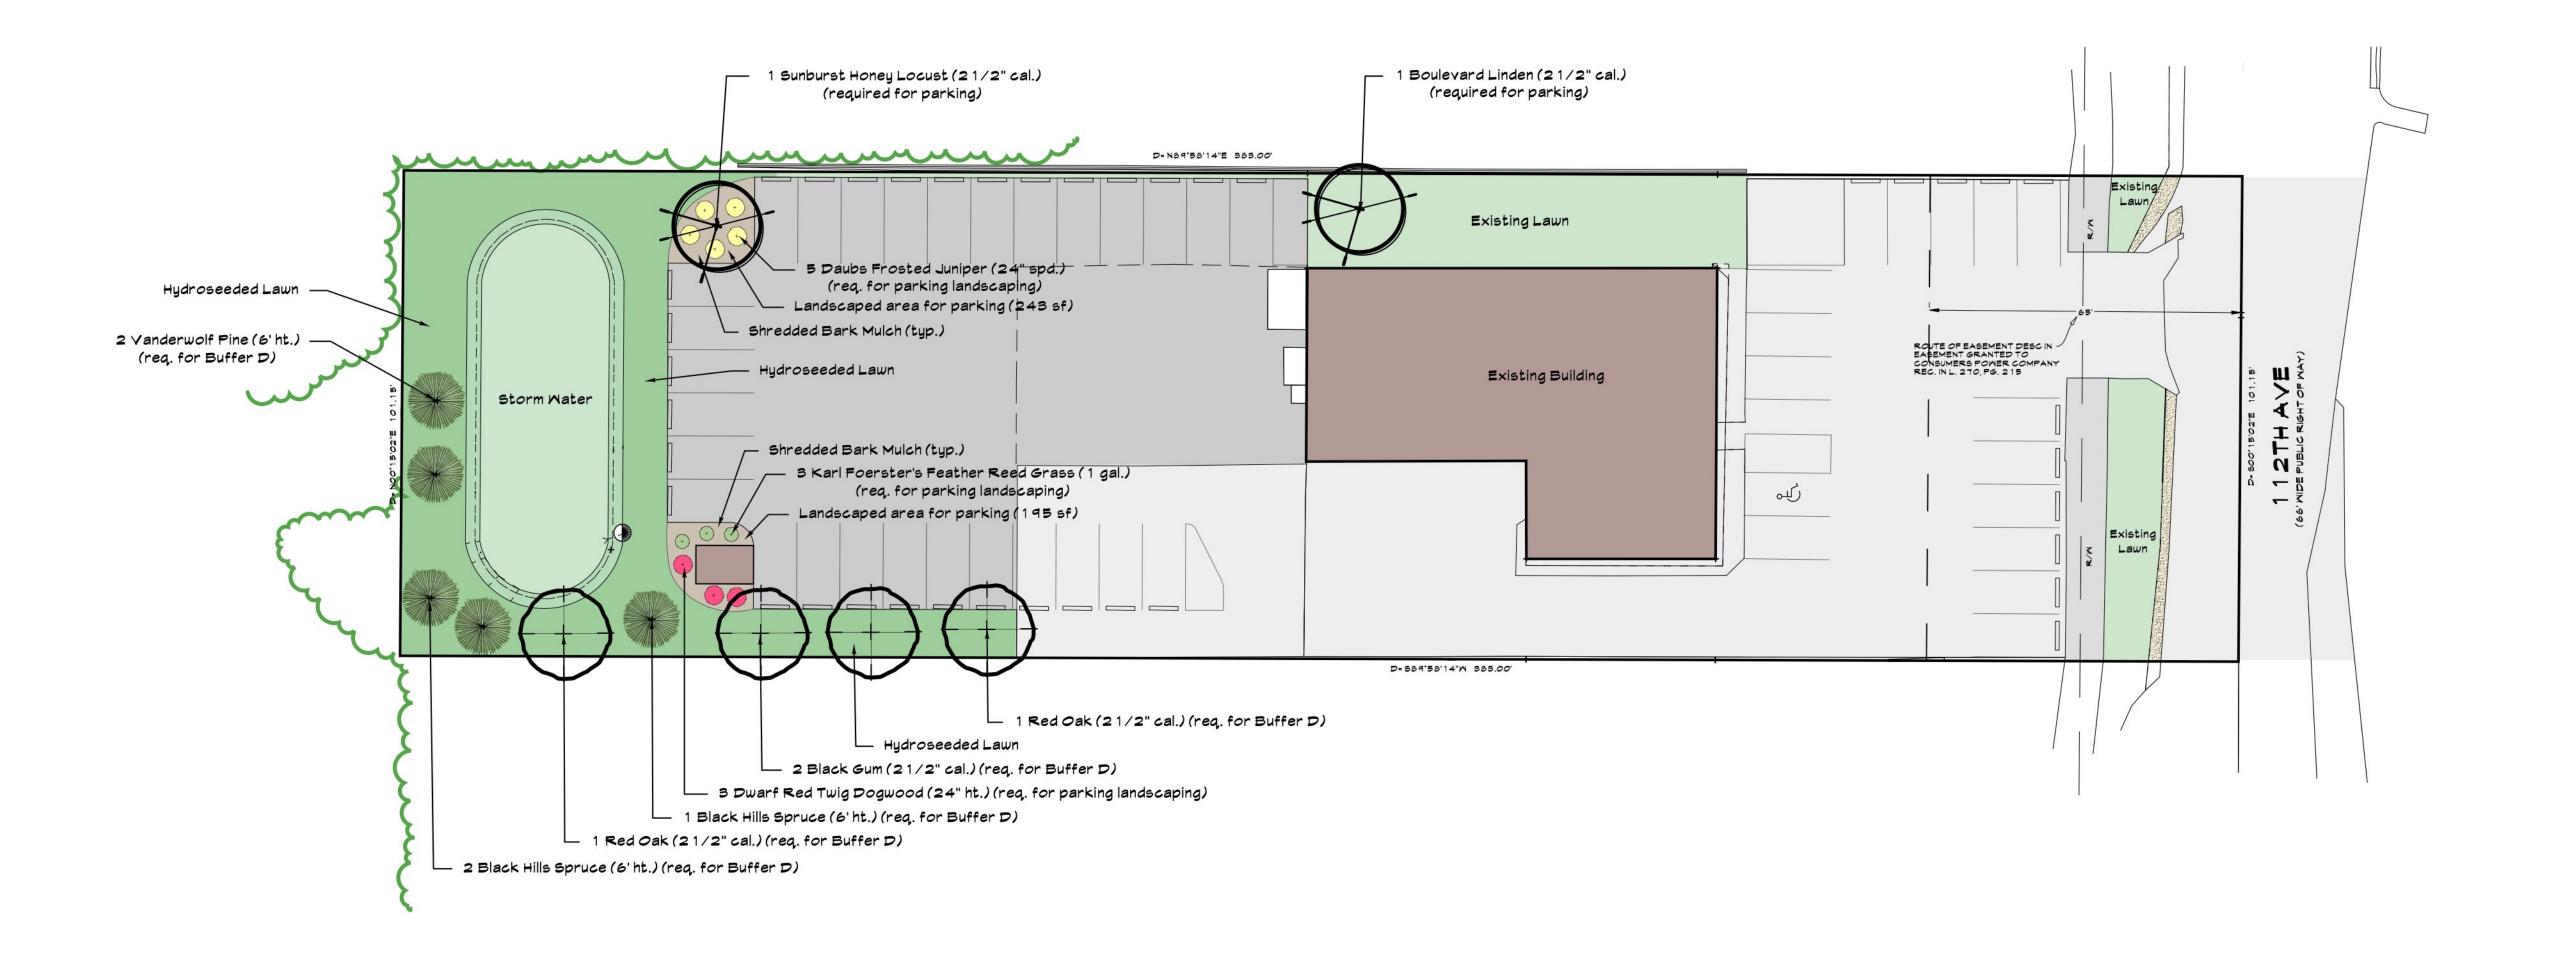
ISSUED FOR: OWNER REVIEW 12-22-2024 D: AA C: TLH TOWNSHIP REVIEW 2 01-07-2024 D: AA C: TLH


Project Manager: JOHN TENPAS Project # 2410770.1A


Sheet Title:

DETAILS


C-501 6 of 7




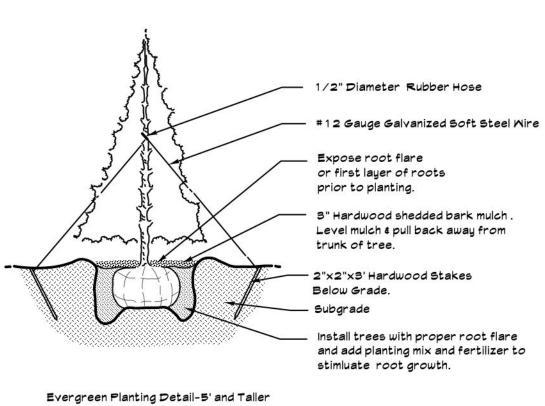

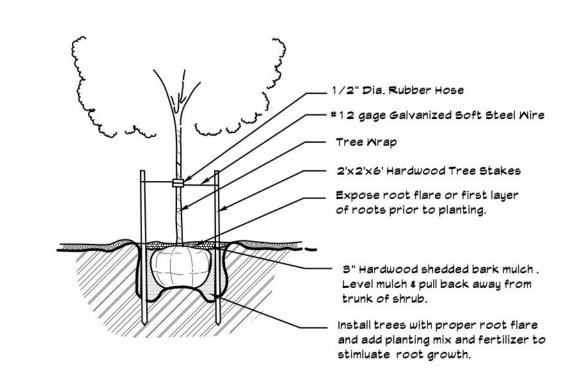

Deciduous Trees 3" Caliper and Smaller

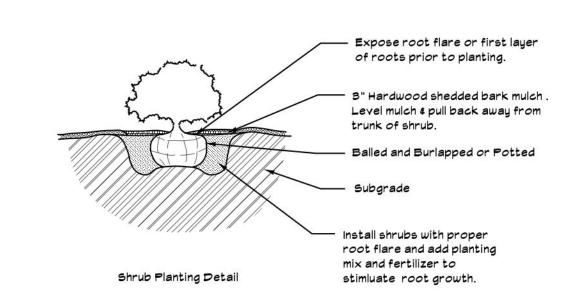

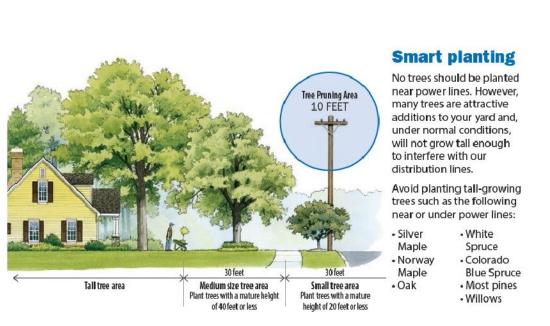

Plant List

Quantity	Common Name	Latin Name	Planted Size
1	Boulevard American Linden	Tilia americana 'Boulevard'	21/2" cal.
1	Sunburst Honey Locust	Gleditsia triacanthos 'Suncole'	21/2" cal.
2	Red Oak	Quercus rubra	21/2" cal.
2	Black Gum	Nyssa sylvatica	21/2" cal.
2	Vanderwolf Pine	Pinus flexilis 'Vanderwolf'	6' ht.
3	Black Hills Spruce	Picea glauca var. densata	6' ht.
з	Dwarf Red Twig Dogwood	Cornus stolonifera 'Artic Fire'	24" ht.
5	Doubs Frosted Juniper	Juniperus chinensus 'Doubs Frosted'	24" spd.
3	Karl Foerster's Feather Reed Grass	Calamagrostis acutiflora 'Karl Foerster'	1 gal.

Article 1 1 Landscaping & Screening

Front Yard Landscaping:

1 Canopy Tree and 3 Shrubs per 40 ln. ft. of front yard is required. along property line.

James Street Front Yard: 101.00' ln. ft./40 = 2.5 Required: 2.5 Canopy Trees and 7.5 Shrubs Provided: Due to a conflict with the bike path and consumers easement landscaping cannot be added.

Parking Lot Landscaping:

1 Canopy Tree and 100 sq. ft. of landscaped area shall be provided per 12 parking spaces.


Required based on 28 proposed parking spaces in rear: 2.3 Canopy Trees and 235.00 sf. ft. of landscaped area. Provided: 2 Canopy Trees \$ 438 sf. ft. landscaped area.

Buffer Type D:

1 Canopy Tree or Everegreen Tree per each 60 ln. ft.

South Property Line: 383.00 ln. ft./60 = 6.38 Required: 6.38 Canopy or Ever. Trees Provided: 4 Canopy & 3 Evergreen Trees

West Property Line: 101.00 ln. ft./60 = 1.666 Required: 1.66 Canopy or Ever. Trees Provided: 2 Evergreen Trees

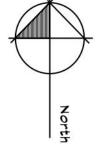




Notes:

- All landscaping shall be installed by a qualified Landscape Contractor.
 Plant sizes specified on the landscape plan shall be the size planted. Plants smaller then specified will be rejected. Substitutions of any kind must be approved
- by the Landscape Architect. 2. All plantings shall be mulched with 3" shredded premium hardwood bark mulch.
- Trees in lawn areas shall receive a 6' diameter bark ring 3" deep.. 3. The landscape contractor shall remove any twine that is wrapped around the trunk of a tree or shrub as well as the top third of any burlap. Remove excess soil on the top of the root ball to expose the root flare or first layer of roots prior to planting.
- Use a wire cutter to make 3-5 cuts in the wire basket to allow roots to grow through. 4. When planting trees in the lawn area or on the berm the existing soil within a 10 foot diameter shall be loosened by tilling or similar and amended with composted manure or peat at a depth of 6-12".

 The which because the diameter shall within a 10 foot diameter shall be loosened by tilling or similar and amended with composted manure or peat at a depth of 6-12".
- 5. Planting areas shall be edged with a mechanical bed edger to define a border for the shedded bark mulch.
- 6. Parking Islands shall be back filled with at least 24" of topsoil. Amend the topsoil with composted manure and mix into the topsoil at a depth of 6-12". Any aggregate or stone from the construction of the parking lot shall be removed prior to backfill. 7. Lawn areas shall recieve at least 4" of topsoil and hydroseeded. Check with specifications for topsoil availability or contact project manager. Topsoil for lawns shall be appropriate for growing and sustaining a healthy lawn. All lawns shall be hydroseeded with a seed blend
- consisting of 30% Kentucky Bluegrass, 20% Perennial Ryegrass, 10% Hard Fescue, 20% Creeping Red Fescue and 20% Chewings Fescue. 8. All lawn and shrub bed areas shall be watered by an automatic irrigation system.
- The irrigation system shall be designed and installed by the Landscape Contractor. Shrub areas shall be irrigated with drip irrigation. 9. Maintenance of the landscape shall be provided for by the owner and include fertilizing of lawn and plant material, yearly pruning, top dressing of mulch areas every other year
- and provide 1" of water per week during the growing season. 10. Plant materials shall be chosen and installed in accordance with standards recommended by the County Cooperative Extension Service or American Nursery Association.

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Landscape Plan Drawn By: Joyce E. Weise PLA, ASLA

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SOCIETY OF LANDSCAPE ARCHITECTS

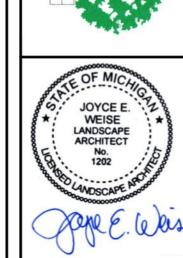PROJECT NUMBER: 2410770.1A

DRAWN BY: Joyce E. Weise PLA, ASLA

DRAWING DATE:

010325 ISSUED FOR:

01/07/25 Township Review

SCALE

SHEET NUMBER L-100