

# SITE PLAN CHECKLIST

353 North 120th Avenue · Holland, MI 49424 · Phone: 616.395.0151 · Fax: 616.396.2537

All site plans submitted MUST contain all the following information unless certain information is waived by the Zoning Administrator: (Please check each item that is shown on the plan or note why it is not) Site plan, drawn to scale, based on an accurate certified land survey. A. В. Site plan content: B1. Indication of existing Zoning District requirements. ☐ Zoning District □Front Yard Setback Complies (Not changed) ☐ Side Yard Setback Complies (Not changed) ☐ Parcel Size Complies ☐ Parcel Width Complies □Rear Yard Setback Complies (Not changed) B2. Adjacent Zoning Districts, including Structures within one hundred (100) feet of the site's Lot lines. B3. Location of existing water, sewer, and storm water utilities, including ditches and similar water courses. Existing topographical features including vegetation cover, trees in excess of six (6) inch caliper, and B4. contour intervals no greater than five (5) feet. B5. Location of R.O.W. lines, Lot lines, and applicable Setback lines. Location of existing streets, drives, and parking lots, including loading space(s) and arrangement and B6. number of standard parking spaces and accessible parking spaces. B7. Location of existing improvements, including the size and type of present Buildings or Structures, such as fencing, lighting, and signs to be retained or removed. Proposed topographical features including limits of removal for vegetation cover and contour intervals B8. no greater than five (5) feet. Location of proposed water, sewer, and storm water utilities, including ditches or similar water courses. B9. (Not changed) B10. Location of proposed streets, drives, and parking lots, including loading space(s) and arrangement and number of standard parking spaces and accessible parking spaces. B11. Location of all proposed Buildings or Structures, such as trash enclosures, fencing, light poles, and centralized mail delivery locations for residential communities (i.e., Neighborhood Delivery Centers or Cluster Box Units). B12. Proposed landscaping, including specific ground cover(s), shrubs, and trees with an accurate description of species type and minimum size(s) to be installed. (Not changed) B13. The date, north arrow, and scale. The scale shall not be less than 1" = 50' if the subject property is less than three (3) acres and 1'' = 100' if three (3) acres or more. B14. The name and address and phone number of the professional individual, if any, responsible for the preparation of the site plan.

| C. | Buildi | ng information:  |
|----|--------|--|
|    | C1.    | Preliminary architectural sketches and/or a general statement as to the type of construction and materials to be used in the proposed Buildings or Structures. (Architectural - prop Canopy) |
|    | C2.    | Height and area of Buildings and Structures, including lot coverage by buildings. (not changed)  |
| D. | Supple | emental information:   |
|    | D1.    | Project Narrative. (attached)  |
|    | D2.    | The period of time within which the project will be completed.   |
|    | D3.    | Proposed phasing of the project, if any. (one phase)   |
|    | D4.    | Delineation of the one hundred (100) year flood plain and any proposed uses therein.   |
|    | D5.    | Current proof of ownership of the land to be utilized or evidence of a contractual ability to acquire such land, such as an option or purchase contract.                                     |
|    | D6.    | Additional information which the body or official reviewing and approving the site plan may request - which is reasonably necessary to evaluate the site plan.                               |

# Planning Commission General Document Submittal Requirements:

- 1. Failure to include any of the above information shall result in the rejection of the proposed site plan.
- 2. All information required on the application form shall be completed, including signature.
- 3. One original signature copy of the application must be submitted. The balance of the copies required may be photocopies.
- 4. All required documents/information must be submitted at the same time.
- 5. Rolled documents shall not be accepted. All documents must be folded to a size no larger than 9"x12".
- 6. If submittal contains multiple documents, the documents must be collated into "packets". Each packet shall be secured by clips, or rubber bands if necessary.
- 7. Two (2) sets of plans shall bear the original seal and signature of the architect or engineer who prepared them; the balance required may be copies.

# COMMUNITY ACTION HOUSE – RILEY STREET PROJECT NARRATIVE

650 Riley Street, Holland, MI 49424
Parcel # 70-16-32-351-003
July 15, 2025

# **Project Overview**

This project includes targeted site improvements at the Community Action House property located at 650 Riley Street in Holland Charter Township. The site is approximately 3.04 acres in size and contains an existing one-story commercial building totaling 23,759 square feet. The property is zoned C-1 – Neighborhood Commercial. The proposed improvements are intended to support site functionality by enhancing waste handling and increasing parking capacity to comply with local zoning requirements.

# Scope of Work

A canopy is being added for customers to drop off donations. Improvements are being made to the area behind the building to allow for deliveries and rubbish pickup. A trash compactor and a dumpster with enclosure are proposed. Minor storm sewer and grading modifications. A new stormwater basin is planned for the south side of the site. Addition of parking at the rear of the building (for employees) to meet the ordinance requirements. Site restoration including seeding and stabilization.

### **Zoning Compliance**

The proposed improvements meet all applicable C-1 zoning district requirements:

- Lot area: 3.04 acres (required: 12,500 SF)
- Lot coverage: 17.94% (maximum allowed: 25%)
- Setbacks: No changes proposed
- The proposed site use and improvements are compatible with surrounding land uses and zoning.

# **Parking**

- Required: 95 spaces (based on 1 per 250 SF for 23,759 SF building)
- Provided: 79 existing + 16 new spaces (at rear) = 95 total spaces, including 4 ADA-compliant spaces.

# Stormwater Management

Stormwater will be collected via existing catch basins and conveyed to a proposed basin located at the south side of the property or utilize the existing stormwater sewer The proposed basin will meet the Ottawa County Water Resources Commission (OCWRC) requirements for water quality volume and peak rate control. We understand that we will need review and written approval from OCWRC.

### Soil Erosion & Sedimentation Control (SESC)

Temporary SESC measures, including silt fence and inlet protection, will be installed prior to the start of grading activities. All disturbed areas will be stabilized with topsoil, seed, and mulch in accordance with county SESC guidelines. A permit will be obtained from Ottawa County prior to land disturbance.

### Utilities

The building is currently served by existing municipal water and sanitary sewer connections. No new utility extensions are proposed.

# Wetlands and Floodplains

No regulated wetlands or floodplains are present on the site (FEMA FIRM Panel 26139C0285E).

### Landscaping

No changes to the landscaping are proposed. We will be restoring any disturbed areas with seeding and sod.

### Lighting


No proposed changes to site lighting.

# **Signage**

No proposed changes to signage.

# Potential Impacts

No adverse impacts to traffic circulation, public services, or neighboring properties are anticipated. No changes to the driveway approaches are planned. Site access from Riley Street and 144th Avenue remains unchanged.

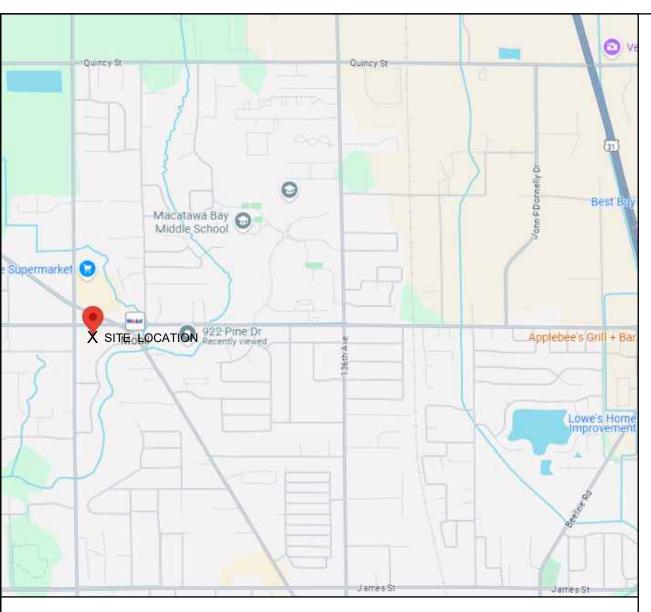

# LOCATION MAP - NO SCALE



**ZONING MAP - NO SCALE** 



**AERIAL - NO SCALE** 



# LAKEWOOD ARCHITECTURE COMMUNITY ACTION HOUSE

650 RILEY ST SECTION 18, T05N, R15W HOLLAND CHARTER TOWNSHIP, MICHIGAN 49424

# SHEET INDEX

| $\sim 004$ | TITLE CLIEET |
|------------|--------------|
| G-001      | TITLE SHEET  |

V-101 EXISTING TOPOGRAPHIC PLAN

CD-101 CIVIL DEMOLITION PLAN

C-101 SITE PLAN

GRADING AND SOIL EROSION CONTROL PLAN C-102

EX-VT EXHIBIT - VEHICLE TRACKING SITE ADDRESS

COMMUNITY ACTION HOUSE 650 RILEY ST HOLLAND, MI 49424

OWNER

650 RILEY ST HOLLAND, MI 49424

(616) 392-2368 DOUG BAZUIN dbazuin@communityactionhouse.org

**ARCHITECT** 

HOLLAND, MI 49424

GENERAL CONTRACTOR

**CIVIL ENGINEER** 

(616) 396-0255 JOHN TENPAS, P.E.

DRIESENGA & ASSOCIATES, INC

Engineering Surveying Testing

Holland, MI 616-396-0255

Grand Rapids, MI 616-249-3800

Kalamazoo, MI 269-544-1455

517-889-6210 Ypsilanti, MI

734-368-9483


ISSUED FOR: OWNER REVIEW 06-11-2025 D: A.A C: JM OWNER REVIEW 06-26-2025 D: A.A C: JM


07-15-2025 D: A.A C: JM7

JOHN TENPAS

TITLE SHEET

G-001 1 of 6

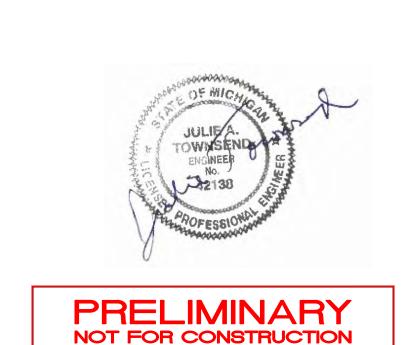

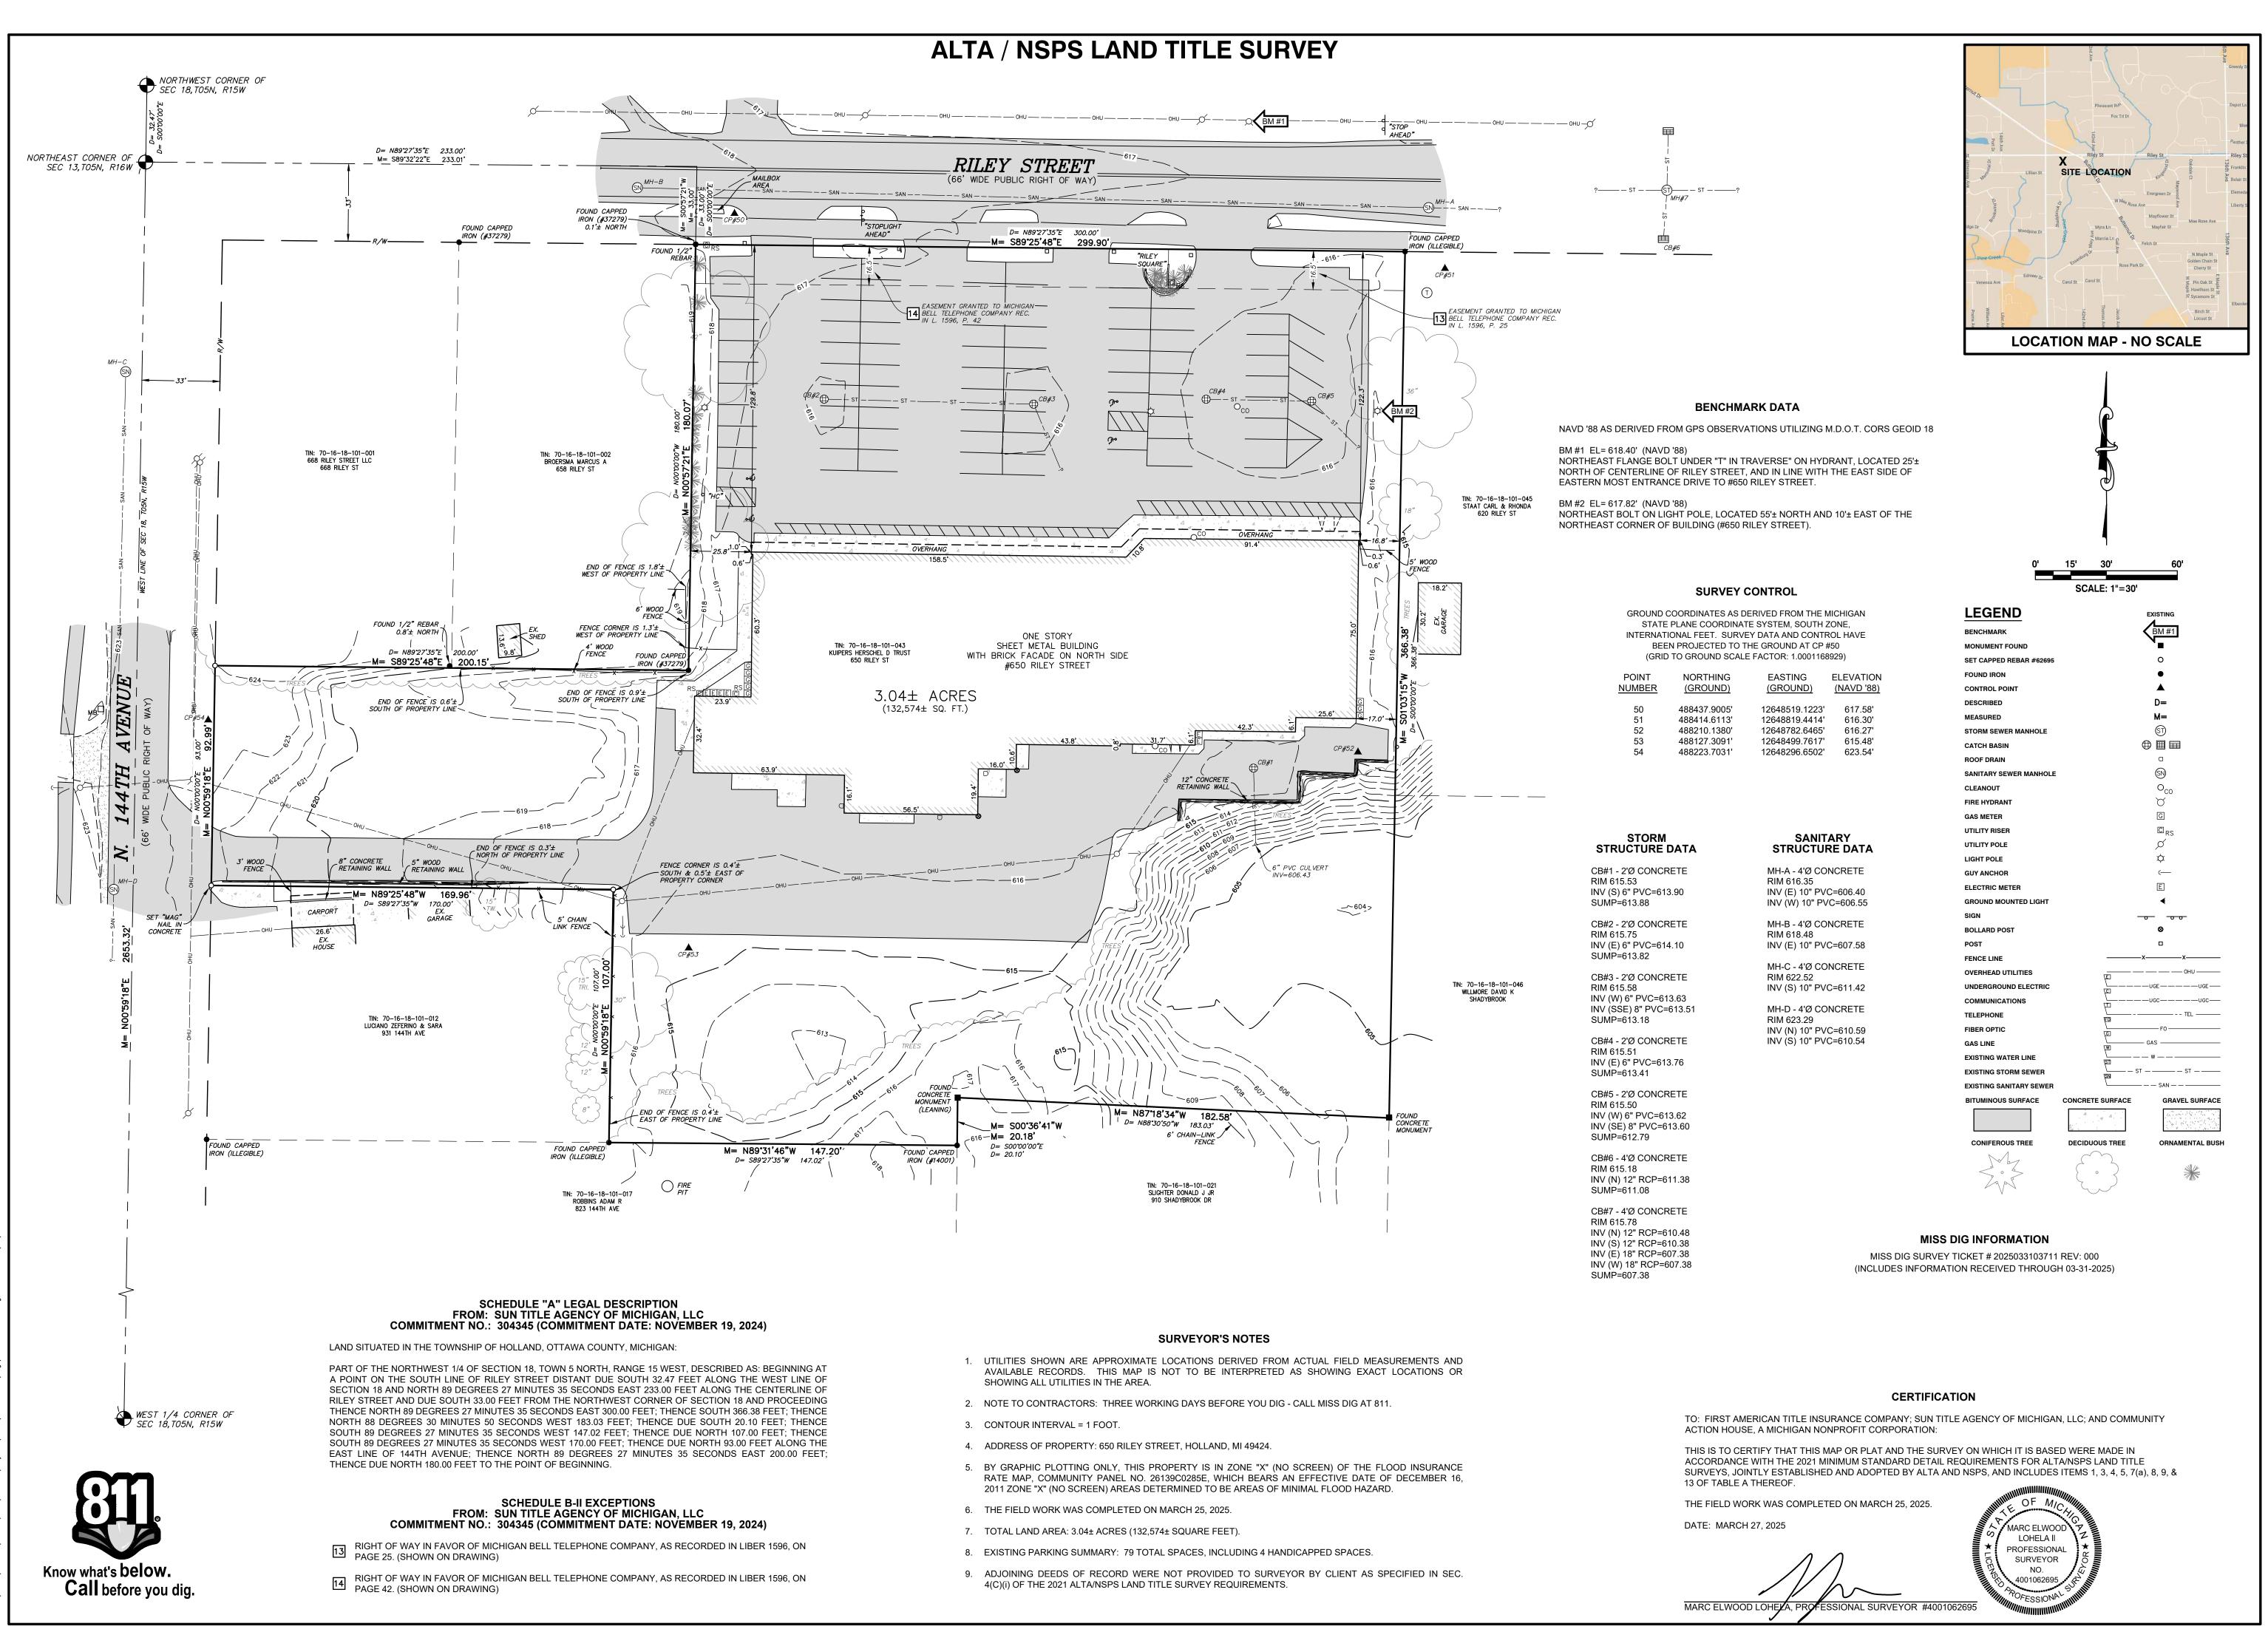

**DRIESENGA** ASSOCIATES, INC

> Engineering Surveying Testina

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www.driesenga.com

Lansing, MI 517-977-1019 Ypsilanti, MI

734-368-9483

HOUS NOIT

650 RILEY S , TOSN, I

REVISIONS


1"=30'

03-27-2025

2510195.5A

**ALTA / NSPS** LAND TITLE SURVEY

V-101 1 of 1

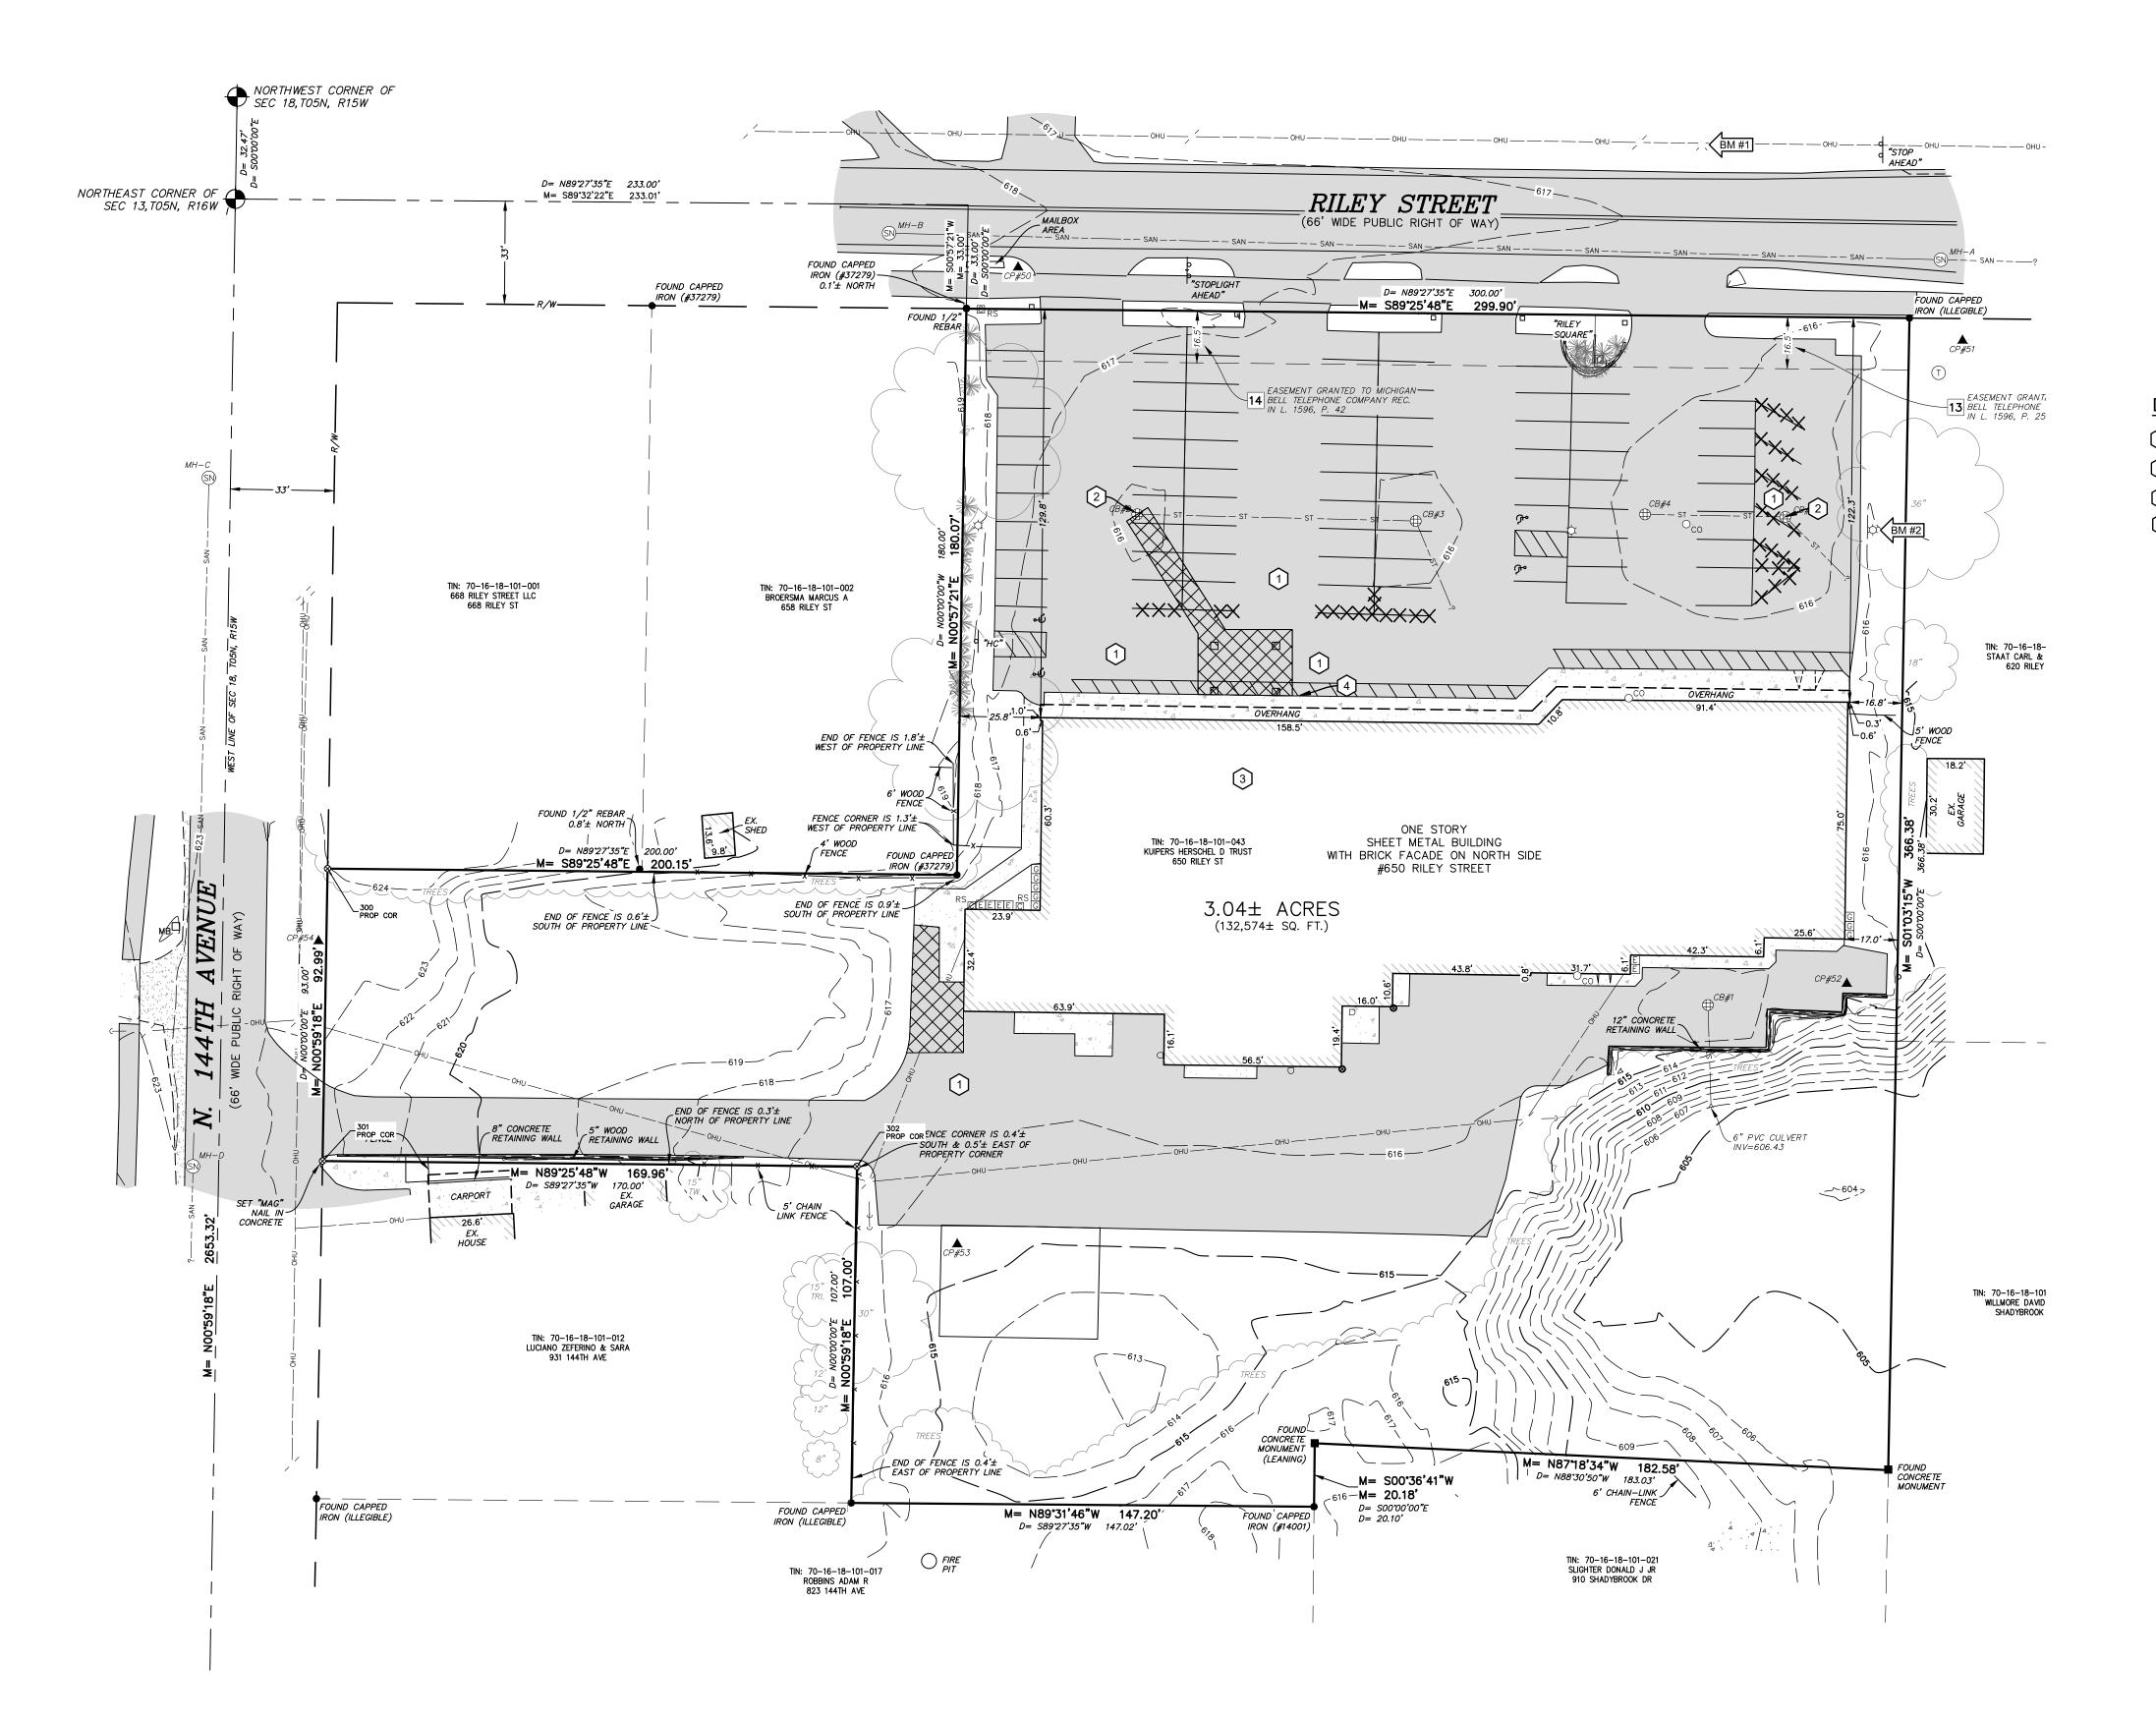

Know what's below.

Call before you dig.

# **CLEARING & DEMOLITION NOTES:**

- 1. REMOVE ALL STRUCTURES, SUPPORT COLUMNS, FOOTINGS, ASPHALT PAVING, CONCRETE CURB, SIDEWALKS, CONCRETE PADS, TREES, STUMPS, HEDGES, UTILITIES, AND OTHER EXISTING SITE FEATURES WITHIN LIMITS OF DEMOLITION. ALL DEMOLITION MATERIALS SHALL BE REMOVED FROM THE SITE UNLESS OTHERWISE INDICATED AND DISPOSED OF IN A MANNER ACCEPTABLE TO AUTHORITIES HAVING JURISDICTION.
- 2. MOVEMENT OF CLEARED WOOD IS RESTRICTED; REFER TO EMERALD ASH BORER QUARANTINE INFORMATION AT WWW.MICHIGAN.GOV. CONTRACTOR IS RESPONSIBLE FOR COMPLYING WITH ALL QUARANTINE REQUIREMENTS.
- 3. CONSTRUCTION FENCE SHALL BE PLACED AT THE DRIP LINE OF ALL TREES WITHIN THE PROJECT AREA THAT ARE INDICATED TO BE PROTECTED. DO NOT OPERATE EQUIPMENT OR STORE MATERIALS OR VEHICLES WITHIN THIS AREA.
- 4. UNLESS INDICATED TO BE ABANDONED IN PLACE, ALL UTILITIES TO BE DEMOLISHED SHALL BE REMOVED IN THEIR ENTIRETY. UTILITIES TO BE ABANDONED IN PLACE SHALL BE FILLED WITH FLOWABLE FILL AND SECURELY CAPPED.
- 5. EXCEPT FOR THOSE UTILITIES INDICATED TO BE ABANDONED OR REMOVED, RECONNECT ALL UTILITIES ENCOUNTERED DURING CONSTRUCTION.
- 6. ALL CATCHBASIN AND MANHOLE FRAMES AND COVERS SPECIFIED TO BE REMOVED SHALL BE SALVAGED, CLEANED AND INSPECTED, AND MAY BE REUSED WITH APPROVAL BY ENGINEER.
- 7. ANY REMOVAL OF PAVEMENT, SIDEWALK, CURB AND GUTTER OR OTHER HARD SURFACES SHALL BE TO A SAWCUT LINE AT THE NEXT JOINT BEYOND REMOVAL LIMITS SHOWN.
- 8. DEMOLITION WORK IS INDICATED BASED ON BEST AVAILABLE INFORMATION. CONTRACTOR SHALL INSPECT THE SITE AND BE FAMILIAR WITH THE EXTENT OF DEMOLITION WORK REQUIRED.

# **DEMOLITION KEY:**

PROTECT EX. ASPHALT PAVEMENT TO REMAIN
PROTECT EX. UTILITY TO REMAIN, TYP.

3 PROTECT EX. BUILDING TO REMAIN, TYP.
4 PROTECT EX. CURB TO REMAIN, TYP.

REMOVAL LEGEND:

ASPHALT REMOVAL

BUILDING REMOVAL

GRAVEL REMOVAL

TREE CLEARING

TREE/SHRUB REMOVAL

<u>LEGEND</u>

STORM SEWER MANHOLE

BENCHMARK

XXXXX FENCE/WALL/UTILITY/MISC. REMOVAL

| STORM SEWER MANHOLE        | (51)   | (SI)           |
|----------------------------|--|----------------|
| CATCH BASIN                |  |                |
| FLARED END SECTION         | <  | <              |
| SANITARY SEWER MANHOLE     | SN   | $\bigcirc$ N   |
| CLEANOUT                   | $\circ_{co}$   | O              |
| WELL HEAD                  | W  |                |
| FIRE HYDRANT               | Q  | $\blacksquare$ |
| FIRE DEPARTMENT CONNECTION |  | ♡              |
| SPRINKLER CONTROL VALVE    | X<br>SCV   |                |
| SPRINKLER HEAD             | SCV<br>*   | C) / M/\       |
| VALVE (WATER & GAS)        | ₩V GV  | GV W           |
| GAS METER                  | G  |                |
| UTILITY RISERS             | E <sub>RS</sub> G <sub>RS</sub> II <sub>RS</sub> E <sub>RS</sub> O <sub>RS</sub> [ |                |
| UTILITY POLE               |  | Ö              |
| LIGHT POLE                 | \$   | φ              |
| GUY ANCHOR                 | (—   | ·              |
| TRANSFORMER                | $\square_{TR}$   |                |
| HAND HOLE (ELECTRIC)       | H  |                |
| ELECTRIC METER             | E  |                |
| GROUND MOUNTED LIGHT       | €  | •              |
| SIGN                       | <del>-0</del> - <del>00</del>  | -              |
| SOIL BORING                | <b>♦</b> SB <b>#</b> 1   | <b></b>        |
| BOLLARD POST               | ⊗  | 8              |
| POST                       |  |                |
| GATE                       |  |                |
| FENCE LINE                 | xx   | -              |
| OVERHEAD UTILITIES         | OHU  | -              |
| UNDERGROUND ELECTRIC       |  | -              |
| COMMUNICATIONS             | uccugc   | -              |
| TELEPHONE                  |  | -              |
| FIBER OPTIC                | F0———  | -              |
| GAS LINE                   | GAS —  | -              |
| EXISTING WATER LINE        |  | -              |
| PROPOSED WATER LINE        | SI   | -              |
| EXISTING STORM SEWER       | st st  | -              |
| PROPOSED STORM SEWER       | SN   | •              |
| EXISTING SANITARY SEWER    | SAN  | -              |
| PROPOSED SANITARY SEWER    |  | •              |
| EXISTING CONC              | EXISTING<br>CRETE SURFACE GRAVEL SURFACI   | F              |
| BITUMINOUS SURFACE CONC    |  | -<br>1         |
|                            |  | l              |



PRELIMINARY NOT FOR CONSTRUCTION


PROPOSED

4 4

DECIDUOUS TREE ORNAMENTAL BUSH

**BITUMINOUS SURFACE** 

CONIFEROUS TREE

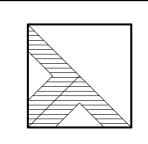

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OMMUNITY ACTION HOUSE
650 RILEY STREET
05N, R15W, HOLLAND CHARTER TWP., OTTAWA C
-FORKEWOOD ARCHITECTURE
253 JAMES STREET, HOLLAND, MI 49424

|   | ISSUED FOR:                                   |
|---|---|
| 1 | OWNER REVIEW<br>06-11-2025 D: A.A C: JMT      |
| 2 | OWNER REVIEW<br>06-26-2025 D: A.A C: JMT      |
| 2 | ISSUED FOR REVIEW<br>07-15-2025 D: A.A C: JMT |
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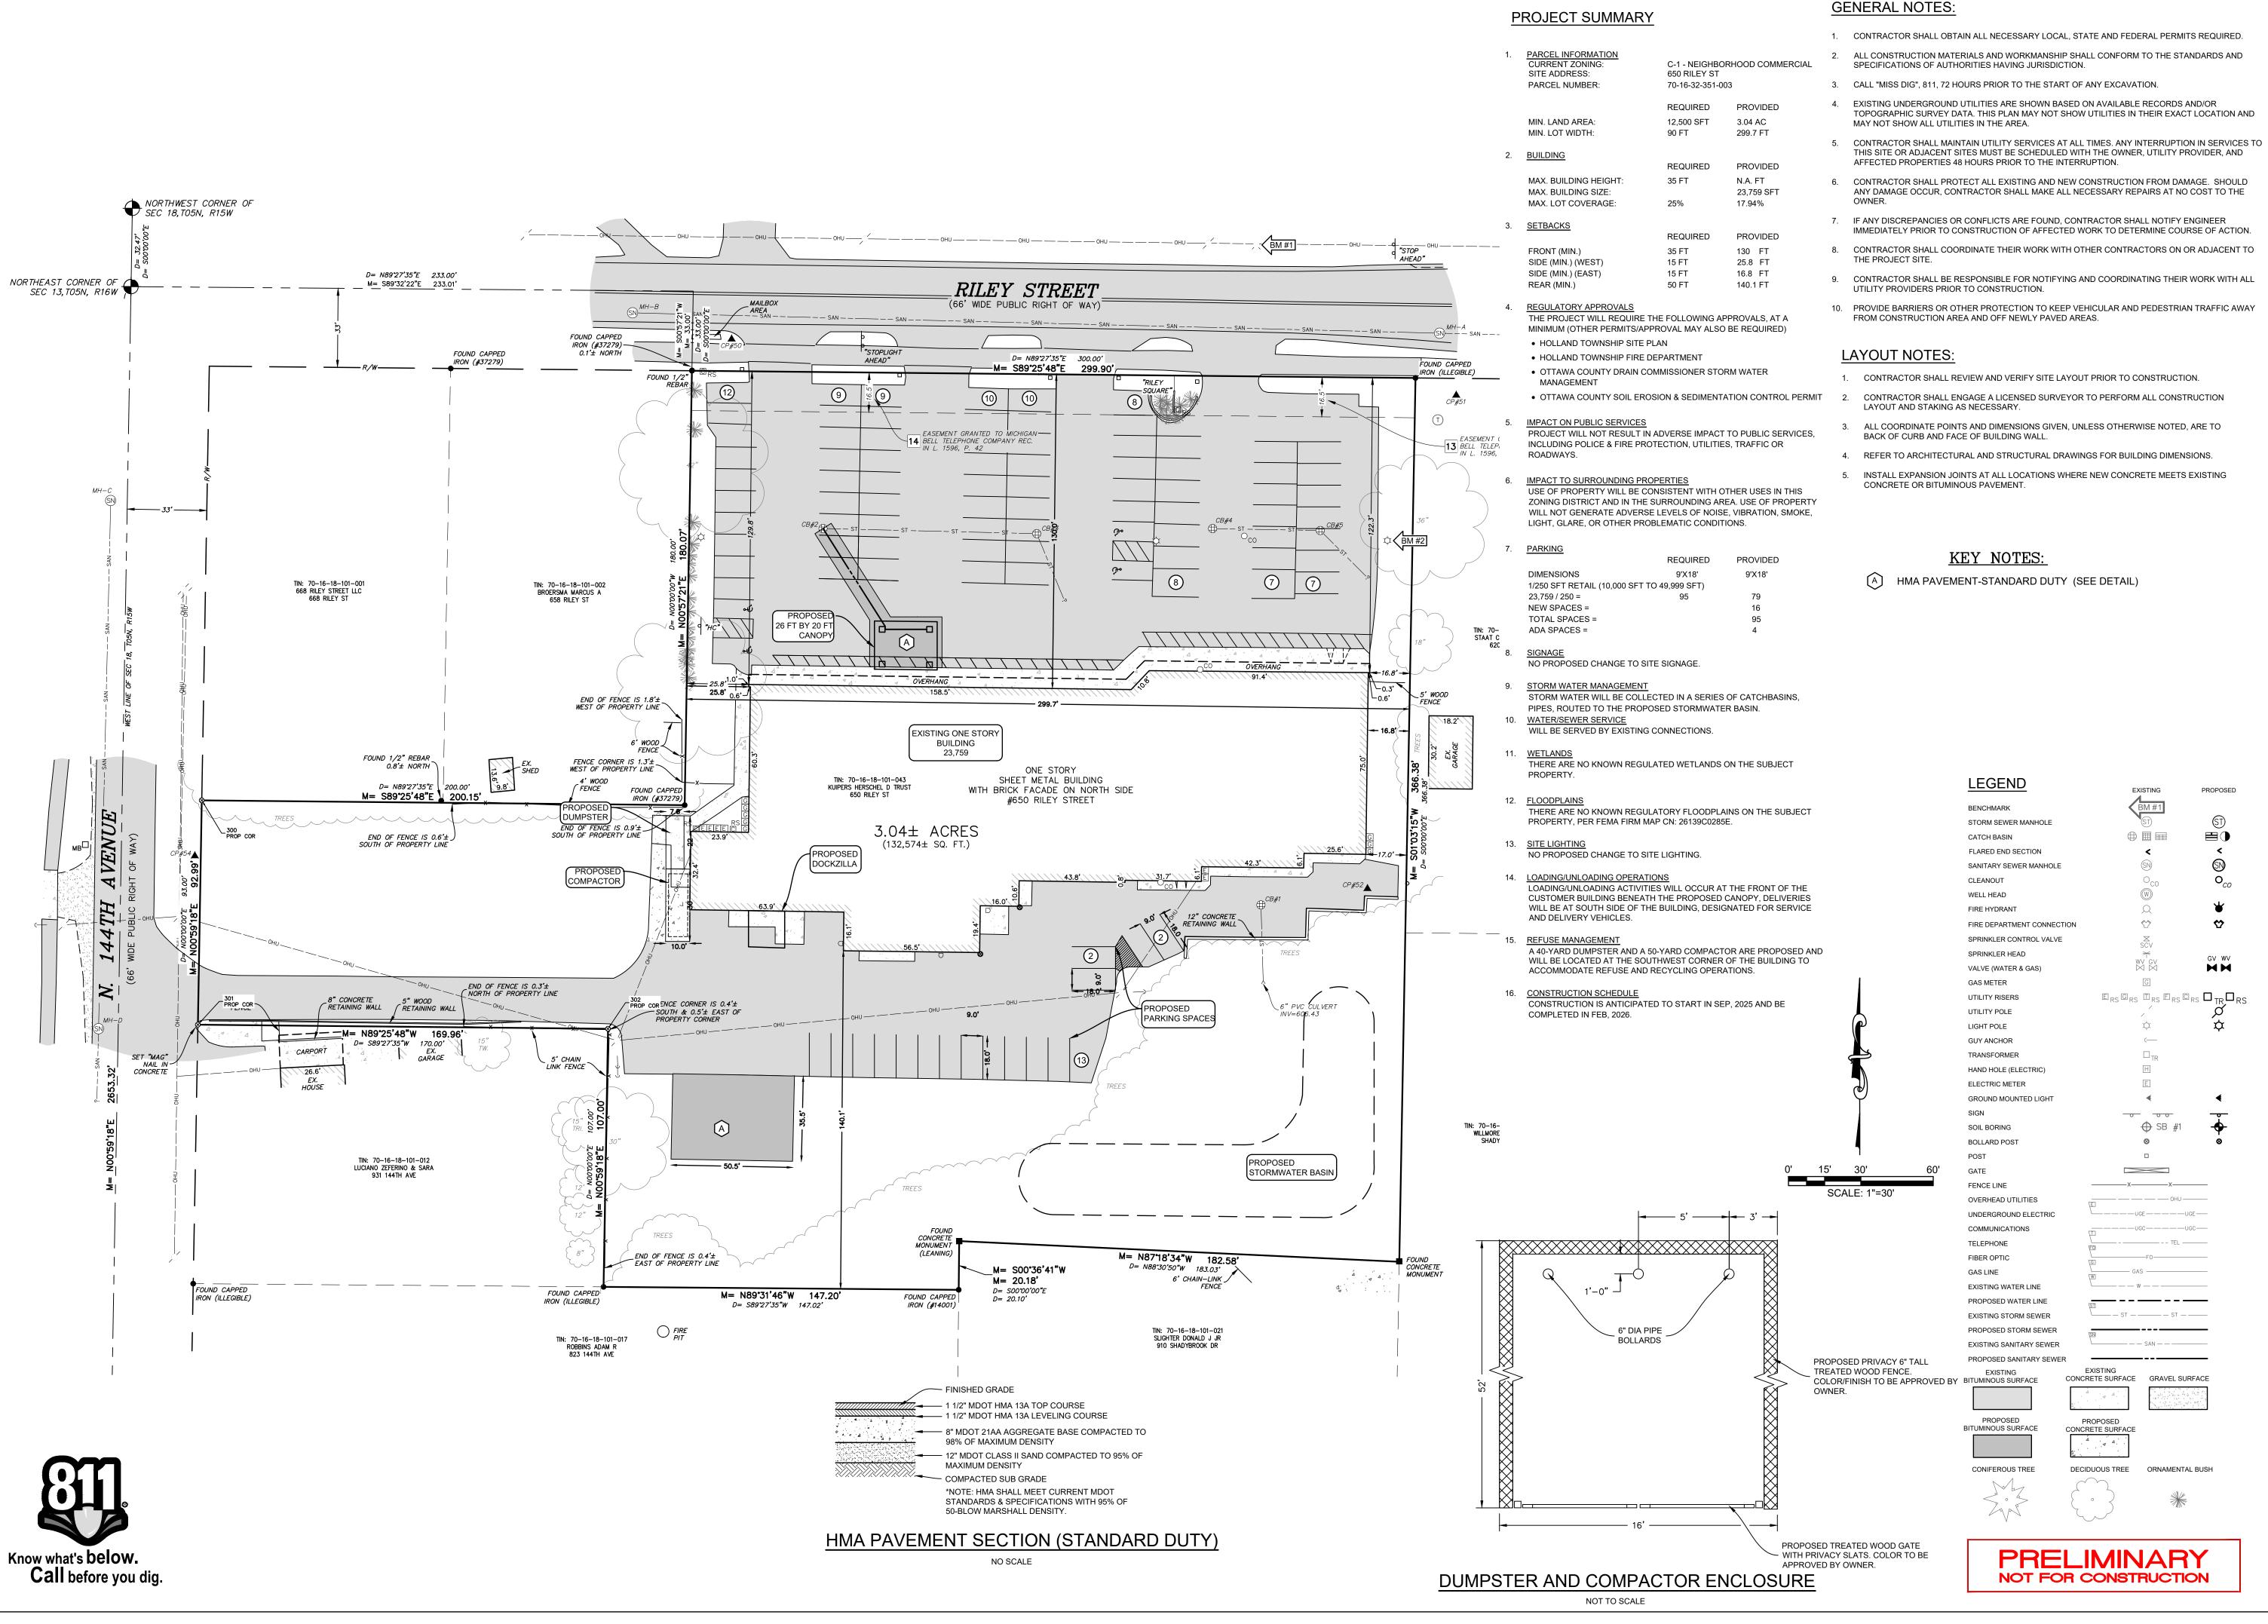
Project Manager:
JOHN TENPAS


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Sheet Title:

CIVIL DEMOLITION PLAN

CD-101



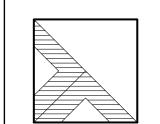

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734-368-9483

COMMUNITY ACTION HOUSE

650 RILEY STREET

18, T05N, R15W, HOLLAND CHARTER TWP., OTTAWA CO.

-FORLAKEWOOD ARCHITECTURE

11253 JAMES STREET, HOLLAND, MI 49424

ISSUED FOR:

1 OWNER REVIEW
06-11-2025 D: A.A C: JMT
2 OWNER REVIEW
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2 ISSUED FOR REVIEW
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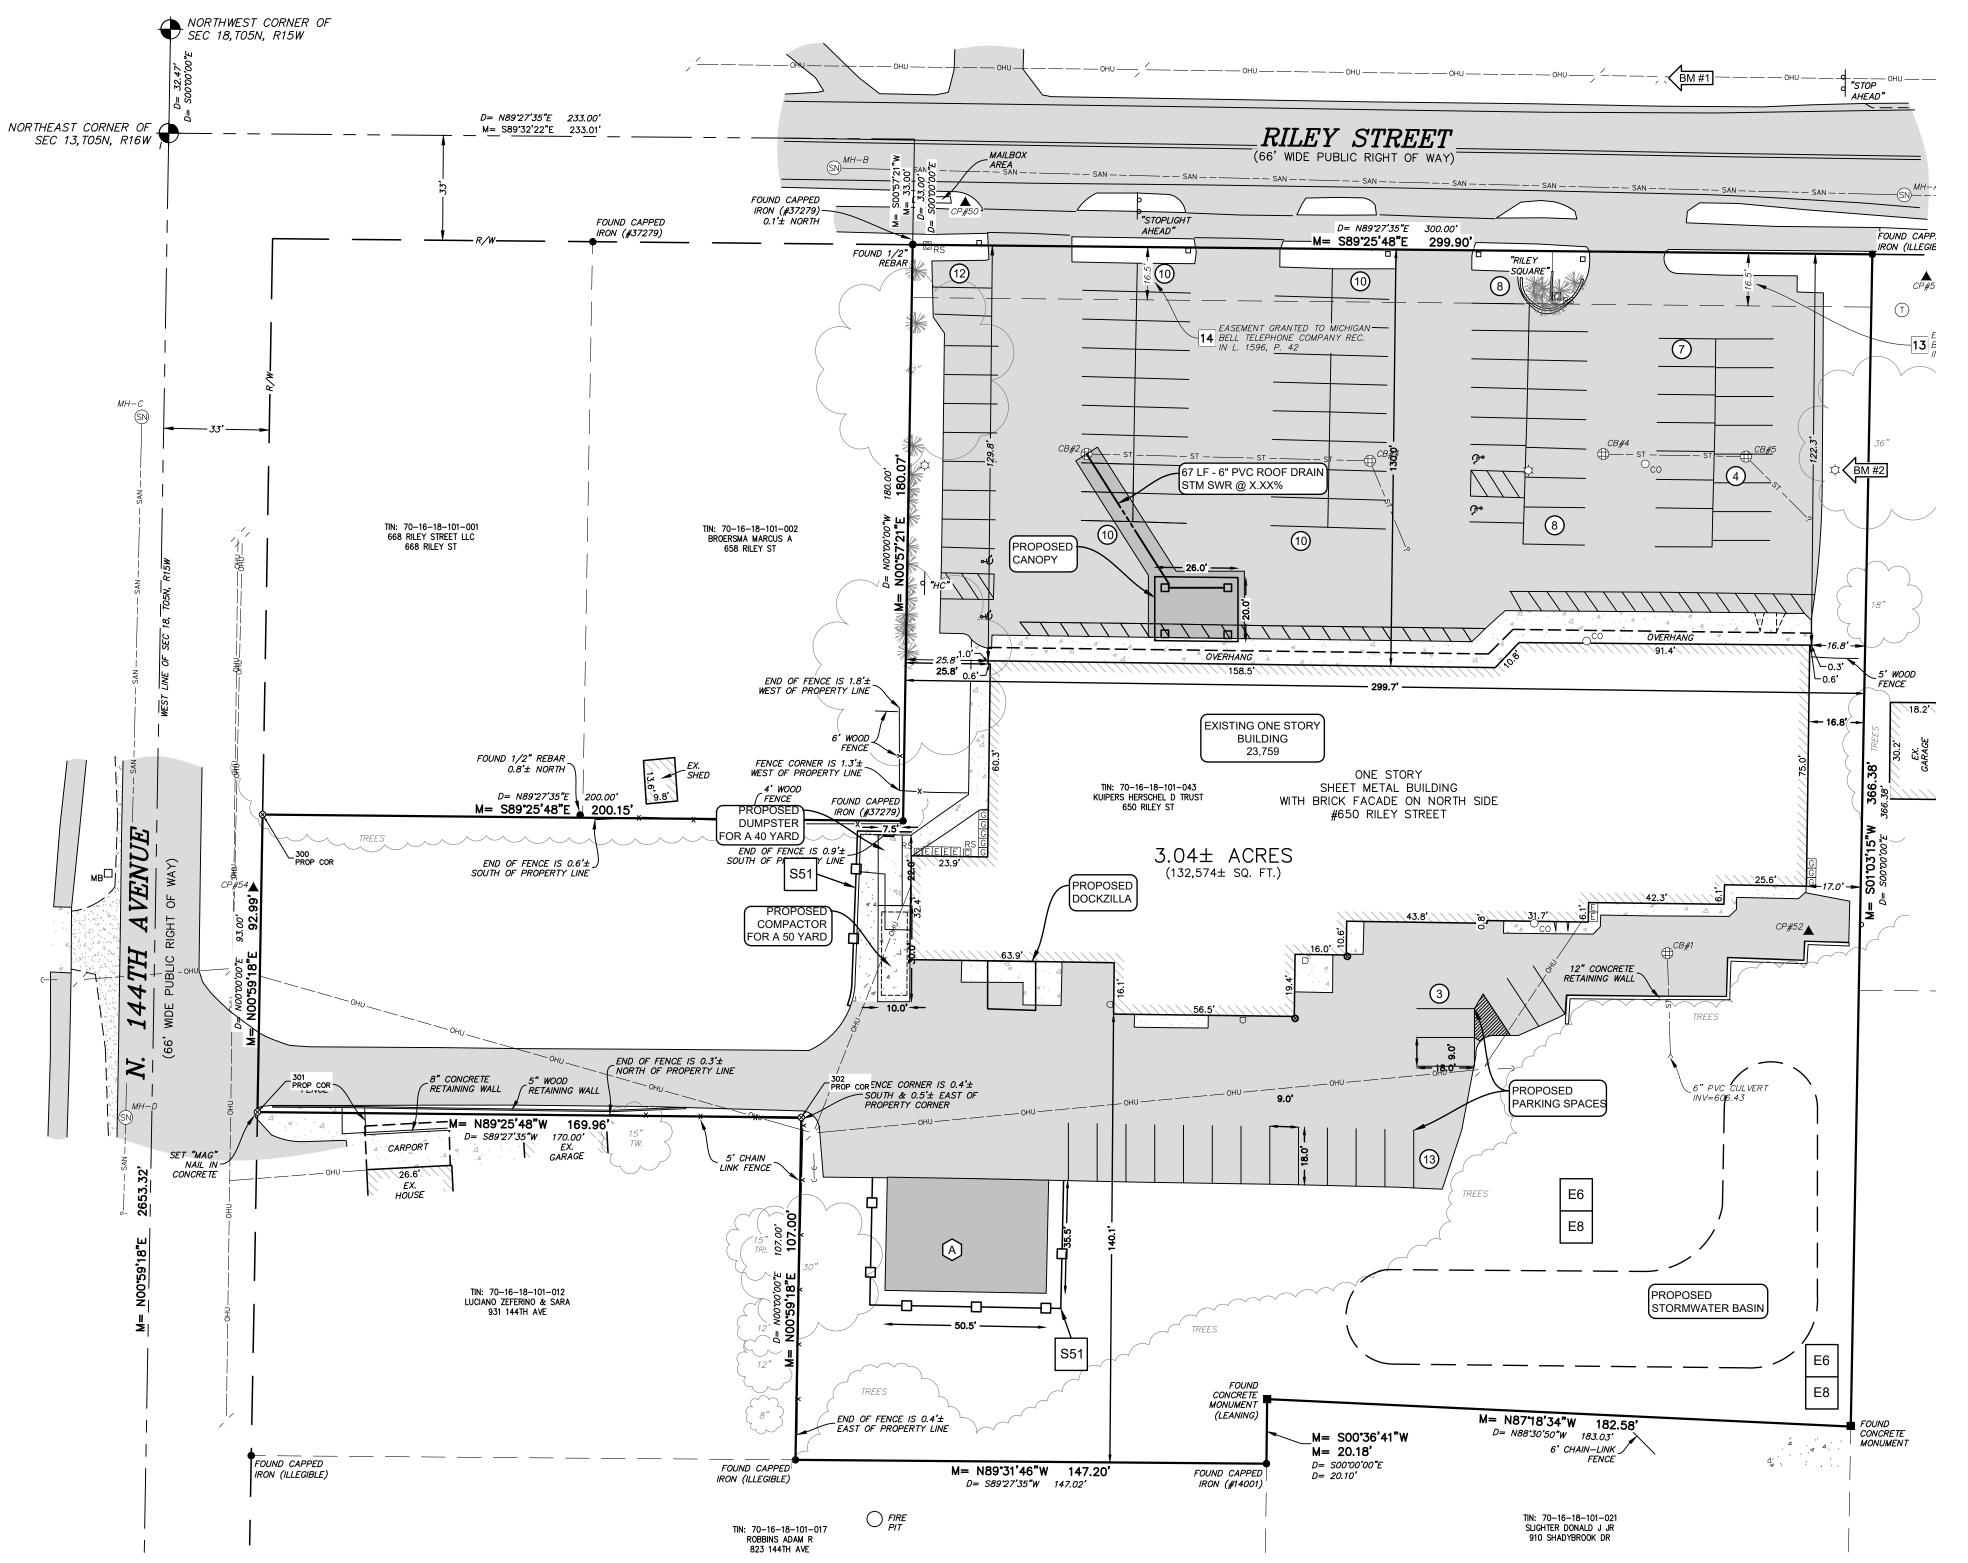
Project Manager:
JOHN TENPAS

Project #
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PLAN

C-101



# **UTILITY NOTES:**

- CONTRACTOR SHALL OBTAIN CONNECTION PERMIT PRIOR TO INSTALLATION OF ANY PRIVATE WATER, SANITARY, OR STORM CONNECTIONS TO PUBLIC MAIN.
- CONTRACTOR SHALL ENSURE ALL NECESSARY PERMITS ARE OBTAINED FOR ANY PROPOSED PUBLIC WATER MAIN, SANITARY SEWER, OR STORM SEWER. CONTRACTOR SHALL COORDINATE WITH MUNICIPALITY PRIOR TO CONSTRUCTION TO SCHEDULE PRE-CONSTRUCTION MEETING AND TO ENSURE COMPLIANCE WITH INSPECTION/TESTING REQUIREMENTS.
- REFER TO ARCHITECTURAL AND MECHANICAL DRAWINGS FOR EXACT UTILITY CONNECTION LOCATIONS AT BUILDING.
- 4. ALL SITE UTILITIES SHALL BE STUBBED AND PLUGGED TO WITHIN FIVE FEET OF THE OUTSIDE BUILDING FOUNDATION WALL UNLESS OTHERWISE NOTED.
- 5. CONTRACTOR SHALL DOCUMENT, AND FURNISH TO OWNER AND ENGINEER, WITNESS DIMENSIONS FOR ALL UTILITY STUBS AND CONDUITS INSTALLED.
- ALL UTILITY WORK SHALL BE COMPLETED, INCLUDING TRENCH BACKFILL AND COMPACTION, PRIOR TO PLACEMENT OF AGGREGATE BASE.

# SOIL EROSION & SEDIMENTATION CONTROL (SESC) NOTES:

- 1. CONTRACTOR SHALL BE RESPONSIBLE FOR OBTAINING AND COMPLYING WITH THE SESC PERMIT.
- 2. PLACE TEMPORARY SESC MEASURES AS INDICATED ON DRAWING PRIOR TO EARTH MOVING AND GRADING ACTIVITIES.
- INSPECT AND MAINTAIN ALL TEMPORARY SESC MEASURES AFTER STORM EVENTS AND AS NECESSARY TO ASSURE PROPER

CONTRACTOR SHALL AVOID THE UNNECESSARY DISTURBING OR REMOVING OF EXISTING VEGETATED TOPSOIL OR EARTH

- ALL SOIL STOCKPILES LEFT UNDISTURBED FOR MORE THAN 7 DAYS SHALL HAVE PERIMETER SILT FENCE. ALL SOIL STOCKPILES LEFT UNDISTURBED FOR MORE THAN 30 DAYS SHALL BE STABILIZED WITH TEMPORARY SEEDING.
- DISTURBED AREAS THAT WILL NOT BE BROUGHT TO FINAL GRADE AND PERMANENTLY STABILIZED WITHIN 30 DAYS SHALL BE STABILIZED WITH TEMPORARY SEEDING.
- TEMPORARY SEEDING SHALL CONSIST OF OATS AND/OR BARLEY AT AN APPLICATION RATE OF 2.0 LBS/1000 SFT MINIMUM APRIL 1 THROUGH AUGUST 31, OR ANNUAL RYEGRASS AT AN APPLICATION RATE OF NOT LESS THAN 2.0 LBS/1000 SFT AUGUST 1 THROUGH NOVEMBER 15. IRRIGATE IF NECESSARY TO ESTABLISH TEMPORARY COVER.
- TEMPORARY SESC MEASURES SHALL REMAIN IN PLACE UNTIL ALL PERMANENT SESC MEASURES ARE INSTALLED, AND VEGETATION IS UNIFORMLY ESTABLISHED. RE-GRADE, RE-SEED AND PLACE ADDITIONAL TOPSOIL IN ERODED AREAS AS NECESSARY UNTIL FINAL LANDSCAPING IS INSTALLED.
- CONSTRUCTION OF SEDIMENT BASINS AND DIVERSION DITCHES SHALL BE COMPLETED PRIOR TO SITE CLEARING AND GRADING.
- INSTALL INLET SEDIMENT TRAPS ("SILT SACK" OR EQUAL) IN ALL PROPOSED CATCHBASINS AS INDICATED ON THIS DRAWING. CLEAN INLET SEDIMENT TRAPS ON A WEEKLY BASIS AND AFTER RAIN EVENTS AS REQUIRED.
- 11. CONTRACTOR SHALL INSPECT AND CLEAN OUT ALL EXISTING AND PROPOSED STORM SEWER CATCHBASINS AND MANHOLES WITHIN THE PROJECT LIMITS, OR OUTSIDE THE PROJECT LIMITS IF SUBJECT TO CONSTRUCTION SITE RUNOFF, AS NECESSARY DURING CONSTRUCTION AND PRIOR TO FINAL ACCEPTANCE.
- PLACE SILT FENCE ALONG DISTURBED AREAS WHERE SURFACE WATER WILL FLOW INTO EXISTING SWALES, DITCHES AND ADJACENT PROPERTIES. ANCHOR SILT FENCE TO PREVENT UNCONTROLLED RELEASE OF SILT LADEN WATER.
- 13. THE CONTRACTOR IS RESPONSIBLE FOR THE DAILY SWEEPING OF TRACKED MATERIALS FROM ALL ROADWAYS.
- 14. THE SESC MEASURES SHOWN ON THIS PLAN ARE THE MINIMUM MEASURES REQUIRED. DUE TO SITE ACTIVITIES AND SCHEDULES, ADDITIONAL MEASURES WILL LIKELY BE REQUIRED TO MAINTAIN SITE ACCORDING TO APPLICABLE STATE AND FEDERAL GUIDELINES AT NO ADDITIONAL COST TO THE OWNER.
- 15. ONCE SITE IS STABILIZED, ALL TEMPORARY SESC MEASURES SHALL BE REMOVED.

# CONTINUED MAINTENANCE OF PERMANENT SESC MEASURES:

PROPERTY OWNER SHALL BE RESPONSIBLE TO MAINTAIN PERMANENT SESC MEASURES

# REPAIR CRACKED OR DAMAGE PAVEMENT AS NEEDED.

NSPECT NEWLY SEEDED AREAS SUBSEQUENT TO ANTICIPATED GERMINATION DATE AND AFTER EACH SIGNIFICANT RAINFALL EVENT THAT PRODUCES RUNOFF UNTIL AREAS ARE STABILIZED.

REPAIR ERODED AREAS, APPLYING SUPPLEMENTAL SEED, MULCH AND WATER AS NEEDED.

IF SEED DOES NOT ESTABLISH, CONDUCT SOIL TESTS, AMEND SOILS AS NEEDED, AND REAPPLY SEED AND/OR MULCH DURING THE RECOMMENDED GROWING SEASON.

TO ASSIST IN THE ESTABLISHMENT OF NATIVE SPECIES REMOVE UNWANTED COMPETING VEGETATION IN THE FIRST YEAR. MOWING CAN BE USED PERIODICALLY TO DISCOURAGE WEEDS.

# SESC SITE SUMMARY:

- NATIVE SITE SOIL IS CLASSIFIED AS SAND PER USDA WEB SOIL SURVEY OR
- WETLANDS THERE ARE NO KNOWN REGULATED WETLANDS ON THE SUBJECT PROPERTY.
- FLOODPLAINS THERE ARE NO KNOWN REGULATORY FLOODPLAINS ON THE SUBJECT
- PROPERTY, PER FEMA FIRM MAP CN: 26139C0285E.
- 4. AREA OF DISTURBANCE: 0.42 ACRES

# **LEGEND**

xxx.xx FINISH GRADE ELEVATION

MG XXX.XX± MATCH EXISTING GRADE ELEVATION

TC XXX.XX X FINISH GRADE ELEVATION AT BACK OF CURB FINISH GRADE ELEVATION AT FLOW LINE

TW XXX.XX± FINISH GRADE ELEVATION AT TOP OF WALL

BW XXX.XX± FINISH GRADE ELEVATION AT BOTTOM OF WALL AT GROUND

----- PROPOSED SWALE

----- PROPOSED MAJOR CONTOUR

— — PROPOSED MINOR CONTOUR ---- EXISTING MAJOR CONTOUR

--- EXISTING MINOR CONTOUR 627.00 MINIMUM OPENING ELEV. (M.O.E.)

623.60 MINIMUM BASEMENT ELEV. (M.B.E.)

|                                  | OPE | RATI | ON TII | ME SC | CHEDU | JLE - : | SEP 2 | 025 - F | EB 20 | )2 |
|----------------------------------|-----|------|--------|-------|-------|---------|-------|---------|-------|----|
| CONSTRUCTION SEQUENCE            | AUG | SEP  | OCT    | NOV   | DEC   | JAN     | FEB   | MAR     | APR   | M  |
| TE CLEARING AND INSTALL CONTROLS |     |      |        |       |       |         |       |         |       |    |
| OUGH GRADE SITE                  |     |      |        |       |       |         |       |         |       |    |
| STALL UTILITIES                  |     |      |        |       |       |         |       |         |       |    |
| ILDING CONSTRUCTION              |     |      |        |       |       |         |       |         |       |    |
| NAL GRADING                      |     |      |        |       |       |         |       |         |       |    |
| VING                             |     |      |        |       |       |         |       |         |       | Г  |



EXISTING WATER LINE

PROPOSED WATER LINE

EXISTING STORM SEWER

PROPOSED STORM SEWER

EXISTING SANITARY SEWER


BITUMINOUS SURFACE

PROPOSED

BITUMINOUS SURFACE

CONIFEROUS TREE

PROPOSED SANITARY SEWER

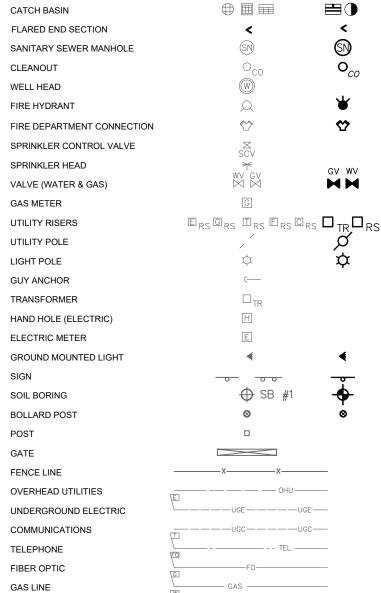

SCALE: 1"=30'

CONCRETE SURFACE A A A DECIDUOUS TREE ORNAMENTAL BUSH

\_\_\_\_\_

CONCRETE SURFACE GRAVEL SURFACE

PROPOSED

NOT FOR CONSTRUCTION

5 of 6

USE ADJACENT TO CRITICAL AREAS, TO PREVENT SEDIMENT SILT FENCE LADEN SHEET FLOW FROM ENTERING THESE AREAS. FOR USE IN AREAS SUBJECT TO EROSIVE SURFACE FLOWS OR SEVERE WIND OR ON NEWLY SEEDED AREAS MULCH STABILIZATION METHOD UTILIZED ON SITES WHERE EARTH CHANGE HAS BEEN COMPLETED (FINAL GRADING ATTAINED). PERMANENT SEEDING



616-249-3800 Kalamazoo, MI 269-544-1455 Lansing, MI 517-889-6210 Ypsilanti, MI 734-368-9483

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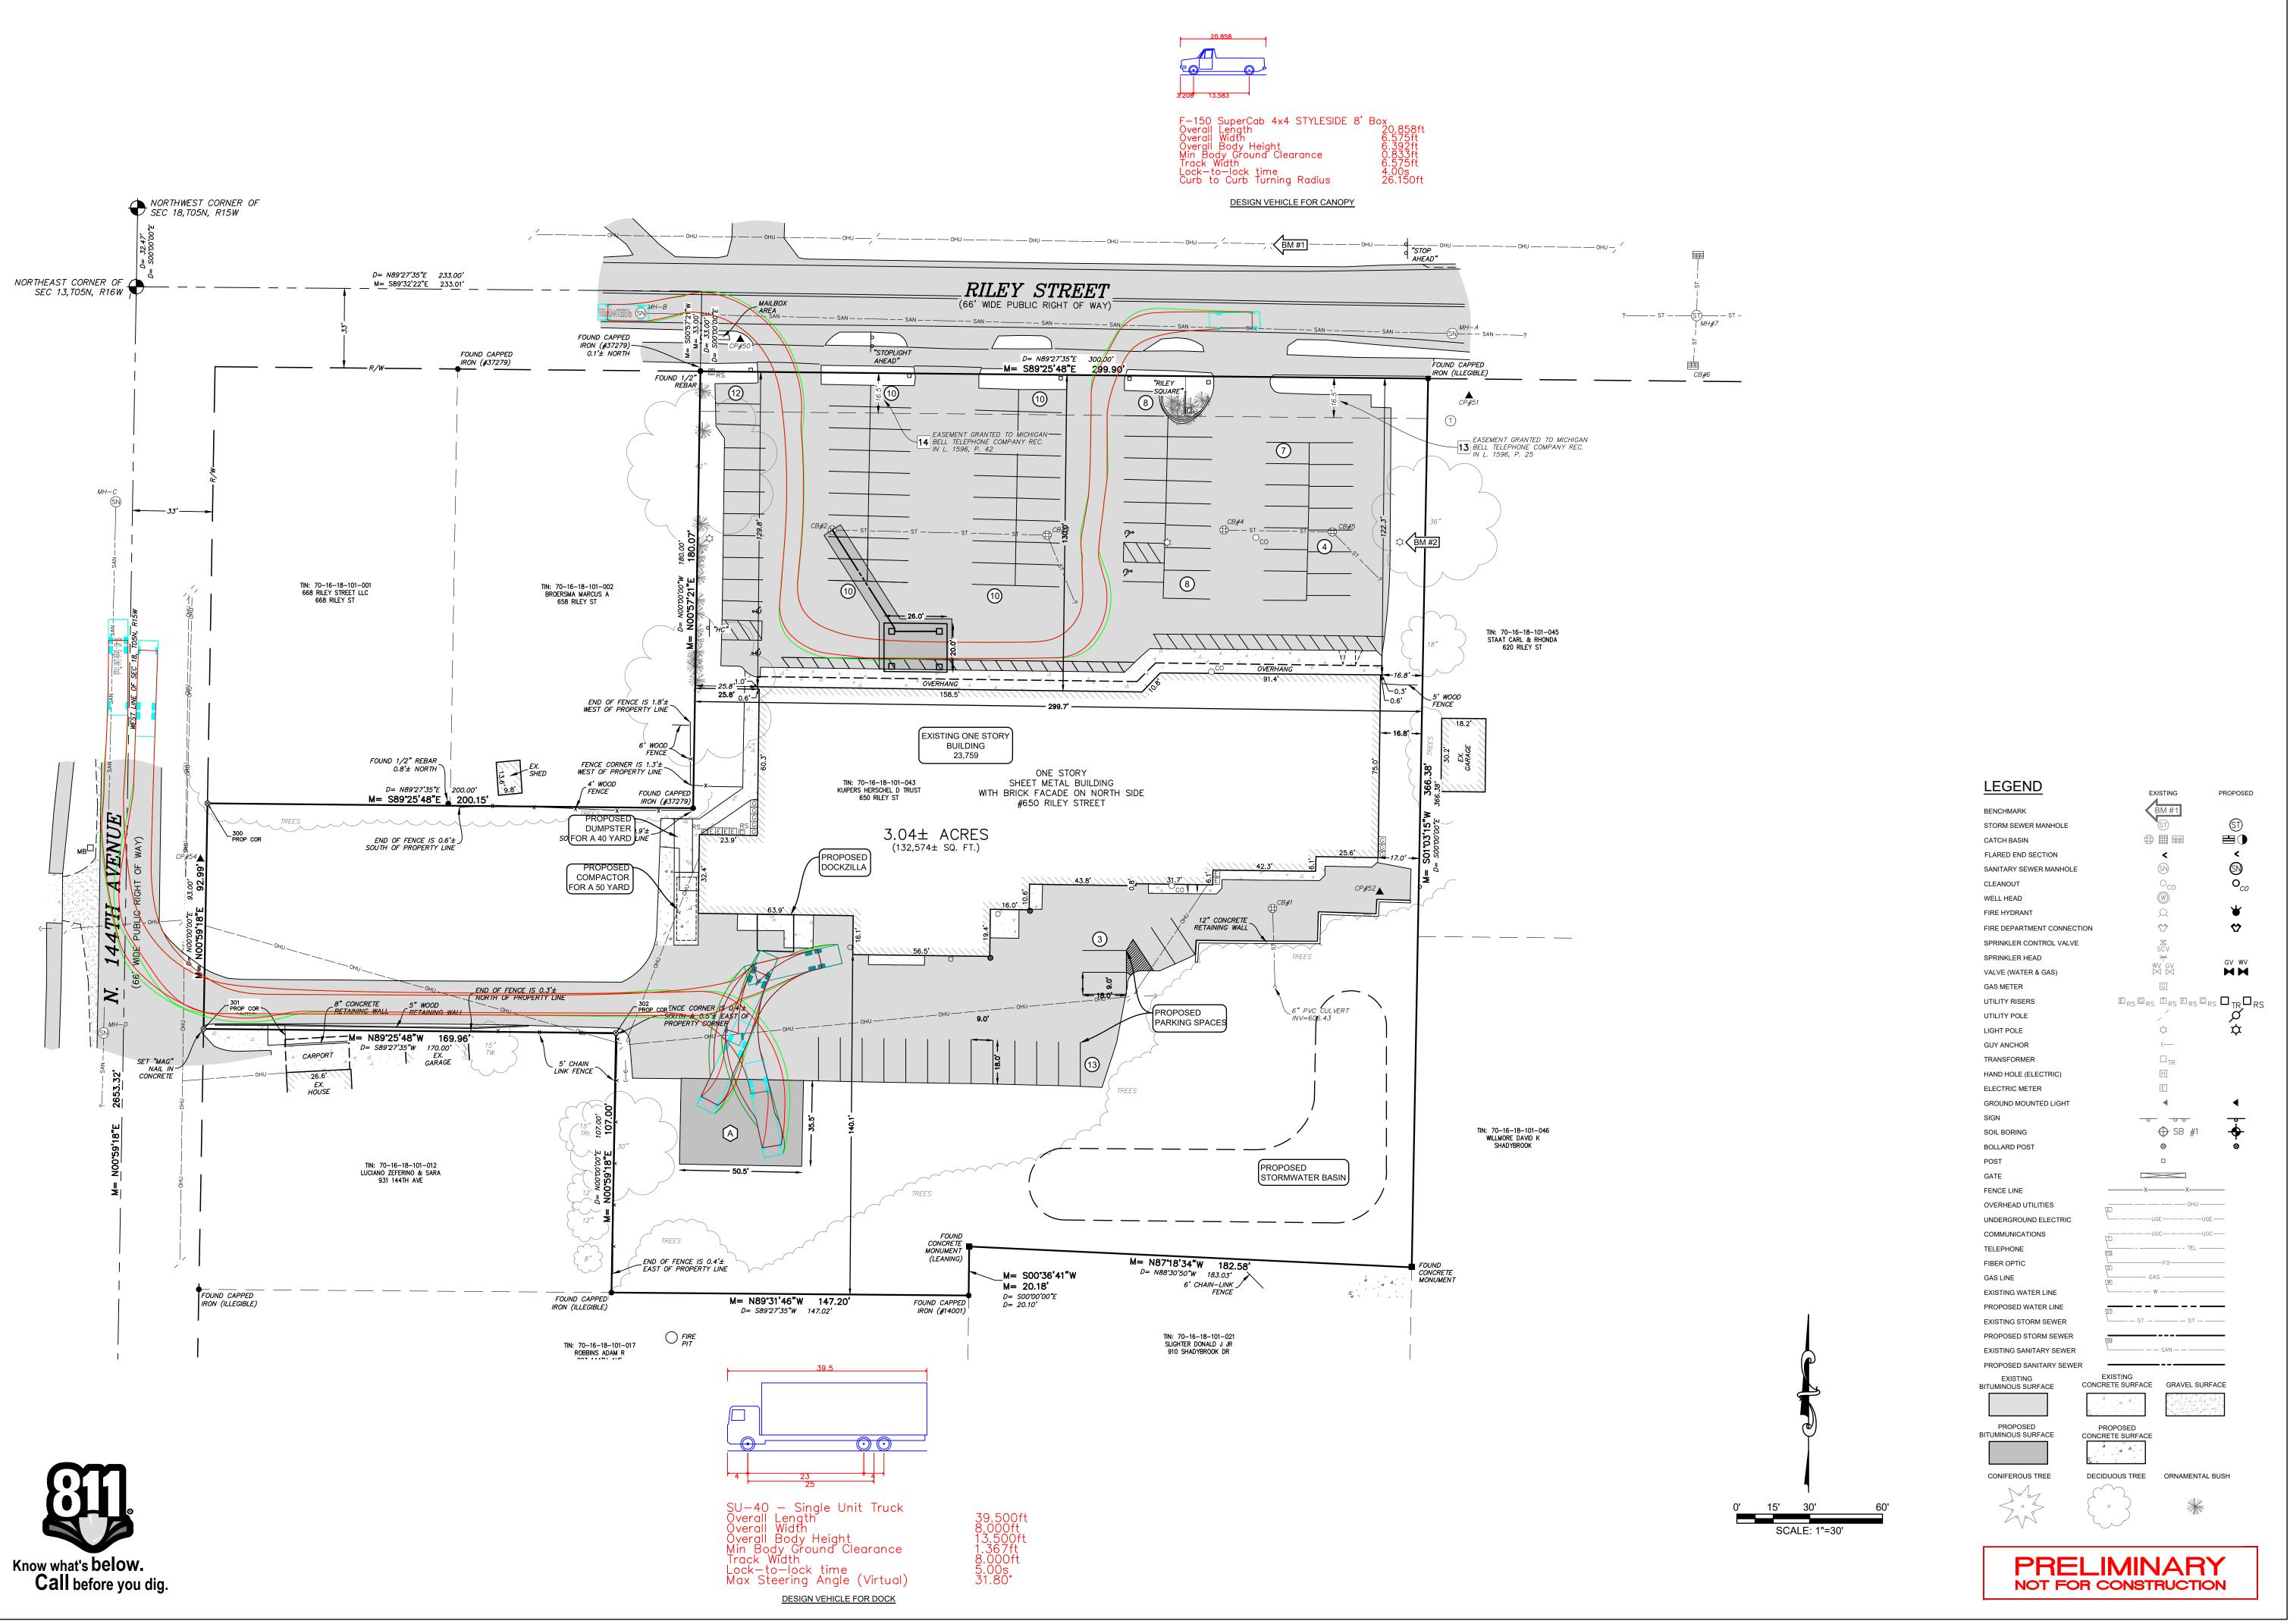
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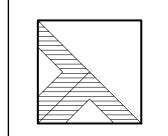
ISSUED FOR:

Project Manager: JOHN TENPAS 2510195.1A Sheet Title:

**GRADING AND** SOIL EROSION CONTROL PLAN







DRIESENGA & ASSOCIATES, INC.

Engineering Surveying Testing

Holland, MI 616-396-0255 Grand Rapids, MI 616-249-3800 Kalamazoo, MI 269-544-1455 Lansing, MI 517-889-6210 Ypsilanti, MI

MP., OTTAWA CO.

COMMUNITY ACTION HOUSE
650 RILEY STREET
650 RILEY STREET
-FOR-FOR-TOSN, R15W, HOLLAND CHARTER TWP., OTT
-FOR-TOKE WOOD ARCHITECTURE
11253 JAMES STREET, HOLLAND, MI 49424

ISSUED FOR:

1 OWNER REVIEW
06-11-2025 D: A.A C: JMT

2 OWNER REVIEW
06-26-2025 D: A.A C: JMT

2 ISSUED FOR REVIEW
07-15-2025 D: A.A C: JMT

Project Manager:
JOHN TENPAS
Project #
2510195.1A

Sheet Title:

EXHIBIT

VEHICLE

TRACKING

EX-VT
6 of 6

ALL GENERAL METAL STUD FRAMING TO BE 16" O.C. UNLESS NOTED OTHERWISE. HEIGHT OF ALL METAL STUD AND GYPSUM BOARD WALLS TO BE TIGHT TO BOTTOM OF STRUCTURAL STEEL MEMBERS, OR METAL ROOF / FLOOR DECK U.N.O.

ALL DIMENSIONS ARE TO GRIDS, FINISH FACE OF DRYWALL OR FACE OF FOUNDATION AT EXTERIOR WALLS.

EXACT LOCATION OF CABINET AND BRACKET MOUNTED FIRE EXTINGUISHERS TO BE

APPROVED BY LOCAL FIRE OFFICIAL. PROVIDE IMPACT RESISTANT GYPSUM BOARD ON THE BOTTOM 4'-0" OF WALL AT

CORRIDORS - REFER TO PLAN FOR LOCATIONS PROVIDE MOISTURE RESISTANT GYPSUM BOARD BEHIND WETWALLS

PROVIDE TYPICAL CONTROL JOINTS IN ALL GYPSUM BOARD BULKHEADS AT 30'-0" MAX.

DOORS ADJACENT TO WALLS BUT NOT DIMENSIONED ARE LOCATED 4" FROM FACE OF ADJACENT WALL.

TRANSITION LINES OF DIFFERING FLOOR MATERIALS SHALL OCCUR AT CENTERLINE OF CLOSED DOOR.

CONTRACTOR SHALL FURNISH AND INSTALL OCCUPANT LOAD SIGNS AS REQUIRED BY THE BUILDING CODE. SIGNS SHALL BE POSTED AT REQUIRED LOCATIONS BEFORE SUBSTANTIAL COMPLETION.

PROVIDE SOLID BLOCKING IN STUD WALLS TO ANCHOR HANDRAILS, WHITEBOARDS, TV MONITORS, ACCESSORIES, ETC.

**LAKEWOOD** ARCHITECTURE



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**LY ACTION HOUSE** 

COMMUNI

RILEY STREET 650 RILEY STR

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**REVISIONS:** 



CONSTRUCTION FOR

XXXXX AM REVIEWED BY: SK SHEET NAME:

OVERALL FLOOR

ENLARGED FLOOR PLAN - AREA A

FLOOR PLAN NOTES

 1 ALL GENERAL METAL STUD FRAMING TO BE 16" O.C. UNLESS NOTED OTHERWISE.
 2 HEIGHT OF ALL METAL STUD AND GYPSUM BOARD WALLS TO BE TIGHT TO BOTTOM OF STRUCTURAL STEEL MEMBERS, OR METAL ROOF / FLOOR DECK U.N.O.

3 ALL DIMENSIONS ARE TO GRIDS, FINISH FACE OF DRYWALL OR FACE OF FOUNDATION AT EXTERIOR WALLS.

4 EXACT LOCATION OF CABINET AND BRACKET MOUNTED FIRE EXTINGUISHERS TO BE

APPROVED BY LOCAL FIRE OFFICIAL.

5 PROVIDE IMPACT RESISTANT GYPSUM BOARD ON THE BOTTOM 4'-0" OF WALL AT CORRIDORS - REFER TO PLAN FOR LOCATIONS

6 PROVIDE MOISTURE RESISTANT GYPSUM BOARD BEHIND WETWALLS
7 PROVIDE TYPICAL CONTROL JOINTS IN ALL GYPSUM BOARD BULKHEADS AT 30'-0" MAX.

8 DOORS ADJACENT TO WALLS BUT NOT DIMENSIONED ARE LOCATED 4" FROM FACE OF ADJACENT WALL.

9 TRANSITION LINES OF DIFFERING FLOOR MATERIALS SHALL OCCUR AT CENTERLINE OF CLOSED DOOR.

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PROVIDE SOLID BLOCKING IN STUD WALLS TO ANCHOR HANDRAILS, WHITEBOARDS, TV MONITORS, ACCESSORIES, ETC.

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REVISIONS:

No. Description D. SITE PLAN APPROVAL 07.15.2

FOR CONSTRUCTION

PROJECT NO:

XXXXX

DRAWN BY:

AM


REVIEWED BY:

SK

REVIEWED BY:
SK
SHEET NAME:
ENLARGED FLOOR
PLAN - AREA A

A112

PLAN A PLAN B

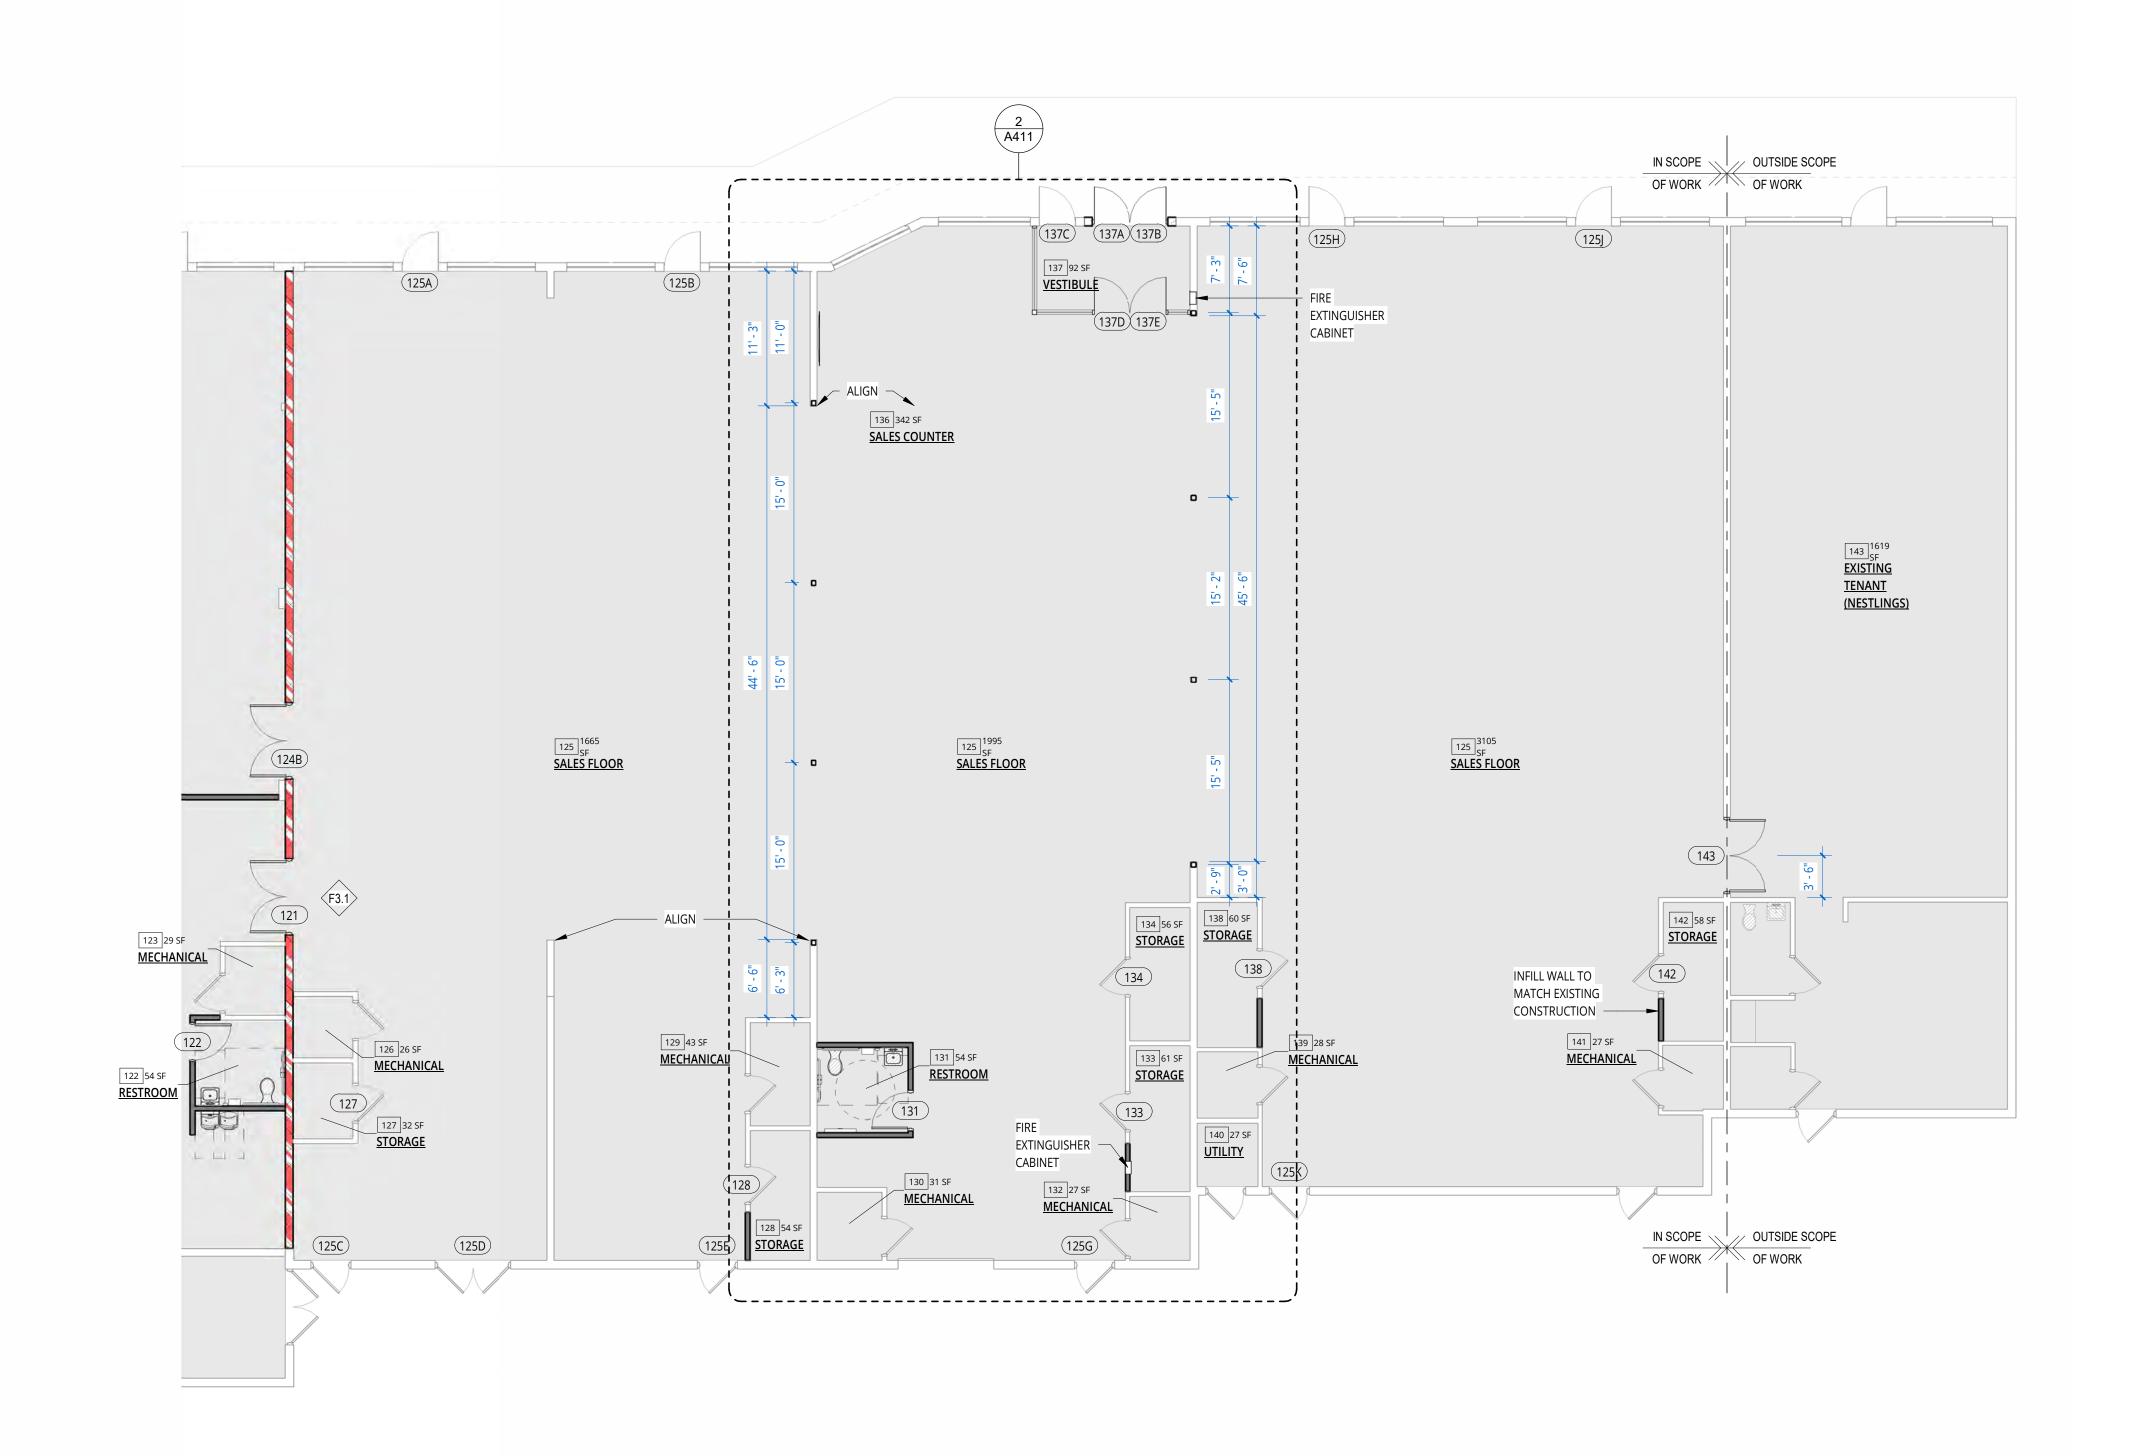

OVERALL FLOOR PLAN

# FLOOR PLAN NOTES

- ALL GENERAL METAL STUD FRAMING TO BE 16" O.C. UNLESS NOTED OTHERWISE.
- HEIGHT OF ALL METAL STUD AND GYPSUM BOARD WALLS TO BE TIGHT TO BOTTOM OF STRUCTURAL STEEL MEMBERS, OR METAL ROOF / FLOOR DECK U.N.O.
- ALL DIMENSIONS ARE TO GRIDS, FINISH FACE OF DRYWALL OR FACE OF FOUNDATION AT EXTERIOR WALLS.
- EXACT LOCATION OF CABINET AND BRACKET MOUNTED FIRE EXTINGUISHERS TO BE APPROVED BY LOCAL FIRE OFFICIAL.
- PROVIDE IMPACT RESISTANT GYPSUM BOARD ON THE BOTTOM 4'-0" OF WALL AT CORRIDORS - REFER TO PLAN FOR LOCATIONS
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- CLOSED DOOR. CONTRACTOR SHALL FURNISH AND INSTALL OCCUPANT LOAD SIGNS AS REQUIRED BY THI BUILDING CODE. SIGNS SHALL BE POSTED AT REQUIRED LOCATIONS BEFORE SUBSTANTIAL COMPLETION.
- PROVIDE SOLID BLOCKING IN STUD WALLS TO ANCHOR HANDRAILS, WHITEBOARDS, TV MONITORS, ACCESSORIES, ETC.





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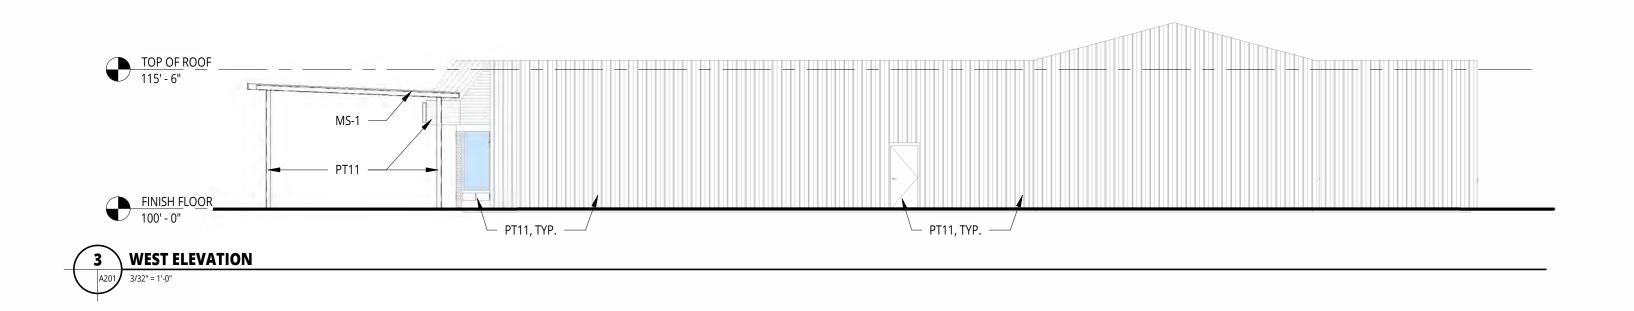
**REVISIONS:** 

CONSTRUCTION XXXXX AM REVIEWED BY: FOR

SHEET NAME:

**ENLARGED FLOOR** PLAN - AREA B

PLAN A PLAN B



# **ELEVATION NOTES**

SUBCONTRATOR TO FIELD VERIFY BUILDING HEIGHTS AND ENVELOPE LIMITS. INFORM ARCHITECT OF ANY DISCREPANCIES.

ALL EXPOSED MECHANICAL AND PLUMBING VENT LOCATIONS TO BE APPROVED BY

INFORMATION.

4 ALL SIGNAGE BY OWNER

| TAG           | DESCRIPTION                    | SPEC<br>SECTION      | MANUFACTURER                  | FINISH / COLOR                  |
|---------------|--------------------------------|----------------------|-------------------------------|---------------------------------|
| STOREFR       | ONT                            |                      |                               |                                 |
| SF-1          | ALUMINUM<br>STOREFRONT WINDOWS | 08 51 13             | AS SELECTED BY CONTRACTOR     | CLEAR ANODIZED - MATCH EXISTING |
|               |                                |                      |                               |                                 |
| PAINT         |                                |                      |                               |                                 |
|               | WHITE PAINT                    | 09 91 13             | BENJAMIN MOORE                | TBD                             |
| PAINT<br>PT10 |                                |                      | -                             | 11-1-                           |
| PT10<br>PT11  | GREY PAINT                     | 09 91 13<br>09 91 13 | BENJAMIN MOORE BENJAMIN MOORE | TBD<br>TBD                      |
| PT10          | GREY PAINT                     |                      | -                             | 1.00                            |
| PT10<br>PT11  | GREY PAINT                     |                      | -                             | 1.00                            |





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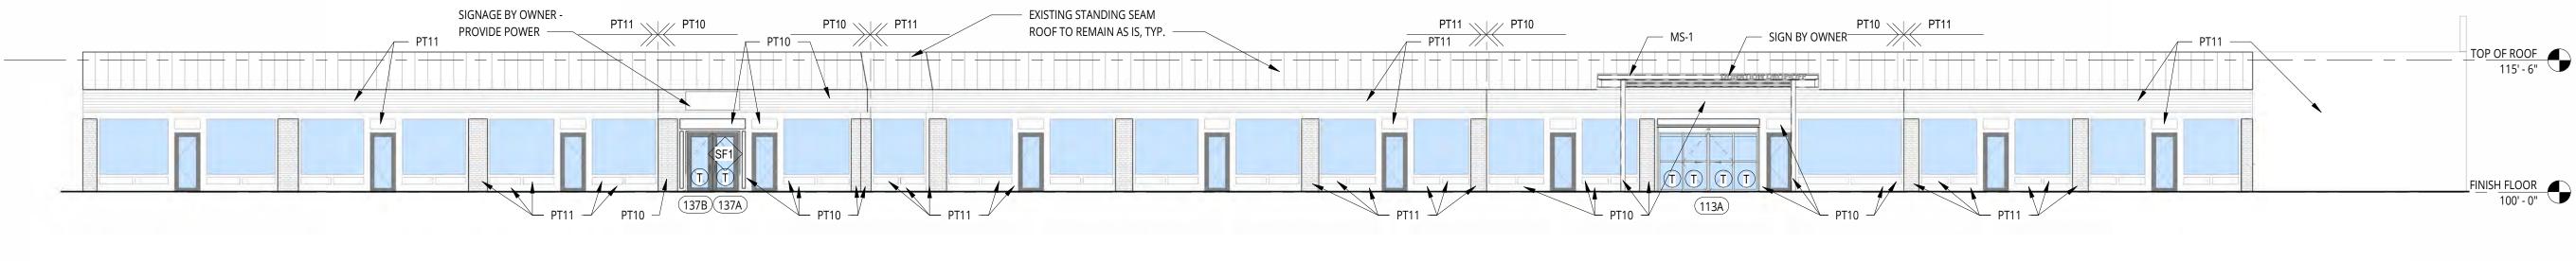
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**REVISIONS:** 

CONSTRUCTION XXXXX DRAWN BY: REVIEWED BY: SK SHEET NAME: **EXTERIOR** 

FOR

**ELEVATIONS** 



1 NORTH ELEVATION
| A201 | 3/32" = 1'-0"

| TOP OF ROOF<br>115' - 6" |                                    |                              |                                    |              |
|--------------------------|------------------------------------|------------------------------|------------------------------------|--------------|
|                          |                                    |                              |                                    |              |
| FINISH FLOOR             | PT11, TYP. EXISTING OVERHEAD DOORS | PT11, TYP. EXISTING OVERHEAD | EXISTING OVERHEAD DOORS PT11, TYP. | PT11, TYP. — |
| SOUTH ELEVATION          | TO REMAIN AS IS, TYP.              | TO REMAIN AS IS, TY          | TO REMAIN AS IS, TYP.              |              |